# ANHC **ALASKA NATIVE HERITAGE CENTER** REMODEL

# 8800 Heritage Center Drive, Anchorage, Alaska **BID CONSTRUCTION DOCUMENTS**

RENDERING



## 10.15.2023 EDA AWARD NUMBER: 07-79-07924ED

GENEF G001 G002	RAL COVER SHEET ABBREVIATIONS AN
G002	ASSEMBLIES
ARCHI D100	TECTURAL DEMOLITIC
D100	OVERALL REFLECTE DEMOLITION
ARCHI	TECTURAL
	OVERALL FLOOR PL
A102	FLOOR PLAN - AREA
A103	FLOOR PLAN - AREA
A104 A105	REFLECTED CEILING
A105 A201	INTERIOR ELEVATIO
7201	GALLERY 1
A202	INTERIOR ELEVATIO GALLERY 2
A203	INTERIOR ELEVATIO GALLERY 3
A204	INTERIOR ELEVATIO GALLERY 4
A205	INTERIOR ELEVATIO GALLERY 5
A206	INTERIOR ELEVATIO
A301	BUILDING SECTIONS
A401	ENLARGED PLANS
A402	AUDITORIUM STAIRS
A501	INTERIOR DETAILS
A601	SCHEDULES
A602	SIGNAGE
MECH	ANICAL DEMOLITION
MD102	MECHANICAL DEMO
	AREA B
1.	REMOVAL OF UPP
2.	WOOD CEILING IN
3.	THEATRE FINISHE
4.	STAIRCASE
5.	ADDED SIGNAGE
6	



	IN	IDEX OF DRAWINGS
- OVER SHEET BBREVIATIONS AND GENERAL NOTES SSEMBLIES CTURAL DEMOLITION OVERALL FLOOR PLAN - DEMOLITION OVERALL FLOOR PLAN - DEMOLITION OVERALL REFLECTED CEILING PLAN - MOLITION CTURAL OVERALL FLOOR PLAN LOOR PLAN - AREA A LOOR PLAN - AREA A SEFLECTED CEILING PLAN - AREA B NTERIOR ELEVATIONS - IDENTITY GALLERY 1 NTERIOR ELEVATIONS - IDENTITY GALLERY 3 NTERIOR ELEVATIONS - IDENTITY GALLERY 4 NTERIOR ELEVATIONS - IDENTITY	MD103 MECHA M-001 M-102 M-103 M-501 ELECTH ED101	MECHANICAL DEMOLITION FLOOR PLAN - FAN ROOM NICAL MECHANICAL LEGEND AND ABBREVIATIONS MECHANICAL FLOOR PLAN - AREA B ENLARGED MECHANICAL PLAN - FAN ROOM DIAGRAMS, DETAILS, AND SCHEDULES RICAL DEMOLITION ELECTRICAL DEMOLITION FLOOR PLAN - AREA A ELECTRICAL DEMOLITION FLOOR PLAN - AREA B
ATERIOR ELEVATIONS - IDENTITY GALLERY 5 INTERIOR ELEVATIONS - LOBBY UILDING SECTIONS NLARGED PLANS UDITORIUM STAIRS - ALT 4 INTERIOR DETAILS CHEDULES IGNAGE ICAL DEMOLITION IECHANICAL DEMOLITION FLOOR PLAN - REA B	E-202 E-203 E-501 E-601	POWER AND SIGNAL FLOOR PLAN - AREA B POWER FLOOR PLAN - MECHANICAL ROOM DIMMING SYSTEM DIAGRAM AND SCHEDULE SCHEDULES SCHEDULES
REMOVAL OF UPPER WINDOWS IN IDENTIT WOOD CEILING IN EXHIBITION SPACE THEATRE FINISHES: CARPET PAINT STAIRCASE ADDED SIGNAGE REPLACEMENT OF STAGE LIGHTING REPLACEMENT OF HUMIDIFIER TO HAVE T	-	

## **PROJECT TEAM**





421 W. 1<sup>st</sup> Avenue, Suite 300 Anchorage, Alaska 99501 907.563.8474 > exploredesign.com

F O R: • SUBMITTAL PRICING




SHEET NO. G001

#### ST.

(E)	EXISTING	COORD	COORDINATE	FLR	FLOOR	LAM	LAMINATED	PCT		STL	STEEL
ACOUST	ACOUSTICAL	CPT	CARPET	FOC	FACE OF CONCRETE	LAV	LAVATORY	DEDE	TILE	STOR	STORAGE
ACT	ACOUSTIC CEILING TILE	CRF	COVED RESILITANT	FOS	FACE OF STUD	LS	LAG SCREW	PERF	PERFORATED	STRUCT	STRUCTURAL
ADD	ADDITIVE	OTOK	FLOORING	FPW	FIRE RETARDANT	MANU	MANUFACTURER	PLWD	PLYWOOD	SUSP	SUSPENDED
ADJ	ADJUSTABLE	CTSK	COUNTERSUNK		TREATED PLYWOOD	MATL	MATERIAL	PNL	PANEL	SV	SHEET VINYL
ADMIN	ADMINISTRATION	CUH	CABINET UNIT HEATER	FRP	FIBERGLASS REINFORCED PLASTIC	MAX	MAXIMUM	PR	PAIR	T&G	TONGUE AND GROOVE
AFF	ABOVE FLOOR FINISH	D	DEEP	FRT	FIRE RETARDANT	MBR	MEMBER	PT	PAINT	ТВ	TACK BOARD
AK	ALASKA	DBL	DOUBLE		TREATED	MDF	MEDIUM DENSITY	R	RADIUS/ RISER	TEL	TELEPHONE
AL/ALUM	ALUMINUM	DF		FT	FOOT OR FEET		FIBERBOARD	R/A	RETURN AIR	ТОВ	TOP OF BEAM
ALT	ALTERNATE	DIA	DIAMETER	FTG	FOOTING	MECH		RB	RUBBER BASE	TOD	TOP OF DECK
APPROX	APPROXIMATE	DIM	DIMENSION	FURR	FURRING	MFP	METAL FACED PLYWOOD	RD	ROOF DRAIN	TOEB	TOP OF EXISTING BEAM
ARCH	ARCHITECTURAL	DISP	DISPENSER	GA	GAUGE	MFRD	MANUFACTURED	REF	REFERENCE	TOED	TOP OF EXISTING DECK
AT	ACOUSTIC TILE	DN	DOWN	GALV	GALVANIZED	MIN	MINIMUM	REFER	REFRIGERATOR	TOEJ	TOP OF EXISTING JOINT
AWP	ACOUSTICAL WALL	DTL	DETAIL	GL	GLASS		-	REINF	REINFORCED	TOEP	TOP OF EXISTING
	PANEL	DW	DISHWASHER	GWB	GYPSUM WALLBOARD	MISC	MISCELLANEOUS	REQ'D	REQUIRED		PARAPET
BD	BOARD	DWG	DRAWING	GVB GYP	GYPSUM	MO	MASONRY OPENING	REV	REVISION	TOP PL	
BLD/BLDG		DWR	DRAWER	HDPB	HIGH DENSITY PARTICLE	MTL	METAL	RF	RESILIENT FLOORING	TP	TOILET PAPER
BM	BEAM	E/A	EXHAUST AIR	UNRR	BOARD	MULL		RM	ROOM	TR	TREADS
BOD	BOTTOM OF DECK	EA	EACH	HDW	HARDWARE	N/A	NONE/ NOT APPLICABLE	RT	RUBBER TILE	TYP	TYPICAL
BOT	BOTTOM	EL/ELEV	ELEVATION	HDWD	HARDWOOD	NIC	NOT IN CONTRACT	RTU	ROOF TOP UNIT	UL	UNDERWRITERS
BTWN	BETWEEN	ELEC	ELECTRICAL	HORIZ	HORIZONTAL	NOM	NOMINAL	S	STUD		LABORATORY
C/L	CENTERLINE	ENCL	ENCLOSURE	HORIZ	HORIZONTAL	NTS	NOT TO SCALE	SA	SUPPLY AIR	UNO	UNLESS NOTED
CAB	CABINET	EPDM	ETHYLENE PROPYLENE			0	OUTSIDE	SAC	SUSPENDED		OTHERWISE
CB	COVE BASE		DIENE MONOMER	HR	HOUR	O.R.	OWNERS REP.		ACOUSTICAL CEILING	VERT	VERTICAL
CC	COLUMN COVER	EQ	EQUAL	HT	HEIGHT	O/	OVER	SCHED	SCHEDULE	VEST	VESTIBULE
CIP	CAST IN PLACE	EW	EMERGENCY EYE WASH			O/A	OUTSIDE AIR	SEAL	SEALER	VR	VAPOR RETARDER
CJ	CONTROL JOINT	EX/EXIST	EXISTING	ID	INSIDE DIAMETER	OC	ON CENTER	SECT	SECTION	W	WIDE OR WALL
CLR	CLEAR	EXP	EXPOSED STRUCTURE	IFS	INSIDE FACE OF STUD	OD	OUTSIDE DIAMETER	SF	SQUARE FOOT	W/	WITH
CMU	CONCRETE MASONRY		(NO CEILING)	IMP	INSULATED METAL	OFCI	OWNER FURNISHED	SHT	SHEET	W/O	WITHOUT
	UNITS	EXT	EXTERIOR		PANEL		CONTRACTOR	SHTG	SHEATHING	WC	WATER CLOSET
COL	COLUMN	FD	FLOOR DRAIN	INCL			INSTALLED	SIM	SIMILAR	WD	WOOD
CONC	CONCRETE	FDN	FOUNDATION	INSUL	INSULATION/INSULATING	OFD	OVER FLOW DRAIN	SM	SURFACE MOUNT	WFB	WOOD FIBER BOARD
CONF	CONFERENCE	FE	FIRE EXTINGUISHER	INT		OFS	OUTSIDE FACE OF STUD	SPECS	SPECIFICATIONS	WOM	WALK OFF MAT
CONST	CONSTRUCTION	FF	FACTORY FINISH	JAN	JANITOR	OFW	OUTSIDE FACE OF WALL	SQ	SQUARE	WP	WATERPROOF
CONT	CONTINUOUS	FIN	FINISH	JT	JOINT	OH	OVERHEAD	SS	STAINLESS STEEL	WRGWB	WATER RESISTANT
CONTR	CONTRACTOR	FIXT	FIXTURE	KIT	KITCHEN	OPNG	OPENING	ST	STAIN		GYPSUM WALLBOARD
-		FLASH	FLASHING	L	LONG	OPP	OPPOSITE HAND	STD	STANDARD	WWF	WELDED WIRE FABRIC
						P-LAM	PLASTIC LAMINATE	_			
<u>\\//IN</u>	IG SYMBOLS										
					UT						
01	ROOM TAG / NUMBI		040 <sup>-</sup>		<b>.</b> .	NORTH	NORTH	I ARROW	4 FINISH TAG		
XX)	DOOR TAG	A	1 040/ BUI	LDING OR V	WALL SECTION		<b>/IEW</b> VIEW	TITLE			
3	WALL TAG					- -					
1			1			A	GRID				

## D

**RESPOSIBLE FOR RE-INSTALLATION** 

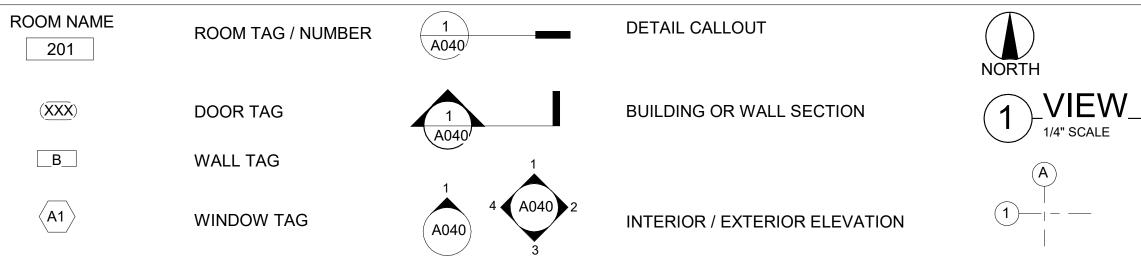

## GENERAL NOTES DEMOLITION PLANS

DEMOLITION PROCEDURES SHALL COMPLY WITH ANSI/ASSE A10.6 AND NFPA 241. THE INFORMATION SHOWN IN THIS DRAWING IS TAKEN FROM AS-BUILT DRAWINGS AND WALK-THRU OF THE EXISTING FACILITY. THERE IS NO WARRANTY OR GUARANTEE AS OF THE ACCURACY OF THE INFORMATION SHOWN. THE CONTRACTOR SHALL FIELD VERIFY ALL ITEMS, AREAS, AND ASSEMBLIES SHOWN FOR DEMOLITION PRIOR TO START OF WORK. REFER TO MECHANICAL, ELECTRICAL SHEETS FOR RELATED DEMOLITION INFORMATION. 3. THE OWNER SHALL HAVE FIRST RIGHT OF REFUSAL ON ALL SALVAGEABLE MATERIAL, THE CONTRACTOR SHALL DELIVER SALVAGED MATERIALS TO AN AREA AS DIRECTED BY THE OWNER. CONTRACTOR TO VERIFY EXISTING CONDITIONS BEFORE WORK. DEMOLITION WILL BE GOVERNED BY NEW CONSTRUCTION INVOLVED. REMOVAL OF EXISTING EQUIPMENT, CASEWORK, M&E, AND MAJOR ITEMS NOTED FOR DEMOLITION SHALL 6 INCLUDE ALL ANCHORS, HANGERS, AND ATTACHMENTS. AFTER REMOVAL OF ALL FLOORS, WALLS, AND CEILINGS, SURFACES SHALL BE PREPARED TO RECEIVED NEW FINISH OR FINISHED TO MATCH ADJACENT CONDITIONS. MATCH THICKNESS OF EXISTING WALL AND CEILINGS WHERE PATCH AND REPAIR IS REQUIRED. REMOVE EXISTING EQUIPMENT, DISPOSE ITEMS NOT REMAINING IN THE PROJECT AND PROTECT EXISTING EQUIPMENT TO REMAIN DURING CONSTRUCTION. SELECT WALLS, DOORS, FRAMES, RELITES & FRAMES, HARDWARE, CASEWORK, INTERIOR WINDOWS & WINDOW 9 FRAMES, AND OTHER DEVICES ARE TO BE REMOVED AS INDICATED IN PLAN. RETURN UNUSED DOORS TO BUILDING OWNER FOR SURPLUS STOCK. 10 PATCH AND REPAIR DAMAGE TO ADJACENT WALL SURFACES SCHEDULED TO REMAIN, AND PREPARE FOR NEW 11. FINISHES. DIMENSIONS ARE TO FACE OF FINISH, U.N.O. 12. EXISTING WINDOW SHADES TO BE REMOVED WITHIN PROJECT SCOPE AREA. 13. ITEMS OF INTEREST OR VALUE THAT ARE UNCOVERED DURING DEMOLITION BECOME THE PROPERTY OF 14. BUILDING OWNER. 15. ALL DISCREPANCIES BETWEEN INFORMATION IN THESE DRAWINGS AND ACTUAL FIELD CONDITIONS SHALL BE BROUGHT TO THE DESIGNER'S ATTENTION IMMEDIATELY FOR CLARIFICATION AND RESOLUTION. PROVIDE TEMPORARY BARRICADES AND OTHER PROTECTION REQUIRED TO PREVENT INJURY TO PEOPLE AND 16. DAMAGE TO ADJACENT BUILDINGS AND FACILITIES TO REMAIN. 17. PROTECT WALLS, CEILINGS, FLOORS AND OTHER FINISH WORK THAT ARE TO REMAIN OR THAT ARE EXPOSED DURING DEMOLITION OPERATIONS. 18. FIELD VERIFICATION: CONTRACTOR SHALL FIELD VERIFY ALL DIMENSIONS AND VERTICAL CONTROL PRIOR TO THE COMMENCEMENT OF WORK. PROMPTLY NOTIFY THE DESIGNER IN WRITING OF DISCREPANCIES IN NEW AND/OR EXISTING CONDITIONS. 19. TEMPORARY RELOCATION OF EXISTING DISPLAYS TO BE DONE BY THE CONTRACTOR, COORDINATATED WITH OWNER AND PROTECTED DURING CONSTRUCTION. ONCE CONSTRUCION IS COMPLETE, CONTRACTOR IS

## **GENERAL NOTES - CONSTRUCTION PLANS**

I	DIMENSIONS ARE T	. ) E
)	ALL WORK SHALL B	
<u>2.</u> 3.	NO WORK SHALL C	
).  .	ALL WORK LISTED,	
г. 5.	CONTRACTOR SHA	
). 6.	THE CONTRACTOR	
).	THEIR SUB-CONTRA	
<i>.</i>	DOOR OPENINGS: L	
	ANY DISCREPANCI	-
). ).	ADD ELECTRICAL/P	
	FURNITURE TO BE	
	PROVIDE BRACING	
	ALL SURFACES (FL	
	PARTITIONS SCHEE	
	ALL ACCESS PANEL	
	ALL CONVENTIONA	
	ALL REVEALS AND	
	INSTALL ALL FINISH	
	ALL ROOMS TO BE	
	LOCATION.	0
9.	ALL SPECIALTY LIG	ΗTI
20.	FIELD VERIFICATIO	
	CONDITIONS.	
21.	IN PUBLIC FACING	ARE
22.	ALL SURFACES IN S	
23.	ALL FLOORING TRA	
24.	REFER TO MATERIA	۹L L
25.	<b>RE-INSTALL EXISTI</b>	١G
	REFER TO ELECTR	
27.	CONCRETE SUBFLO	DOF
	A. FLOORS SH	
	FROM POWE	DER
	B. CONCRETE	SLA
	C. DO NOT INS	
	D. PH LEVEL O	
	E FILL DEPRES	

STRENGTH OF 3,000 PSI.

FINISHED FACE OF GWB U.N.O.

PERFORMED IN ACCORDANCE WITH BUILDING CODES IN THE EDITIONS MOST RECENTLY ADOPTED BY THE CITY OF ANCHORAGE.

IMENCE AT THE SITE UNTIL APPLICABLE APPROVALS AND REQUIRED PERMITS HAVE BEEN OBTAINED BY THE GENERAL CONTRACTOR.

HOWN OR IMPLIED ON ANY CONSTRUCTION DOCUMENT SHALL BE SUPPLIED AND INSTALLED BY THE GENERAL CONTRACTOR. UNO.

VERIFY DIMENSIONS. REQUIRED CLEARANCES AND SYSTEM REQUIREMENTS FOR ALL SCOPE OF WORK. NOTIFY THE OWNERS REP OF ANY DISCREPANCIES PRIOR TO THE COMMENCEMENT OF WORK. RESPONSIBLE FOR HAVING THE MOST CURRENT SET OF CONTRACT DOCUMENTS ON SITE DURING CONSTRUCTION AND FOR THE DISTRIBUTION OF CURRENT DRAWINGS TO ALL SUB-CONTRACTORS. THE CONTRACTOR AND CTORS ARE RESPONSIBLE FOR REVIEWING REISSUED DOCUMENTS FOR CHANGES. THE CONTRACTOR IS RESPONSIBLE FOR NOTIFYING THE OWNERS REP OF ANY CHANGES THAT AFFECT THE SCOPE OF WORK. N.O., ALL DOORS ARE TO BE LOCATED SUCH THAT THE FINISH FACE OF THE HINGE JAMB IS 4" FROM NEAREST INTERSECTING PARTITION. INSTALL NEW DOORS & FRAMES PER DOOR/OPENING LEGEND. BETWEEN INFORMATION IN THESE DRAWINGS AND ACTUAL FIELD CONDITIONS SHALL BE BROUGHT TO THE DESIGNER'S ATTENTION IMMEDIATELY FOR CLARIFICATION AND RESOLUTION. JMBING FOR NEW APPLIANCES/FIXTURES, ETC.

D BY POWER/DATA LOCATED IN ADJACENT WALLS WHEREVER POSSIBLE. OR THROUGH EXISTING FLOOR CORE LOCATIONS.

I WALL AT ALL UPPER CABINETS, WHITEBOARDS AND SCREENS AS NEEDED.

DR, WALL, CEILING) TO BE PREPARED AND FLOATED OUT TO RECEIVE THEIR SCHEDULED FINISHES AND TO MAINTAIN SMOOTH, CONSISTENT APPEARANCE. NOTICEABLE DRYWALL SEAMS NOT ACCEPTABLE. ILED TO RECEIVE STANDARD PAINT COMPLY WITH GA-214-90 LEVEL 4 FINISH. WALLS TO RECEIVE WALLCOVERING SHALL COMPLY WITH GA-214-90 LEVEL 5 FINISH.

ARE TO BE PAINTED TO MATCH ADJACENT SURFACE. PAINT IS TO BE SPRAY APPLIED, NOT BRUSHED OR ROLLED.

WALLS TO BE PAINTED HIGH-PERFORMANCE ARCHITECTURAL LATEX INTERIOR PAINT:SHERWIN WILLIAMS PROMAR 200 ZERO VOC, EGGSHELL FINISH, P-X, U.N.O.

DINTS TO BE PAINTED TO MATCH ADJACENT SURFACES, U.N.O.

IATERIALS PER MANUFACTURER'S SPECIFICATIONS AND RECOMMENDATIONS. VITCHED PER ELECTRICAL, U.N.O. ALL SWITCHES AND SENSORS ARE TO BE LOCATED 6" FROM THE END OF THE DOOR IN OPEN POSITION. IF ADDITIONAL SWITCHES ARE REQUIRED COORDINATE WITH DESIGNER FOR

TING TO HAVE SMOOTH DIMMER CAPABILITIES.

CONTRACTOR SHALL FIELD VERIFY ALL DIMENSIONS AND VERTICAL CONTROL PRIOR TO THE COMMENCEMENT OF WORK. PROMPTLY NOTIFY THE DESIGNER IN WRITING OF DISCREPANCIES IN NEW AND/OR EXISTING

REAS, PROVIDE NEW WOOD BASE TO MATCH EXISTING.

OPE OF WORK TO BE PREPARED AND FLOATED OUT AS NECESSARY TO RECEIVE THEIR SCHEDULED FINISHED AND TO MAINTAIN SMOOTH EVEN AND CONSISTENT APPEARANCE. SITIONS OCCUR AT CENTERLINE OF DOOR OR OPENING UNO

LEGEND FOR FINISHES. GEQUIPMENT THAT WAS PROTECTED DURING CONSTRUCTION.

AL AND MECHANICAL DRAWINGS FOR ADDITIONAL INFORMATION PERTAINING TO CEILING-MOUNTED SYSTEMS.

R PREP: . BE SMOOTH, PERMANENTLY DRY, CLEAN AND FREE OF ALL FOREIGN MATERIAL SUCH AS DUST, WAX, SOLVENTS, PAINT, GREASE, OILS, AND OLD ADHESIVE RESIDUE. THE SURFACE MUST BE HARD AND DENSE, AND FREE R OR FLAKING.

ABS MUST BE DRY WITH NO VISIBLE MOISTURE

LL OVER CONCRETE WITH HISTORY OF HIGH MOISTURE OF HYDROSTATIC CONDITIONS.

CONCRETE SHOULD BE BETWEEN 7-10

FILL DEPRESSIONS OR CRACKS WITH A CEMENTITIOUS PATCHING / LEVELING COMPOUND THAT MEETS OR EXCEEDS THE MAXIMUM MOISTURE LEVEL AND PH REQUIREMENTS OF THE PRODUCT MANUFACTURE AND MEET A COMPRESSION

F O R: **SUBMITTAL** PRICING



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#### ALASKA NATIVE HERITAGE CENTER REMODEL

8800 Heritage Center Drive, Anchorage, Alaska

**BID CONSTRUCTION** DOCUMENTS

2023014 JOB NO. 10.15.2023 DATE: MLP PROJ. MGR.: MLP DRAWN BY: REVIEWED BY: JTW


REVISIONS:

## ABBREVIATIONS



AND GENERAL NOTES

EGEND		VERTICAL ASS
SSEMBLY TYPE SYMBOL:	STUD KEY SIZE	
WALL TYPE ALPHA/NUMERIC CODE STUD SIZE, PER KEY ACOUSTICAL SOUND INSULATION, INDICATED BY "S" IF REQUIRED INDICATED FACE OF WALL ASSEMBLY FOR SIDE OF WALL, REFER TO PLAN FOR SIDE INDICATION	1 = 1 5/8" STEEL 10 = 10" STEEL 2 = 2 1/2" STEEL 12 = 12" STEEL 4 = 4" STEEL 6 = 6" STEEL 8 = 8" STEEL	5/ SI SI SI SI
GENERAL NO	TES	
<ol> <li>ALL DIMENSIONS ARE TO FACE OF STUD, CONCRET NOTED. DIMENSIONING POINTS ARE TO THE MAIN OF ANY FURRING OR FINISH SHOWN ON THE WALL</li> <li>FINISH MATERIALS SUCH AS CERAMIC TILE, WALL O SHOWN AS AN INTEGRAL PART OF THE ASSEMBLY. INTERIOR ELEVATIONS FOR ADDITIONAL FINISH RE</li> <li>PROVIDE CEMENT BOARD IN LIEU OF GYPSUM BOA CERAMIC TILE FINISH; REFER TO FINISH SCHEDULE</li> <li>STUD SIZES TYPICALLY USED THROUGHOUT THE P ASSEMBLY TYPE.</li> <li>4" INTERIOR METAL STUDS OVER 17' HIGH SHALL B 5 PSF AT L/240.</li> <li>6" INTERIOR METAL STUDS OVER 20' HIGH SHALL B</li> </ol>	WALL MEMBER AND NOT TO THE FACE TYPES. COVERINGS, ETC. ARE NOT TYPICALLY REFER TO FINISH SCHEDULES AND QUIREMENTS. ARD AS SUBSTRATE TO ALL WALLS WITH FOR LOCATIONS. PROJECT ARE SHOWN WITH EACH SE STRUCTURAL STUDS; DESIGNED FOR	

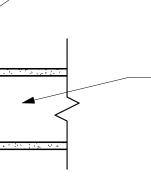


SIDED FINISH AS SCHEDULED - 3 5/8" METAL STUD

FRAMING

- 5/8" TYPE X GWB TWO

SSEMBLY TYPES

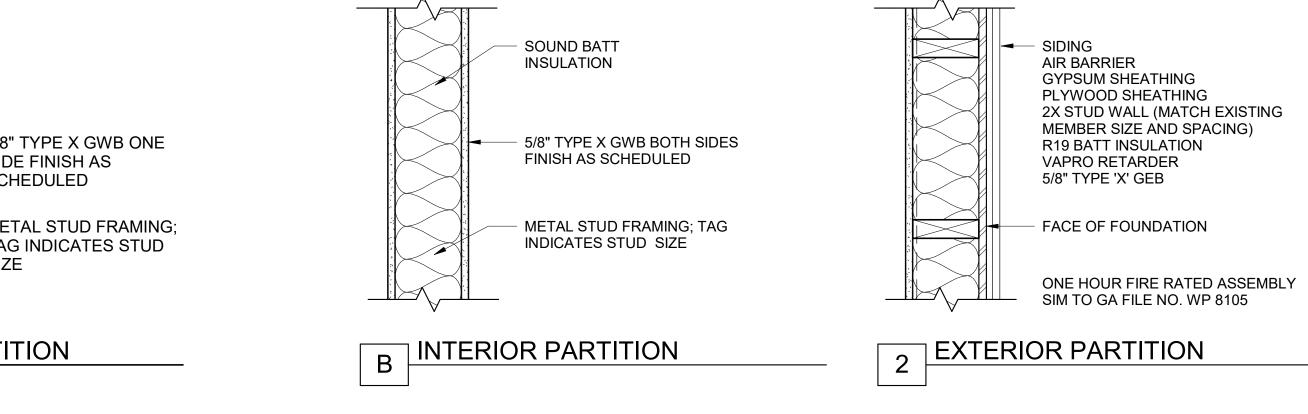

## SEMBLY TYPES

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#### ALASKA NATIVE HERITAGE CENTER REMODEL

8800 Heritage Center Drive, Anchorage, Alaska


**BID CONSTRUCTION** DOCUMENTS

JOB NO.	2023014
DATE:	10.15.2023
PROJ. MGR.:	MLP
DRAWN BY:	MLP
REVIEWED BY:	JTW
REVISIONS:	

#### ASSEMBLIES

SHEET NO.

G003

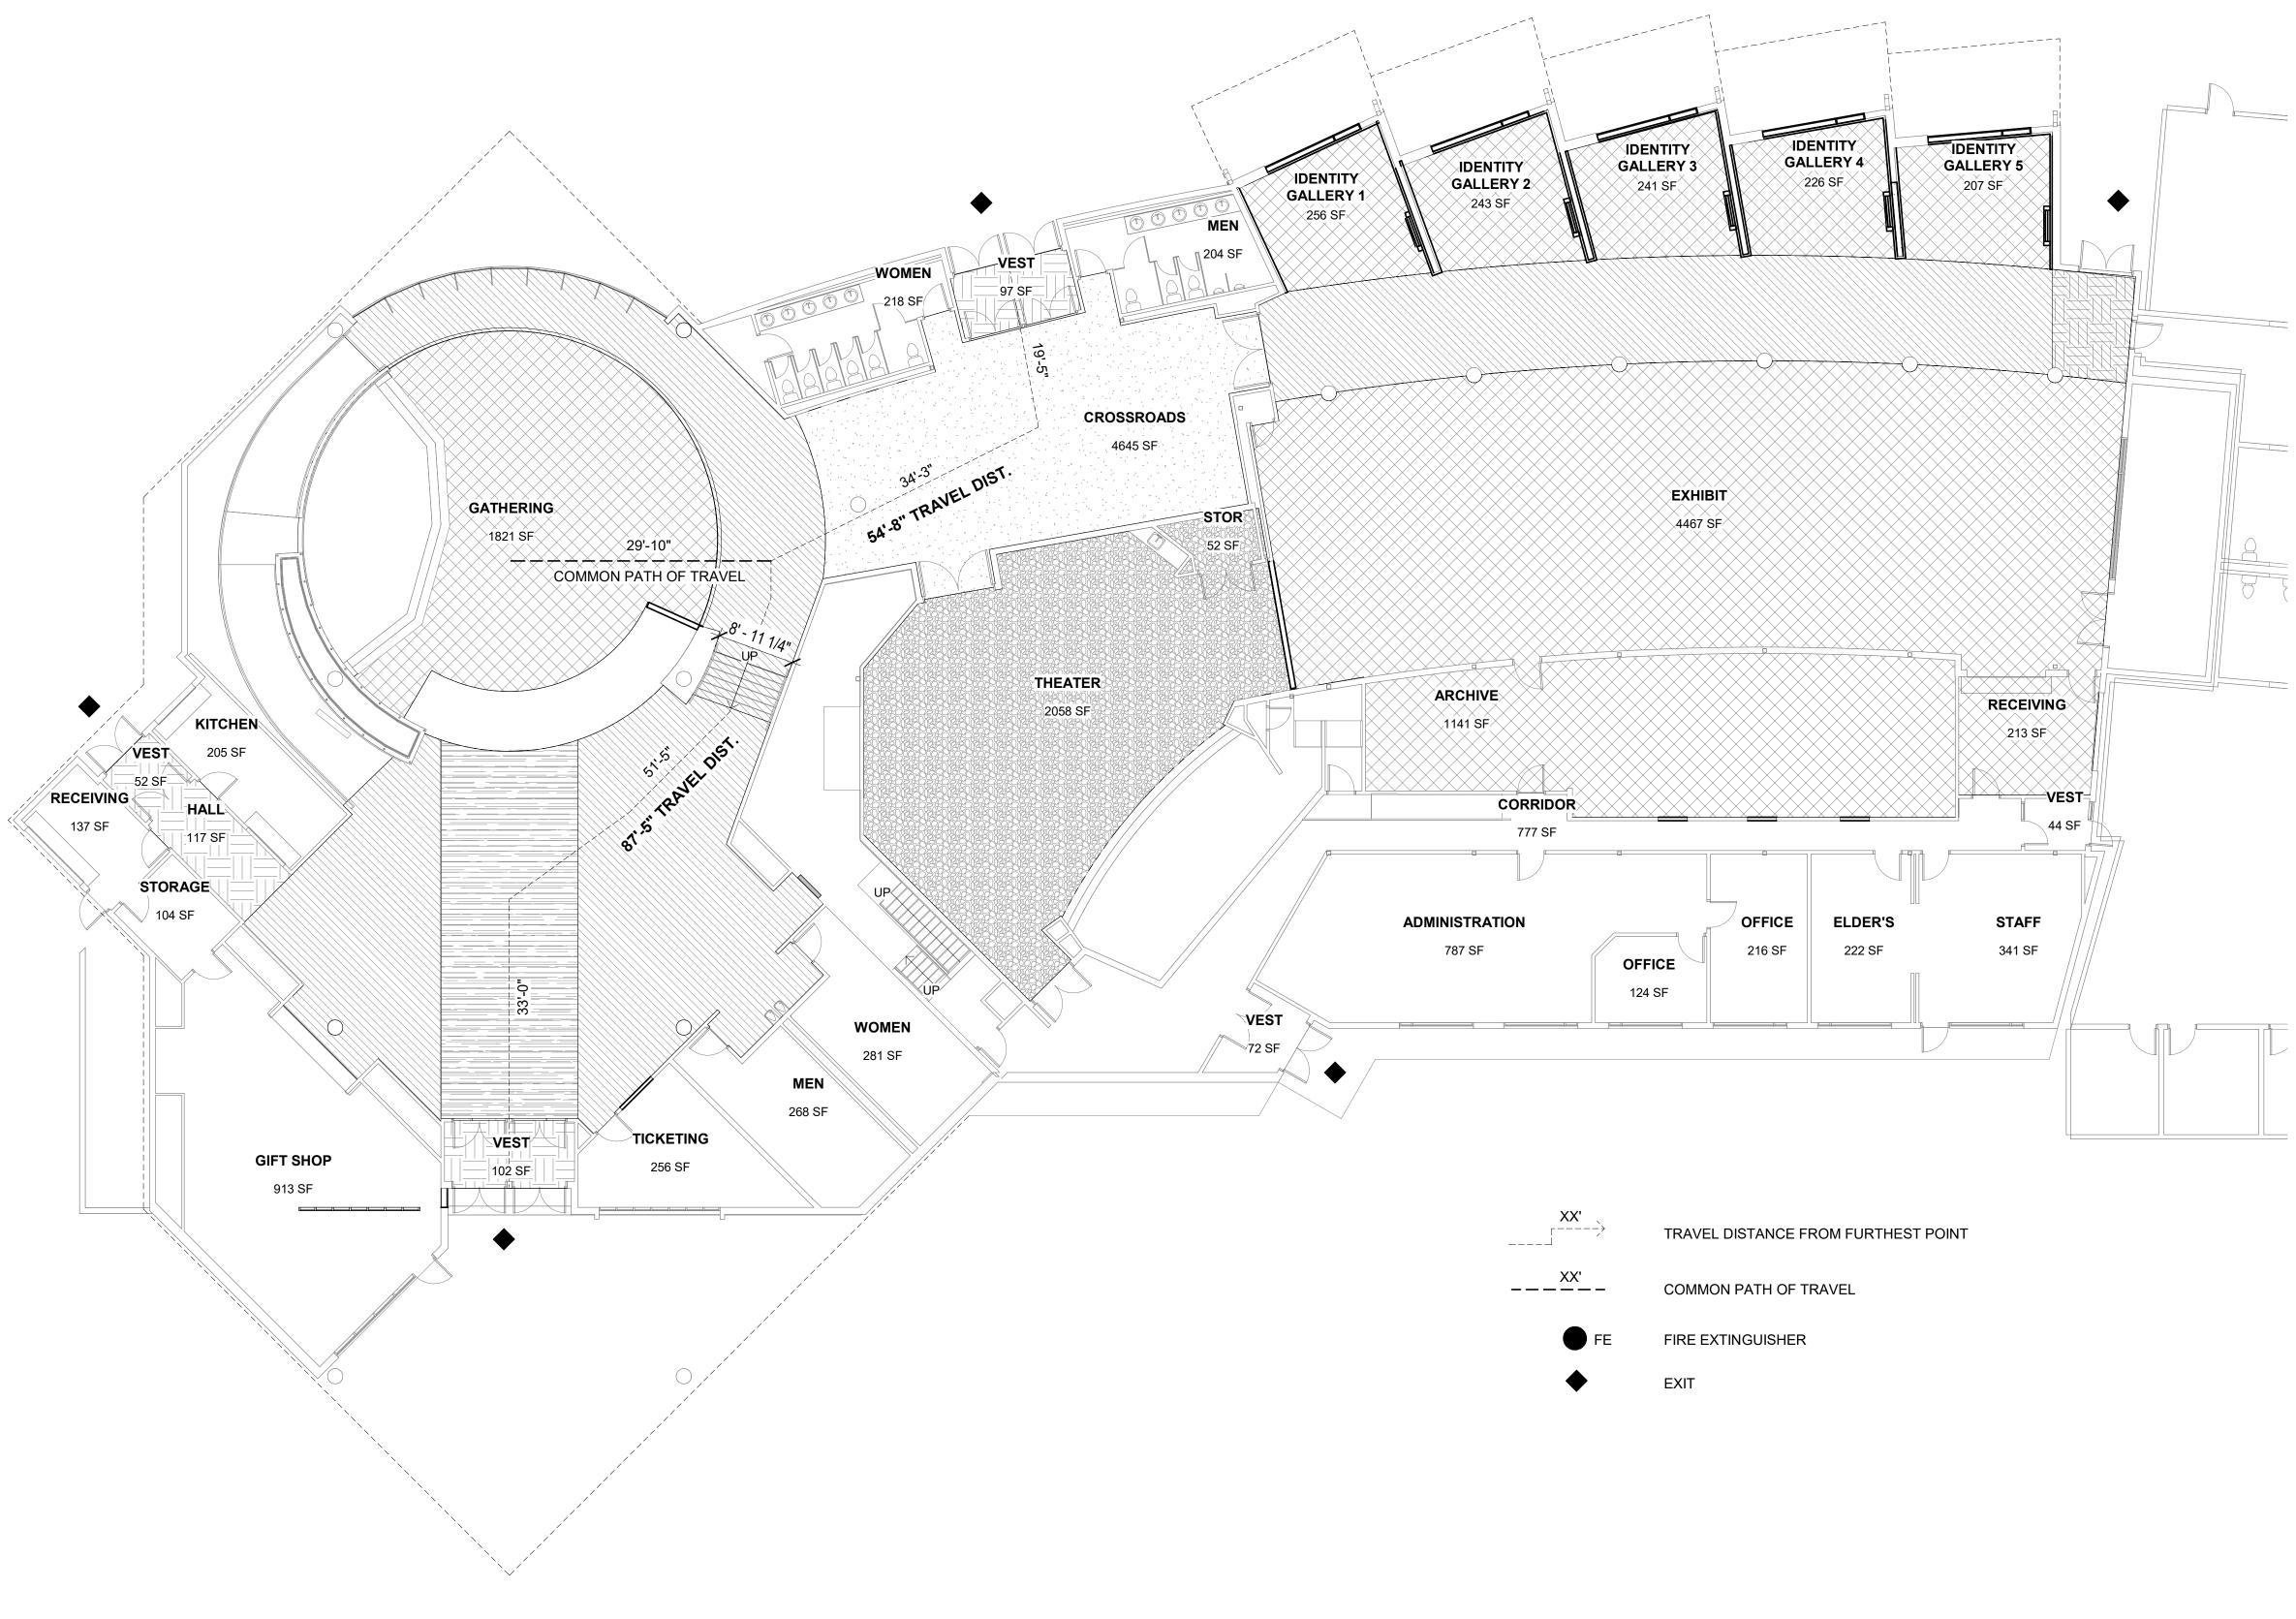



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#### Auditorium Stairs – Code Summary

1. 2.	International Building Code 2021 as amended by SOA Remodel of auditorium interior, which includes radial interior staircase and	MCG
3.	attached auditorium seating. <b>Construction Type:</b> Type III (Type III construction is that type of construction in which the exterior walls are of noncombustible materials <u>and the interior</u> building elements are of any materials permitted by this code	EXPLORE DESIGN
4.	<ul> <li>building elements are of any materials permitted by this code.</li> <li>Occupancy Groups: (Type A-3 used for allowable height and area)</li> <li>Group A-3: IBC 303.4 allows this classification for intended uses including art collected and muscume.</li> </ul>	421 West 1 <sup>st</sup> Avenue, Suite 300 Anchorage, Alaska 99501 907.563.8474   F 907.563.4572
5.	<ul> <li>including art galleries and museums.</li> <li>Incidental Use Areas (TA.509):</li> <li>There are no incidental use areas which would need fire separations per Section 509.</li> </ul>	explore design.com
6.	Separation of Occupancies (Table 508.4):	
_	None required	
7.	<ul> <li>Fire Protection: (Table 705.5)</li> <li>Occupancy group A-3 would require a fire separation of X ≥ 30 feet for</li> </ul>	assessed,
	Type III (All) construction.	OF ALA
8.	Allowable Height & Area (Table 504.3)	
0	Not applicable for planned interior work.  Structural Fire Resistance (Table 601):	* 49 <u>th</u> * *
9.	<ul> <li>Structural Fire Resistance (Table 601):</li> <li>No fire resistance of structural elements required for Type IIIB</li> </ul>	
	construction	• No. 10242
1 <b>0</b> .	Interior Finishes	PROFESSIONA
	<ul> <li>Interior floor covering materials to comply with Sections 804.4.1 and 804.4.2 and interior floor finish materials to comply with Sections 804.4.2.</li> </ul>	10.15.2023
	<ul> <li>Interior finishes for atriums: The interior finish of walls and ceilings of the</li> </ul>	ANHC
	atrium shall be not less than Class B. Sprinkler protection shall not result	
11.	in a reduction in class. Occupant Loads and Exiting:	
	Occupant loads and Exiting.     Occupant loads (Table 1004.5)	
	<ul> <li>Assembly – without fixed seats, standing space = 5 net</li> </ul>	ALASKA
	• Area of assembly (1821sqft/5 net) = 364.2 occupant load	NATIVE
	<ul> <li>Post maximum occupancy signage in Assembly entrance (1004.9)</li> <li>Egress component widths = For other than Group H and I-2</li> </ul>	HERITAGE
	occupancies, stairways shall be calculated by multiplying the occupant	CENTER
	load served by stairways by a means of egress capacity factor of 0.2"	
	per occupant. (Exception 1 on 1005.3.1)	REMODEL
	<ul> <li>364.2 x 0.2 =72.84" = 6.07' minimum egress width</li> <li>Egress width of staircase on side of auditorium is 8'-11 1/4", granting</li> </ul>	
	auditorium stairs are not required to be egress stairs.	
	Common path of egress travel distance not to exceed 75' (Table 1006.2.1)	
12.	<ul> <li>Exit access travel distance not to exceed 250' (Table 1017.2)</li> <li>Means of Egress Sizing</li> </ul>	
12.	• Stair riser heights shall be 7 inches maximum and 4 inches minimum.	8800 Heritage Center Drive, Anchorage, Alaska
	The riser height shall be measured vertically between the nosings of	
	adjacent treads or between the stairway landing and the adjacent tread.	BID CONSTRUCTION DOCUMENTS
	Rectangular tread depths shall be 11 inches minimum measured horizontally between the vertical planes of the foremost project of	DOCUMENTS
	adjacent treads and at a right angle to the tread's nosing. 1011.5.2	
	Nosings shall have a curvature or bevel of not less than 1/16 inch but	JOB NO. 2023014
	more than 9/16 inch from the foremost projection of the tread. Risers shall be a solid and vertical or sloped under the tread above the from	DATE: 10.15.2023
	the underside of the nosings above at an angle not more than 30	PROJ. MGR.: MLP DRAWN BY: SP
	degrees from the vertical. 1011.5.5	REVIEWED BY: JTW
	• The leading edge (nosings) of treads shall project not more than 1 <sup>1</sup> / <sub>4</sub>	REVISIONS:
	<ul> <li>inches beyond the tread below. 1011.5.5.1</li> <li>Handrails: Flights of stairways shall have handrails one each side and</li> </ul>	
	shall comply with Section 1014. Where glass is used to provide the	
	handrail, the handrail shall comply with Section 2407. 1011.11	
	<ul> <li>Handrail height: Handrail height, measured above stove tread nosings, or finish surface of rame clone, shall be uniform, not loss than 34 inches.</li> </ul>	1
	or finish surface of ramp slope, shall be uniform, not less than 34 inches and not more than 38 inches. 1014.2	1
	Handrail graspability Type I: Where the handrail is not circular, it shall	1
	have a perimeter dimension of not less than 4 inches and not greater	
	than 6 $\frac{1}{4}$ inches with a maximum cross-sectional dimension of 2 $\frac{1}{4}$	1
	inches and minimum cross sectional dimension of 1 inch. Edges shall have a minimum radius of 0.01 inch. 1014.3.1	1

 Handrail extensions: Where handrails are not continuous between flights, the handrails shall extend horizontally not less than 12 inches. 1014.6


13. Accessibility

 IBC Chapter 11 and ANSI A117.1-2009 are used as a design metric for building accessibility requirements.

#### CODE PLAN

SHEET NO.

G004

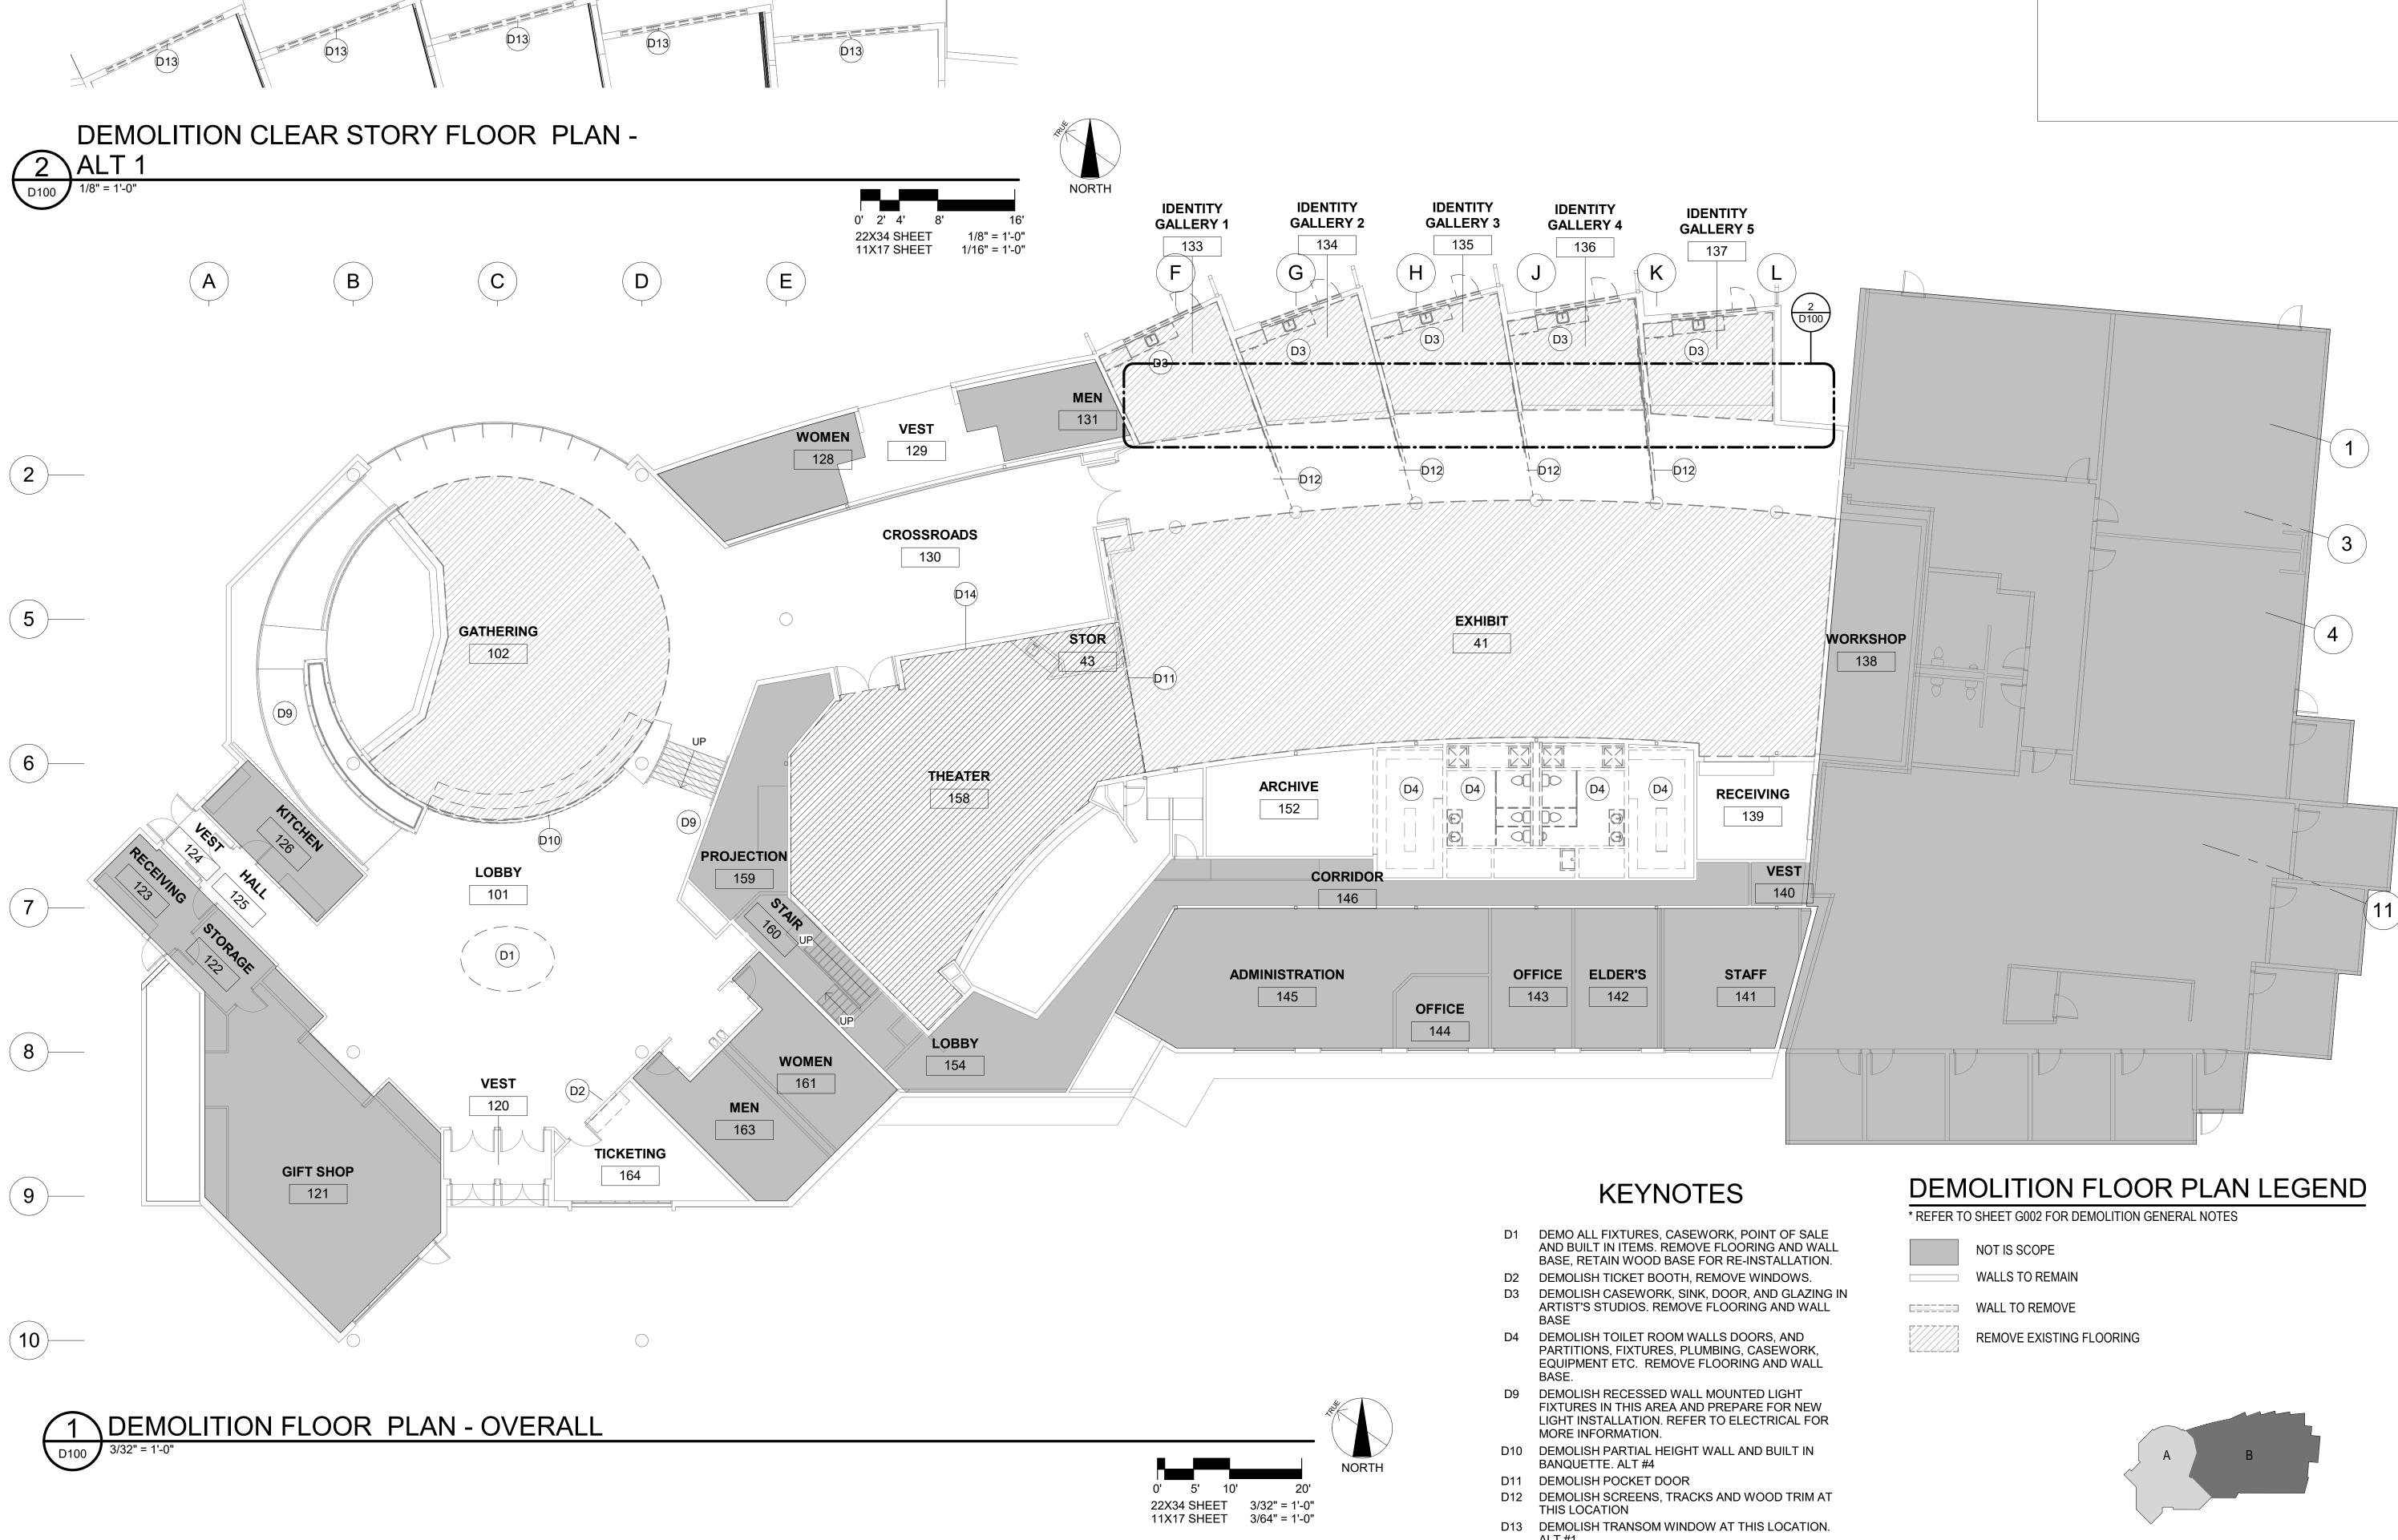

- ALT #1
- D14 THIS AREA OF DEMOLITION IS UNDER ALT #3.

F O R: SUBMITTAL PRICING



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ANHC

#### ALASKA NATIVE HERITAGE CENTER REMODEL

8800 Heritage Center Drive, Anchorage, Alaska

#### **BID CONSTRUCTION** DOCUMENTS


JOB NO.	2023014
DATE:	10.15.2023
PROJ. MGR.:	MLP
DRAWN BY:	MLP
REVIEWED BY:	JTW
REVISIONS:	




SHEET NO.

**D100** 

KEY PLAN

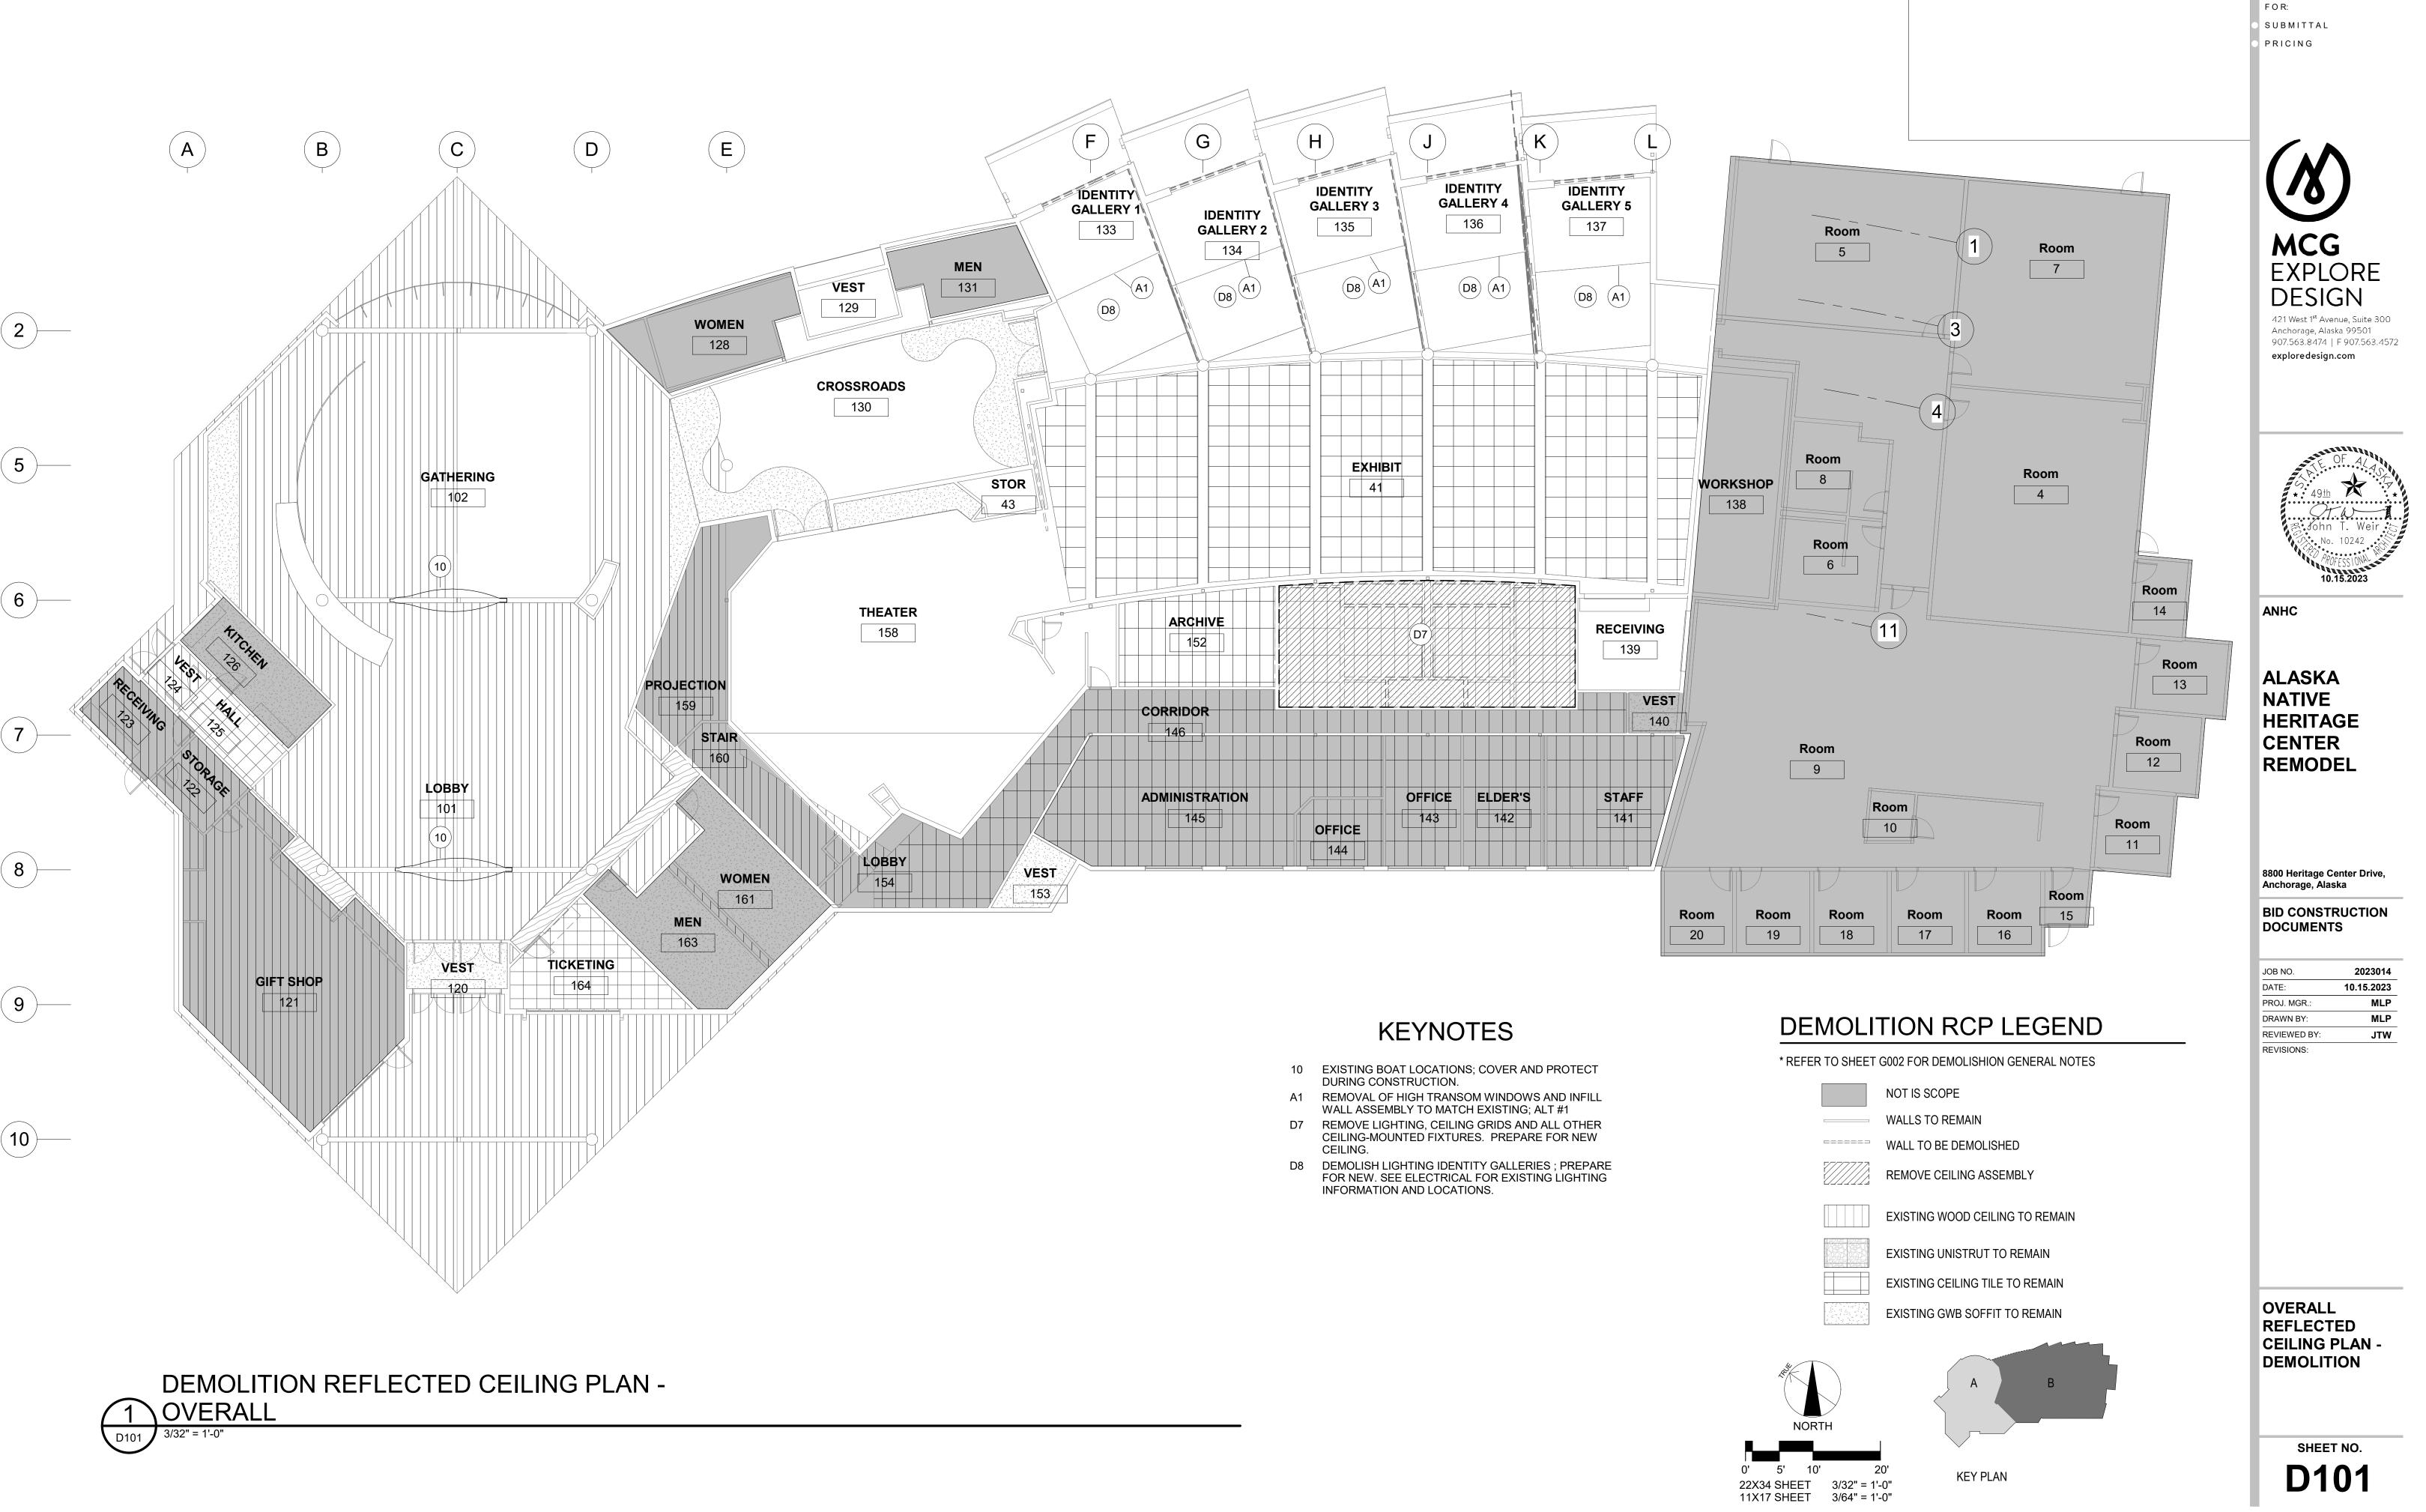

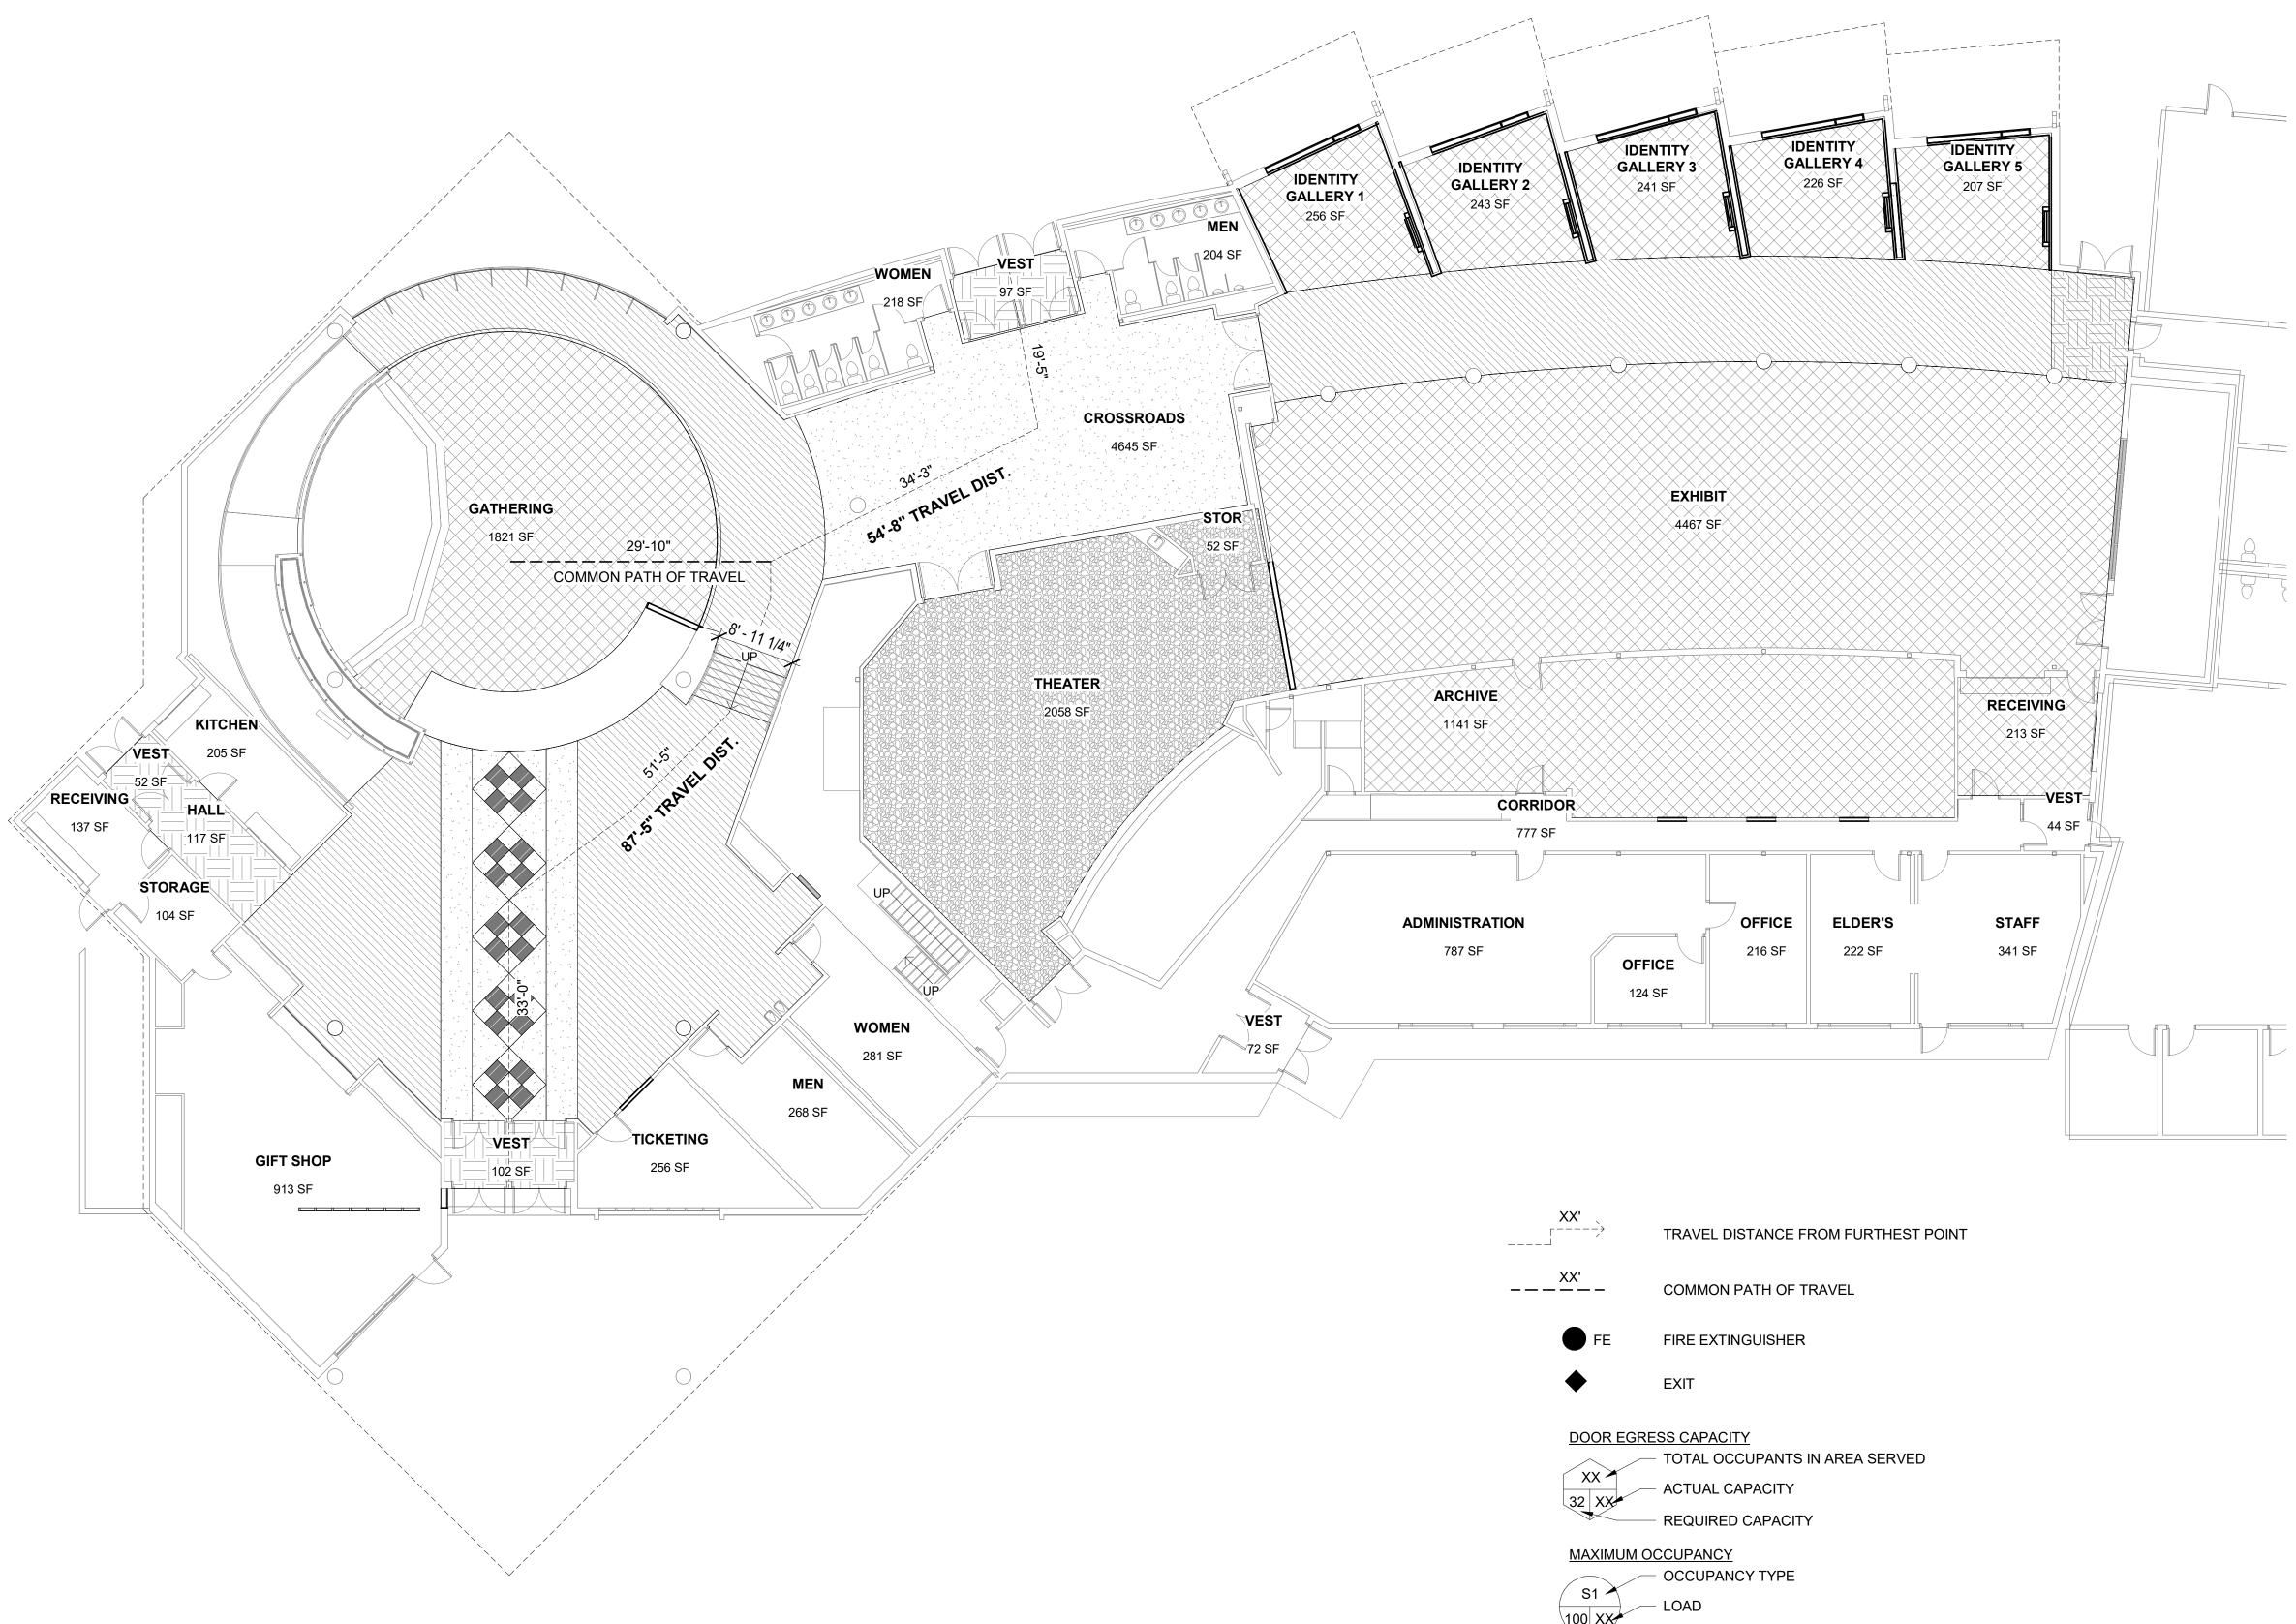



FACTOR

F O R: SUBMITTAL PRICING

#### Auditorium Stairs – Code Summary

1.	International Building Code 2021 as amended by SOA	MCG
2.	Remodel of auditorium interior, which includes radial interior staircase and	MCG
	attached auditorium seating.	
3.	<b>Construction Type:</b> Type III (Type III construction is that type of construction	EXPLORE
	in which the exterior walls are of noncombustible materials and the interior	DESIGN
	building elements are of any materials permitted by this code.	DESIGIN
4.	Occupancy Groups: (Type A-3 used for allowable height and area)	421 West 1 <sup>st</sup> Avenue, Suite 300
ч.		Anchorage, Alaska 99501
	Group A-3: IBC 303.4 allows this classification for intended uses	907.563.8474   F 907.563.4572
_	including art galleries and museums.	exploredesign.com
5.	Incidental Use Areas (TA.509):	
	<ul> <li>There are no incidental use areas which would need fire separations per</li> </ul>	
	Section 509.	
6.	Separation of Occupancies (Table 508.4):	
	None required	
7.	Fire Protection: (Table 705.5)	
	• Occupancy group A-3 would require a fire separation of $X \ge 30$ feet for	.(155555 <del>5</del>
	Type III (All) construction.	OF AL
o		
8.	Allowable Height & Area (Table 504.3)	
•	Not applicable for planned interior work.	
9.	Structural Fire Resistance (Table 601):	T.W.
	<ul> <li>No fire resistance of structural elements required for Type IIIB</li> </ul>	ア John T. Weir ち
	construction	No. 10242
1 <b>0</b> .	Interior Finishes	
	<ul> <li>Interior floor covering materials to comply with Sections 804.4.1 and</li> </ul>	THOFESSIONAL
	804.4.2 and interior floor finish materials to comply with Sections	10.15.2023
	804.4.2.	
	<ul> <li>Interior finishes for atriums: The interior finish of walls and ceilings of the</li> </ul>	ANHC
	•	ANHC
	atrium shall be not less than Class B. Sprinkler protection shall not result	
	in a reduction in class.	
11.	Occupant Loads and Exiting:	
	Occupant loads (Table 1004.5)	
	<ul> <li>Assembly – without fixed seats, standing space = 5 net</li> </ul>	ALASKA
	<ul> <li>Area of assembly (1821sqft/5 net) = 364.2 occupant load</li> </ul>	NATIVE
	<ul> <li>Post maximum occupancy signage in Assembly entrance (1004.9)</li> </ul>	
	• Egress component widths = For other than Group H and I-2	HERITAGE
	occupancies, stairways shall be calculated by multiplying the occupant	CENTED
	load served by stairways by a means of egress capacity factor of 0.2"	CENTER
		REMODEL
	per occupant. (Exception 1 on 1005.3.1)	
	• $364.2 \times 0.2 = 72.84^{\circ} = 6.07^{\circ}$ minimum egress width	
	• Egress width of staircase on side of auditorium is 8'-11 1/4", granting	
	auditorium stairs are not required to be egress stairs.	
	<ul> <li>Common path of egress travel distance not to exceed 75' (Table</li> </ul>	
	1006.2.1)	
	<ul> <li>Exit access travel distance not to exceed 250' (Table 1017.2)</li> </ul>	
12.	Means of Egress Sizing	8800 Heritage Center Drive,
	• Stair riser heights shall be 7 inches maximum and 4 inches minimum.	Anchorage, Alaska
	The riser height shall be measured vertically between the nosings of	
	adjacent treads or between the stairway landing and the adjacent tread.	BID CONSTRUCTION
	Rectangular tread depths shall be 11 inches minimum measured	DOCUMENTS
	horizontally between the vertical planes of the foremost project of	
	adjacent treads and at a right angle to the tread's nosing. 1011.5.2	
	Nosings shall have a curvature or bevel of not less than 1/16 inch but	JOB NO. 2023014
	more than 9/16 inch from the foremost projection of the tread. Risers	DATE: <b>10.15.2023</b>
	shall be a solid and vertical or sloped under the tread above the from	PROJ. MGR.: MLP
	the underside of the nosings above at an angle not more than 30	DRAWN BY: SP
	degrees from the vertical. 1011.5.5	
	• The leading edge (nosings) of treads shall project not more than 1 1/4	
	inches beyond the tread below. 1011.5.5.1	REVISIONS:
	Handrails: Flights of stairways shall have handrails one each side and	
	shall comply with Section 1014. Where glass is used to provide the	
	handrail, the handrail shall comply with Section 2407. 1011.11	
	Handrail height: Handrail height, measured above stove tread nosings,	
	or finish surface of ramp slope, shall be uniform, not less than 34 inches	
	and not more than 38 inches. 1014.2	
	<ul> <li>Handrail graspability Type I: Where the handrail is not circular, it shall</li> </ul>	
	have a perimeter dimension of not less than 4 inches and not greater	
	than 6 $\frac{1}{4}$ inches with a maximum cross-sectional dimension of 2 $\frac{1}{4}$	
	inches and minimum cross sectional dimension of 1 inch. Edges shall	
	· · · · · · · · · · · · · · · · · · ·	

have a minimum radius of 0.01 inch. 1014.3.1 Handrail extensions: Where handrails are not continuous between flights, the handrails shall extend horizontally not less than 12 inches. 1014.6


13. Accessibility


IBC Chapter 11 and ANSI A117.1-2009 are used as a design metric for • building accessibility requirements.

#### CODE PLAN

SHEET NO.

G004

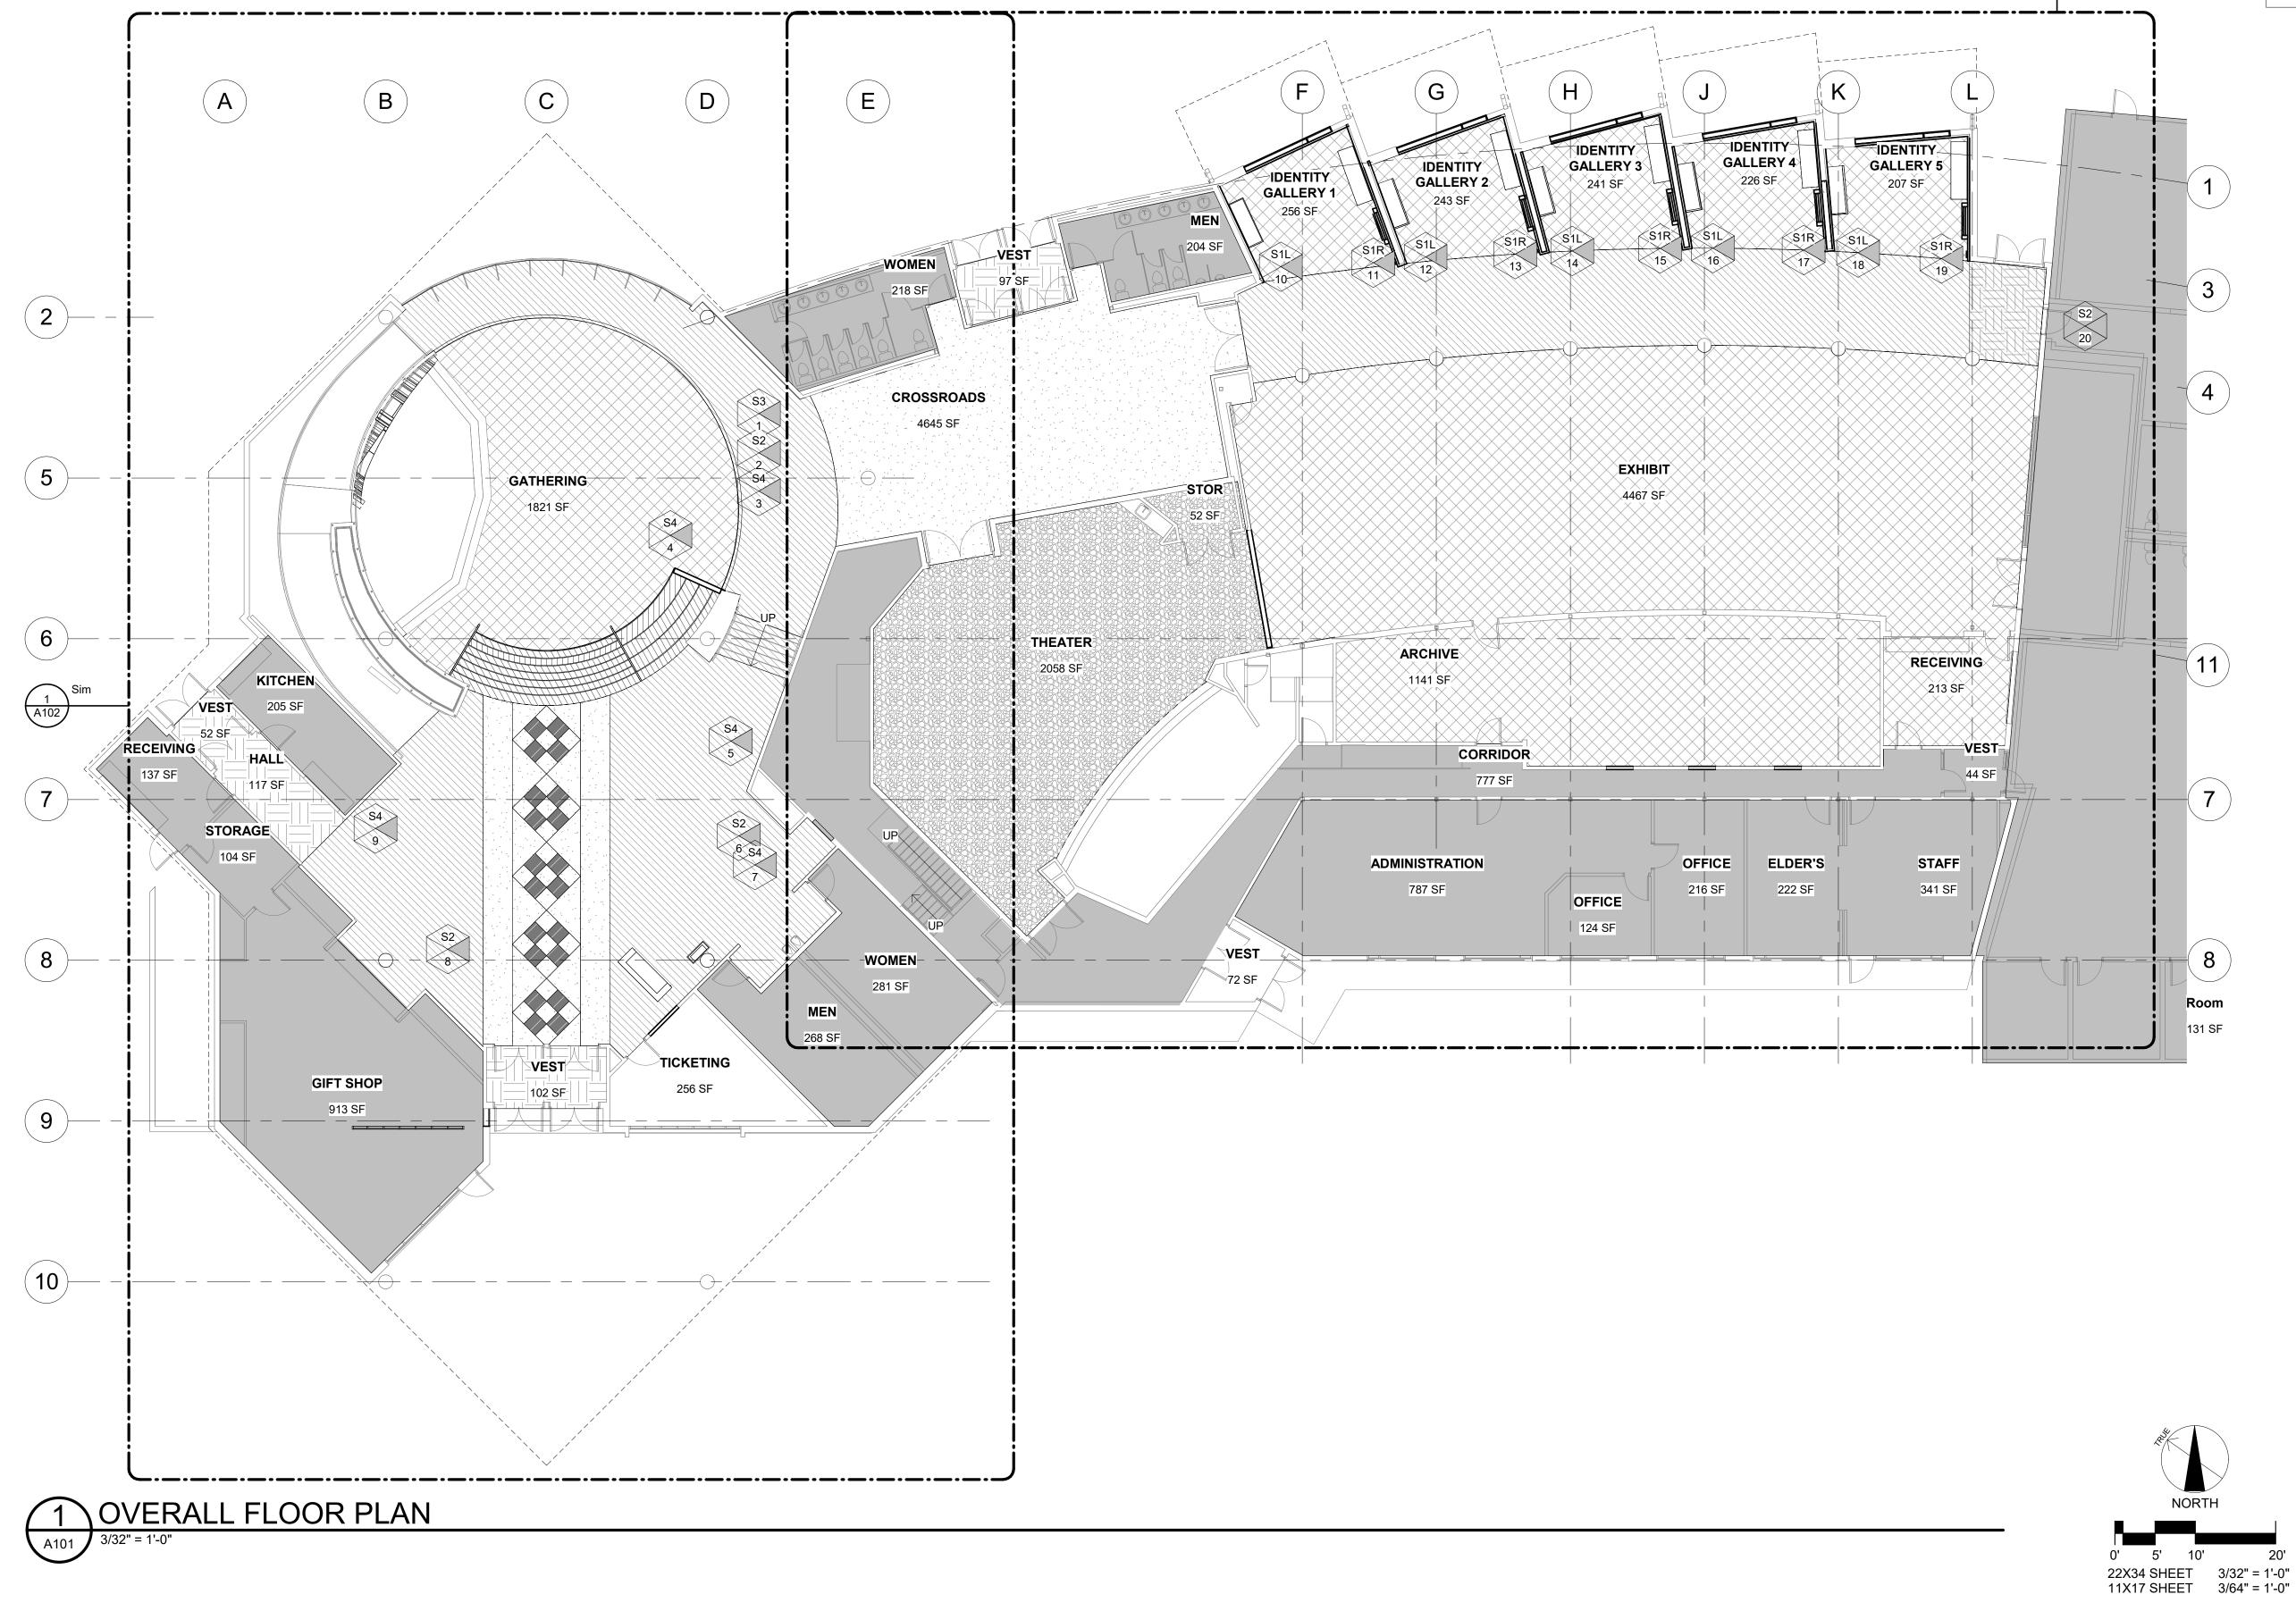

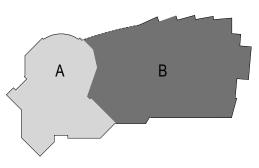

KEY PLAN

SHEET NO.

A101

## OVERALL FLOOR PLAN

8800 Heritage Center Drive, Anchorage, Alaska

BID CONSTRUCTION DOCUMENTS

JOB NO.	2023014
DATE:	10.15.2023
PROJ. MGR.:	Designer
DRAWN BY:	Author

Checker

REVIEWED BY:

**REVISIONS:** 

NATIVE HERITAGE CENTER REMODEL



ALASKA

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X



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F O R:

SUBMITTAL PRICING

## — NEW WALL

EXISTING WALL

? KEY NOTES

1 Sim A103


CPT1 CPT2 RT1 RT2 WOM1


FLOOR PLAN LEGEND

FLOOR FINISH LEGEND

NOT IN SCOPE

FLOOR GRAPHIC

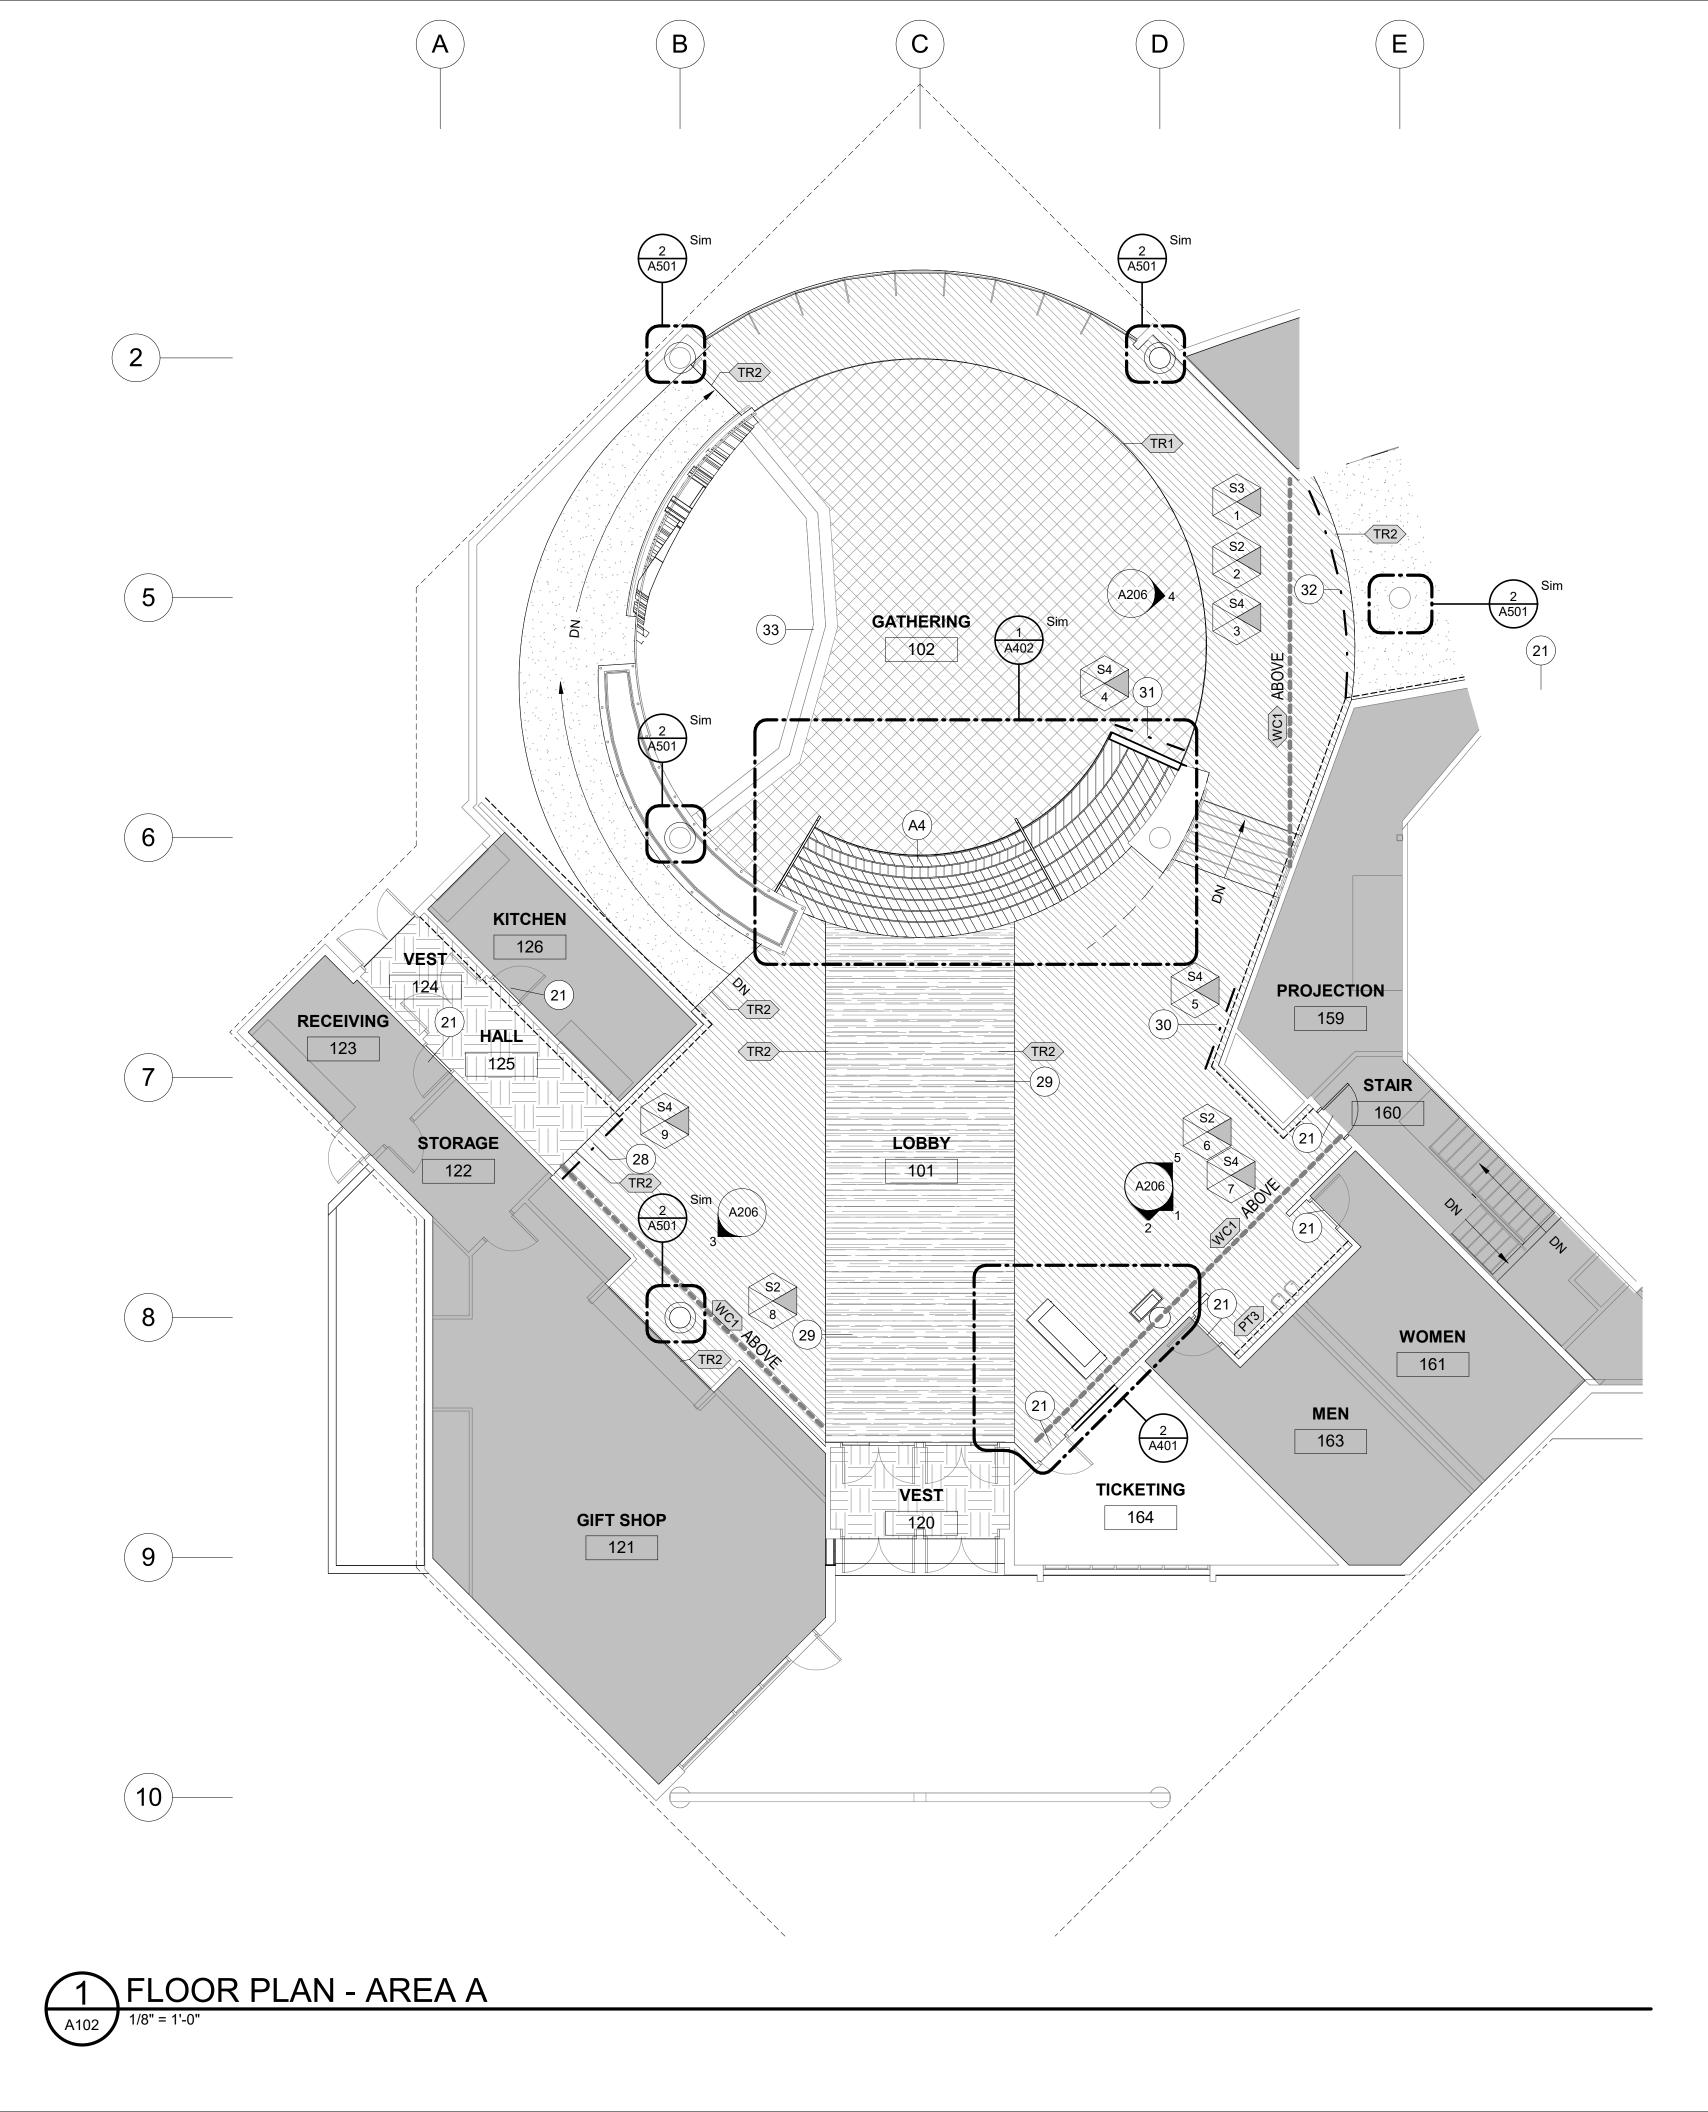

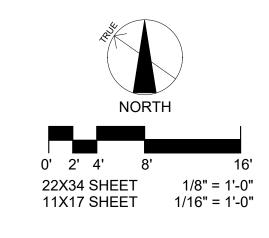

F O R: SUBMITTAL PRICING

## FINISH LEGEND


\* REFER TO SHEET G002 FOR GENERAL NOTES

	NOT IN SCOPE
	CPT1
	CPT2
	CPT3
	RT1
	RT2
	WOM1
	EXISTING FLOOR TO REMAIN
PTX	ACCENT PAINT LOCATION
••••(WC1)>••••	WALL COVERING
<u> </u>	ARTIST GRAPHIC
	NEW WALL
	EXISTING WALL
?	KEY NOTES

PTX

MATRIAL TAG; REFER TO MATERIAL LEGEND FOR MORE INFORMATION


#### SIGNAGE TAG

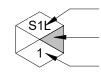

SIGN TYPE SIGNAGE TAG - SIGN REFERENCE NUMBER

## **KEYNOTES**

- 21 PAINT EXISTING DOOR FRAME AT THIS LOCATION PT2
- 28 ARTIST: DAVID ANQUAIAK; CUSTOM DIE CUT GRAPHIC PRINTED TO VINYL.
- 29 ARTIST: TAVA KAIRAIVAK; CUSTOM CARPET PATTERN STILL IN DEVELOPMENT WITH ARTIST AND OWNER. 30 ARTIST: HOLLY; CUSTOM DIE CUT GRAPHIC PRINTED
- TO VINYL. 31 ARTIST: BEN SCHLIEFMAN; CUSTOM DIE CUT
- GRAPHIC PRINTED TO VINYL.
- 32 ARTIST: LALLA WILLIAMS; CUSTOM DIE CUT GRAPHIC PRINTED TO VINYL.
- 33 STAGE TO REMAIN CLEAN AND BRING TO NEW/LIKE CONDITION.

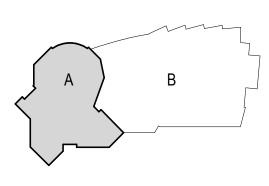

KEY PLAN

**MCG** EXPLORE DESIGN

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ANHC

#### ALASKA NATIVE HERITAGE CENTER REMODEL


8800 Heritage Center Drive, Anchorage, Alaska

## BID CONSTRUCTION DOCUMENTS

JOB NO.	2023014
DATE:	10.15.2023
PROJ. MGR.:	MLP
DRAWN BY:	MLP
REVIEWED BY:	JTW
REVISIONS:	

#### FLOOR PLAN -AREA A



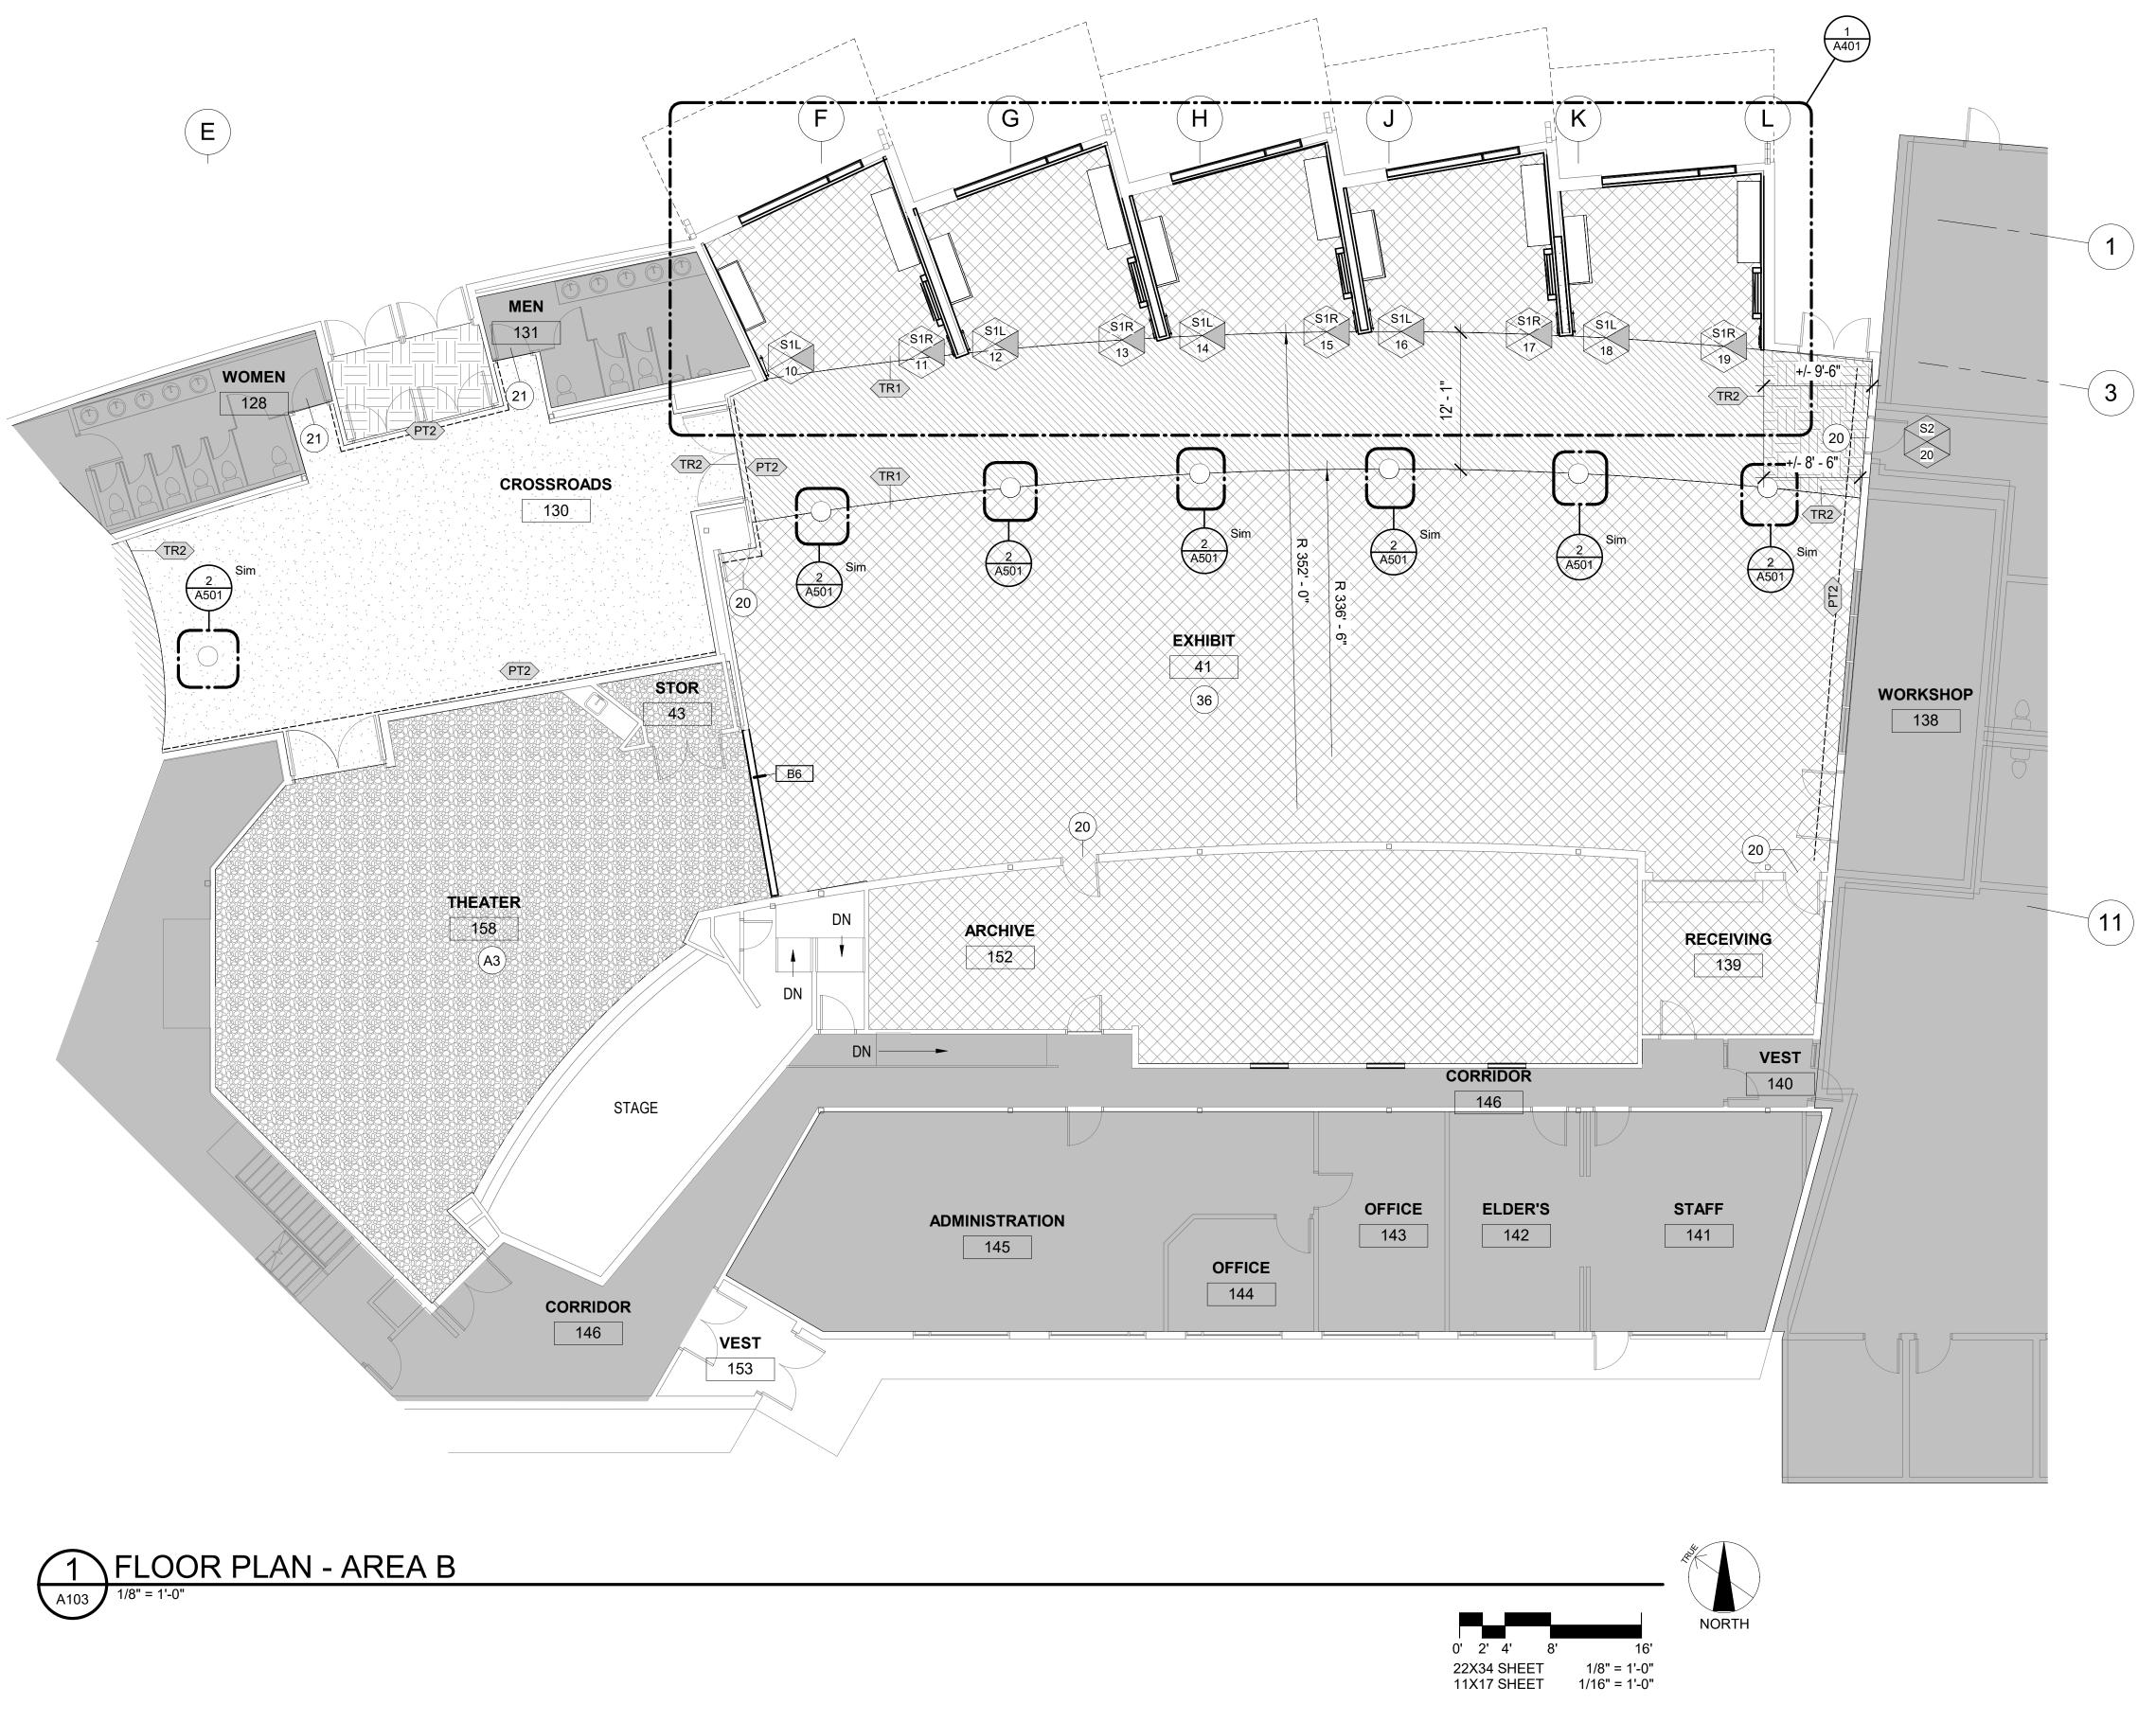



F O R: SUBMITTAL PRICING

## FINISH LEGEND

#### \* REFER TO SHEET G002 FOR GENERAL NOTES

	NOT IN SCOPE
	CPT1
	CPT2
	CPT3
	RT1
	RT2
	WOM1
	EXISTING FLOOR TO REMAIN
PTX	ACCENT PAINT LOCATION
••••WC1>••••	WALL COVERING
<u> </u>	ARTIST GRAPHIC
	NEW WALL
	EXISTING WALL
?	KEY NOTES
PTX	MATRIAL TAG; REFER TO MATERIAL LEGEND FOR MORE INFORMATION


#### SIGNAGE TAG



- SIGN TYPE - SIGNAGE TAG - SIGN REFERENCE NUMBER

## **KEYNOTES**

- 20 PAINT EXISTING DOOR AND FRAME PT2
- 21 PAINT EXISTING DOOR FRAME AT THIS LOCATION PT2
- 36 CONTRACTOR TO COORDINATE WITH OWNER'S CURATOR FOR THE REMOVAL AND RE-INSTALLATION OF EXHIBIT DISPLAYS TO AN OFFSITE LOCATION.
- A3 ADD ALTERNATE 3:THEATRE FINISHES CONSISTING OF NEW WALL PAINT AND CARPET.

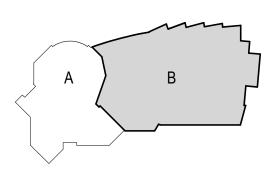

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#### ALASKA NATIVE HERITAGE CENTER REMODEL

8800 Heritage Center Drive, Anchorage, Alaska


BID CONSTRUCTION DOCUMENTS

JOB NO.	2023014
DATE:	10.15.2023
PROJ. MGR.:	MLP
DRAWN BY:	MLP
REVIEWED BY:	JTW
REVISIONS:	

#### FLOOR PLAN -AREA B



KEY PLAN

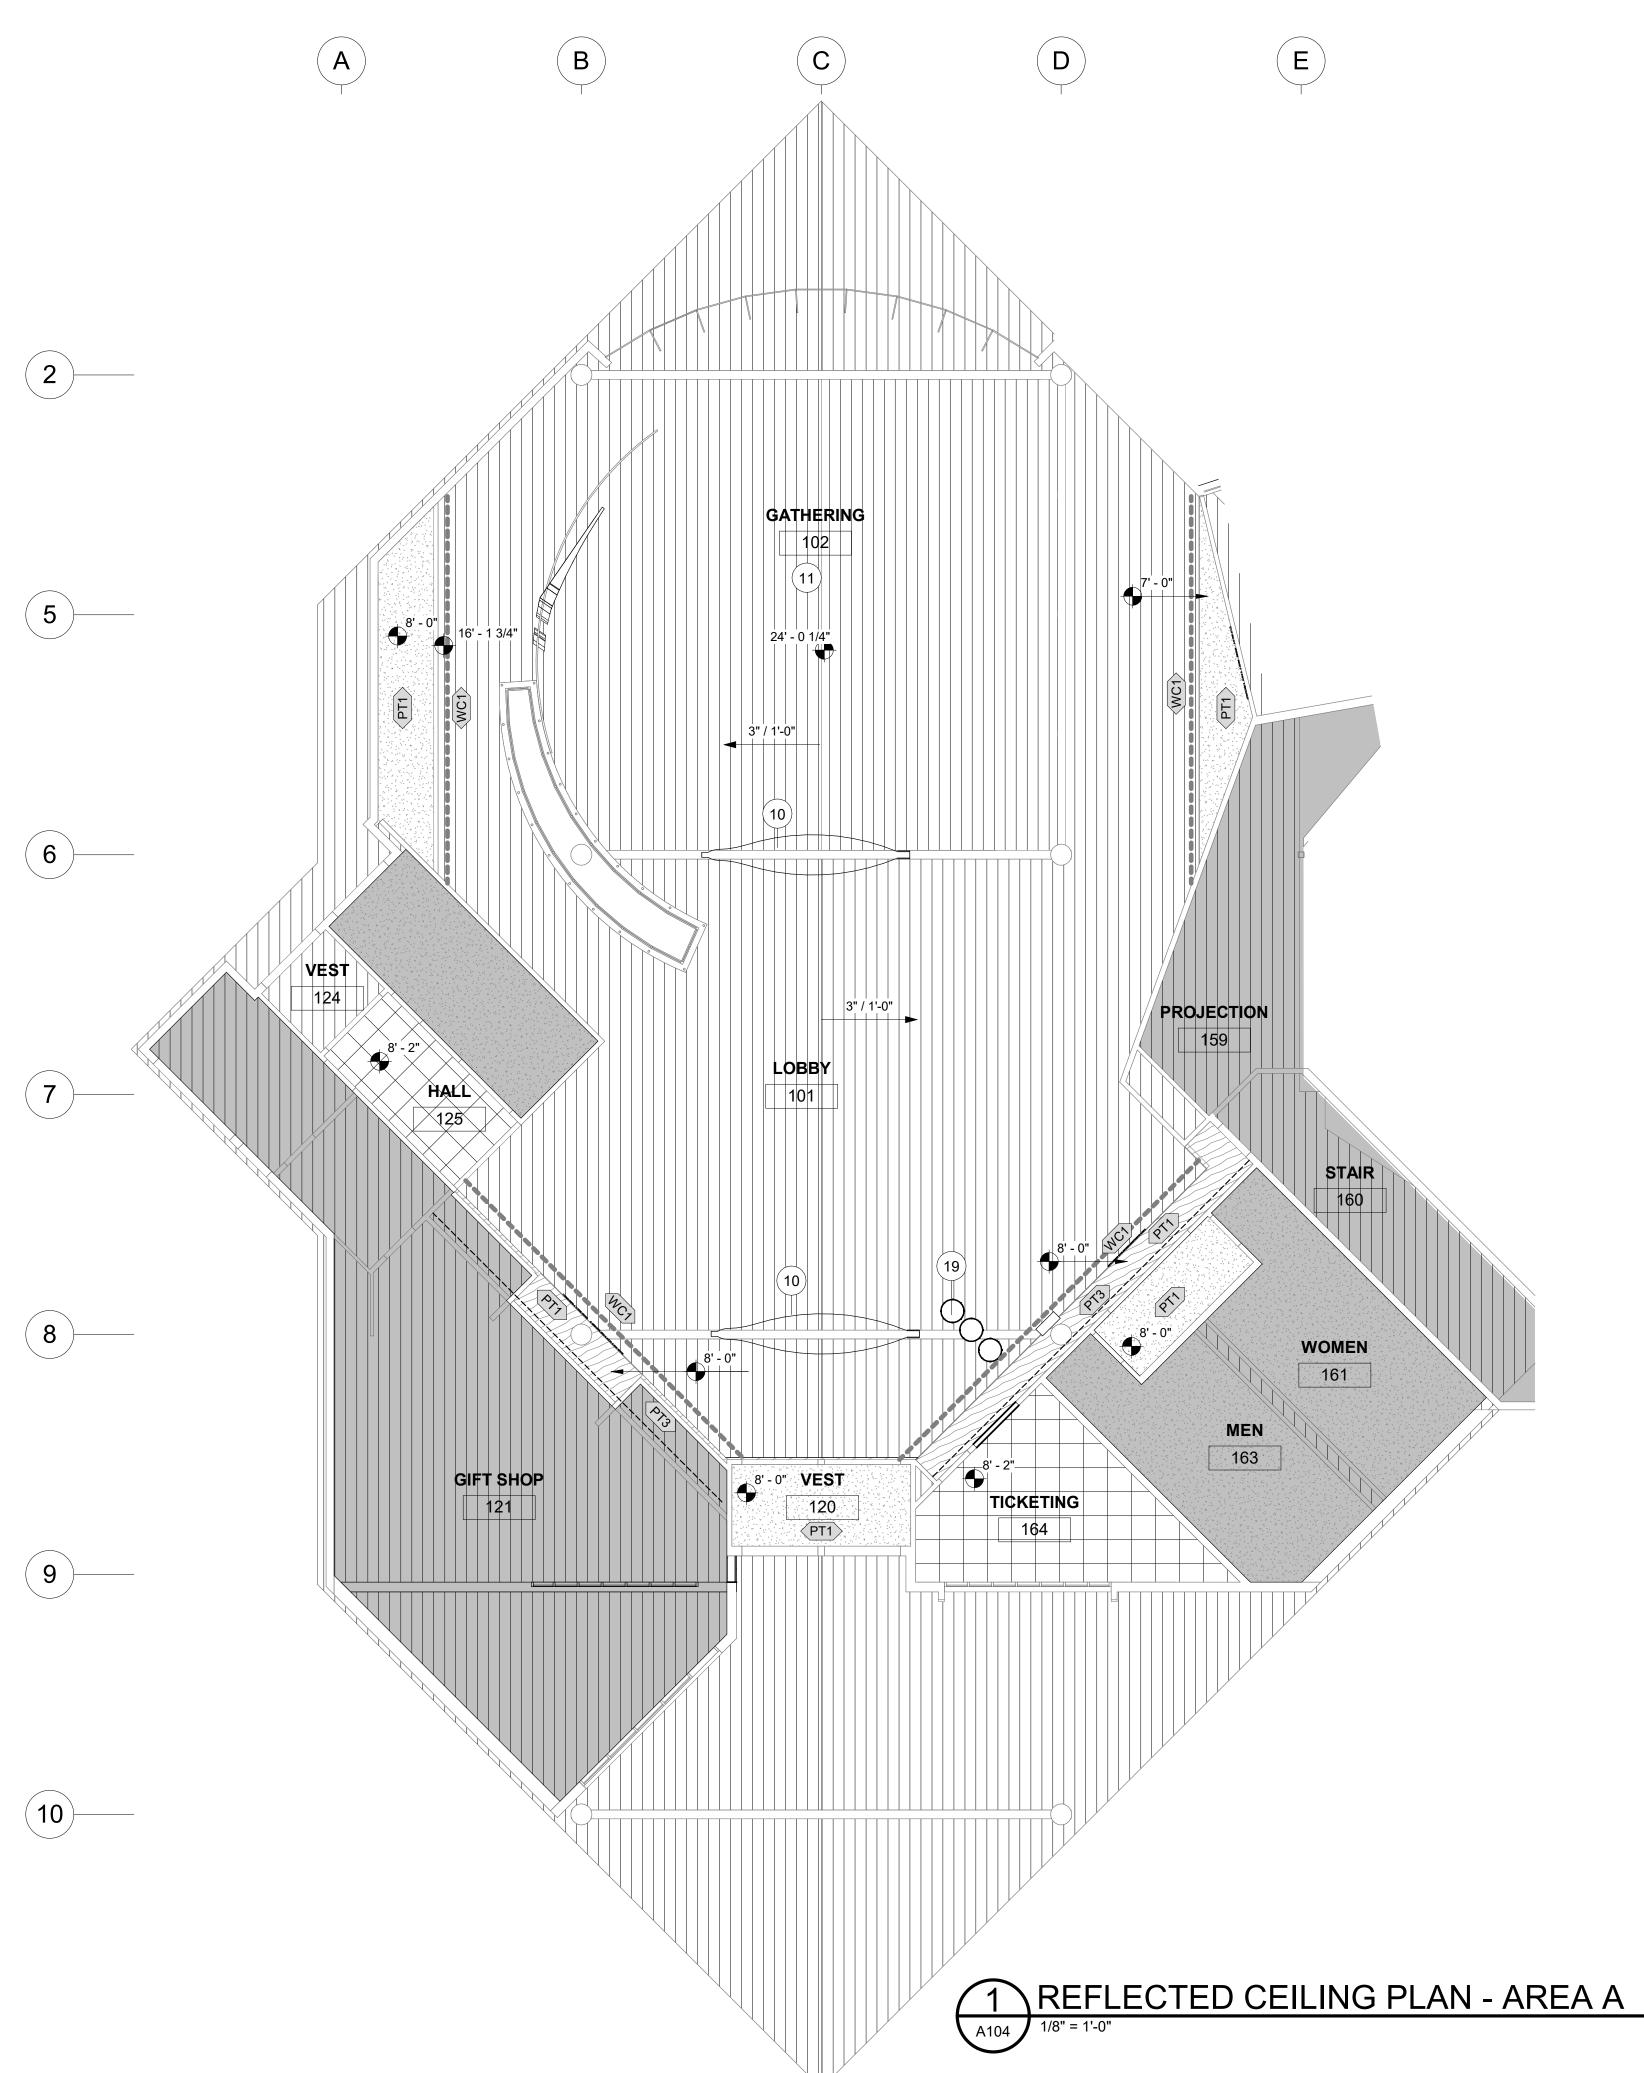







X

**MCG** EXPLORE DESIGN


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×

10242

10.15.2023

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WC1 LOCATION MATERIAL TAG

#### ACCENT LIGHTING LOCATIONS AND LIGHTART COLORS, REFER TO ELECTRICAL FOR MORE INFORMATION

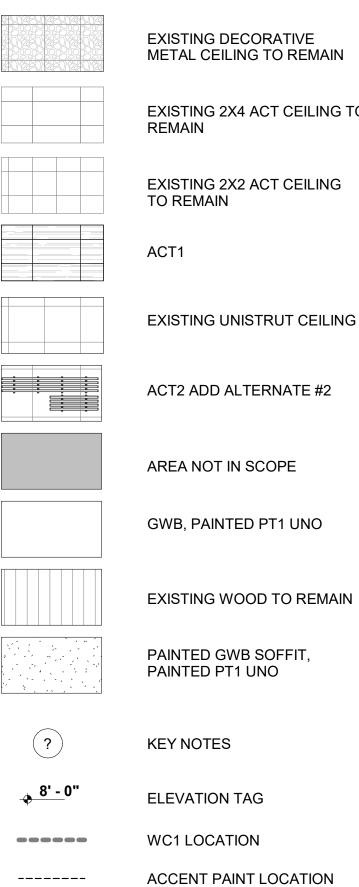



(PT1)



## **KEYNOTES**

- 10 EXISTING BOAT LOCATIONS; COVER AND PROTECT DURING CONSTRUCTION.
- 11 REFER TO ELECTRICAL FOR LIGHTING INFORMATION 19 24" SEAL SKIN LAMPS. REFER TO ELECTRICAL FOR MORE INFORMATION. MOUNT BOTTOM OF PENDANT AT 9' / 9'-6"

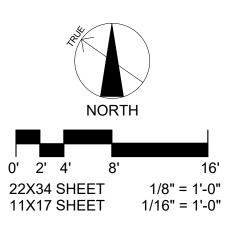

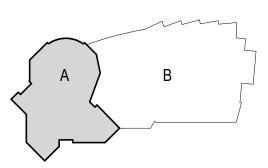

KEY PLAN

## EXISTING DECORATIVE METAL CEILING TO REMAIN

EXISTING 2X4 ACT CEILING TO

EXISTING 2X2 ACT CEILING

EXISTING UNISTRUT CEILING

ACT2 ADD ALTERNATE #2

AREA NOT IN SCOPE

GWB, PAINTED PT1 UNO

#### PAINTED GWB SOFFIT, PAINTED PT1 UNO

- **KEY NOTES**
- ELEVATION TAG
- ACCENT PAINT LOCATION

# REMODEL

8800 Heritage Center Drive, Anchorage, Alaska

## BID CONSTRUCTION DOCUMENTS

JOB NO.	2023014
DATE:	10.15.2023
PROJ. MGR.:	MLP
DRAWN BY:	MLP
REVIEWED BY:	JTW
REVISIONS:	

#### REFLECTED **CEILING PLAN -**AREA A




ANHC

ALASKA

NATIVE

CENTER

HERITAGE

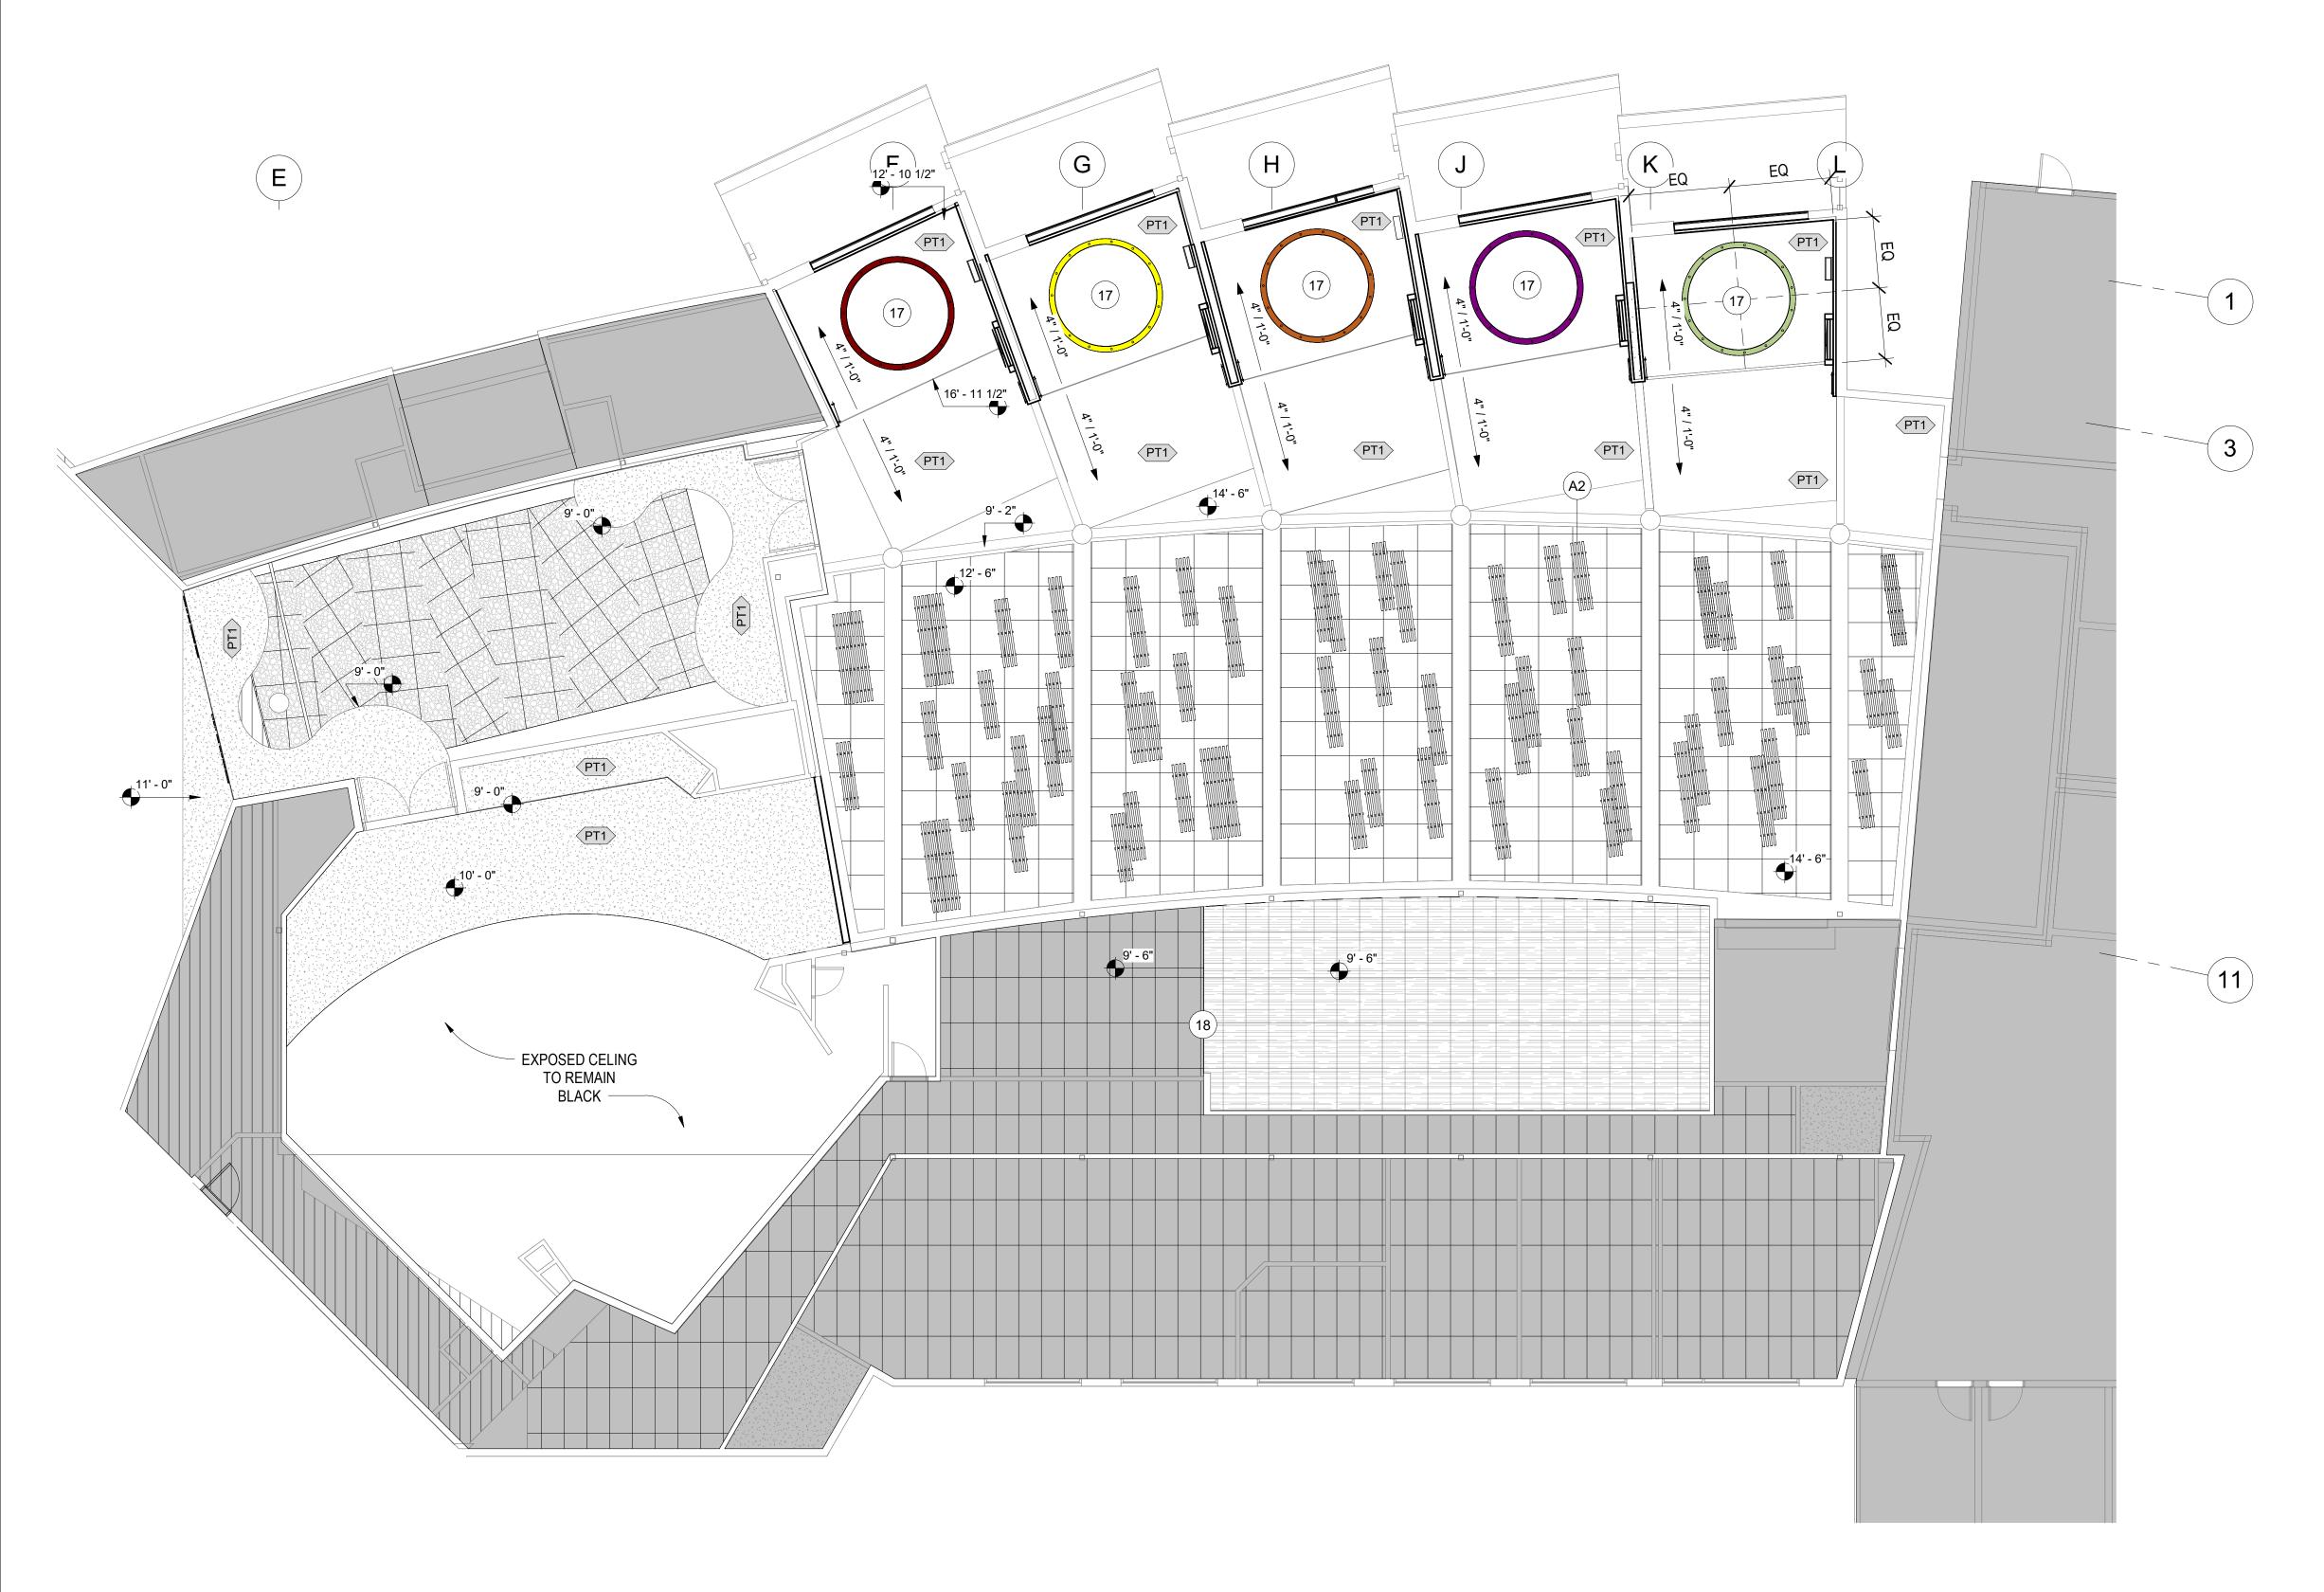





#### 1/8" SCALE, REFER TO INTERIOR FINISH LEGEND FOR MORE INFORMATION

FOR: SUBMITTAL PRICING



?

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-----

PT1

EXISTING DECORATIVE METAL CEILING TO REMAIN

EXISTING 2X4 ACT CEILING TO REMAIN

EXISTING 2X2 ACT CEILING TO REMAIN

ACT1

EXISTING UNISTRUT CEILING

ACT2 ADD ALTERNATE #2

AREA NOT IN SCOPE

GWB, PAINTED PT1 UNO

EXISTING WOOD TO REMAIN

PAINTED GWB SOFFIT, PAINTED PT1 UNO

KEY NOTES


ELEVATION TAG

WC1 LOCATION

ACCENT PAINT LOCATION

MATERIAL TAG


#### ACCENT LIGHTING LOCATIONS AND LIGHTART COLORS, REFER TO ELECTRICAL FOR MORE INFORMATION

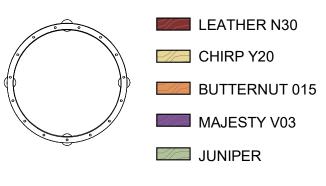


## KEYNOTES

- 17 CENTER LIGHTS IN SPACE
- 18 EXISTING CEILING GRID TO CONNECT TO NEW CEILING GRID AT THIS LOCATION

A2 ADD ALTERNATE 2: WOOD CEILING ACCENT (ACT2). CONTRACTOR TO COORDINATE WITH NICET DESIGN TO APPROVE ANY MODIFICATIONS TO THE EXISTING SPRINKLER SYSTEM AND ADJUST AS NEEDED TO ACCOMMODATE A SMALLER PERCENTAGE OF OPENNESS. FINAL DESIGN LAYOUT WILL NEED TO BE COORDINATED WITH EXISTING ELECTRICAL AND MECHANICAL ITEMS.

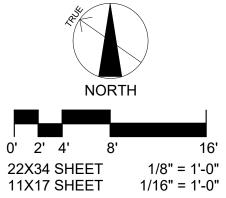

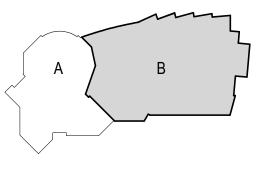

KEY PLAN

**MCG** EXPLORE DESIGN

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ANHC

#### ALASKA NATIVE HERITAGE CENTER REMODEL


8800 Heritage Center Drive, Anchorage, Alaska

BID CONSTRUCTION DOCUMENTS

JOB NO.	2023014
DATE:	10.15.2023
PROJ. MGR.:	MLP
DRAWN BY:	MLP
REVIEWED BY:	JTW
REVISIONS:	

#### REFLECTED CEILING PLAN -AREA B

SHEET NO.

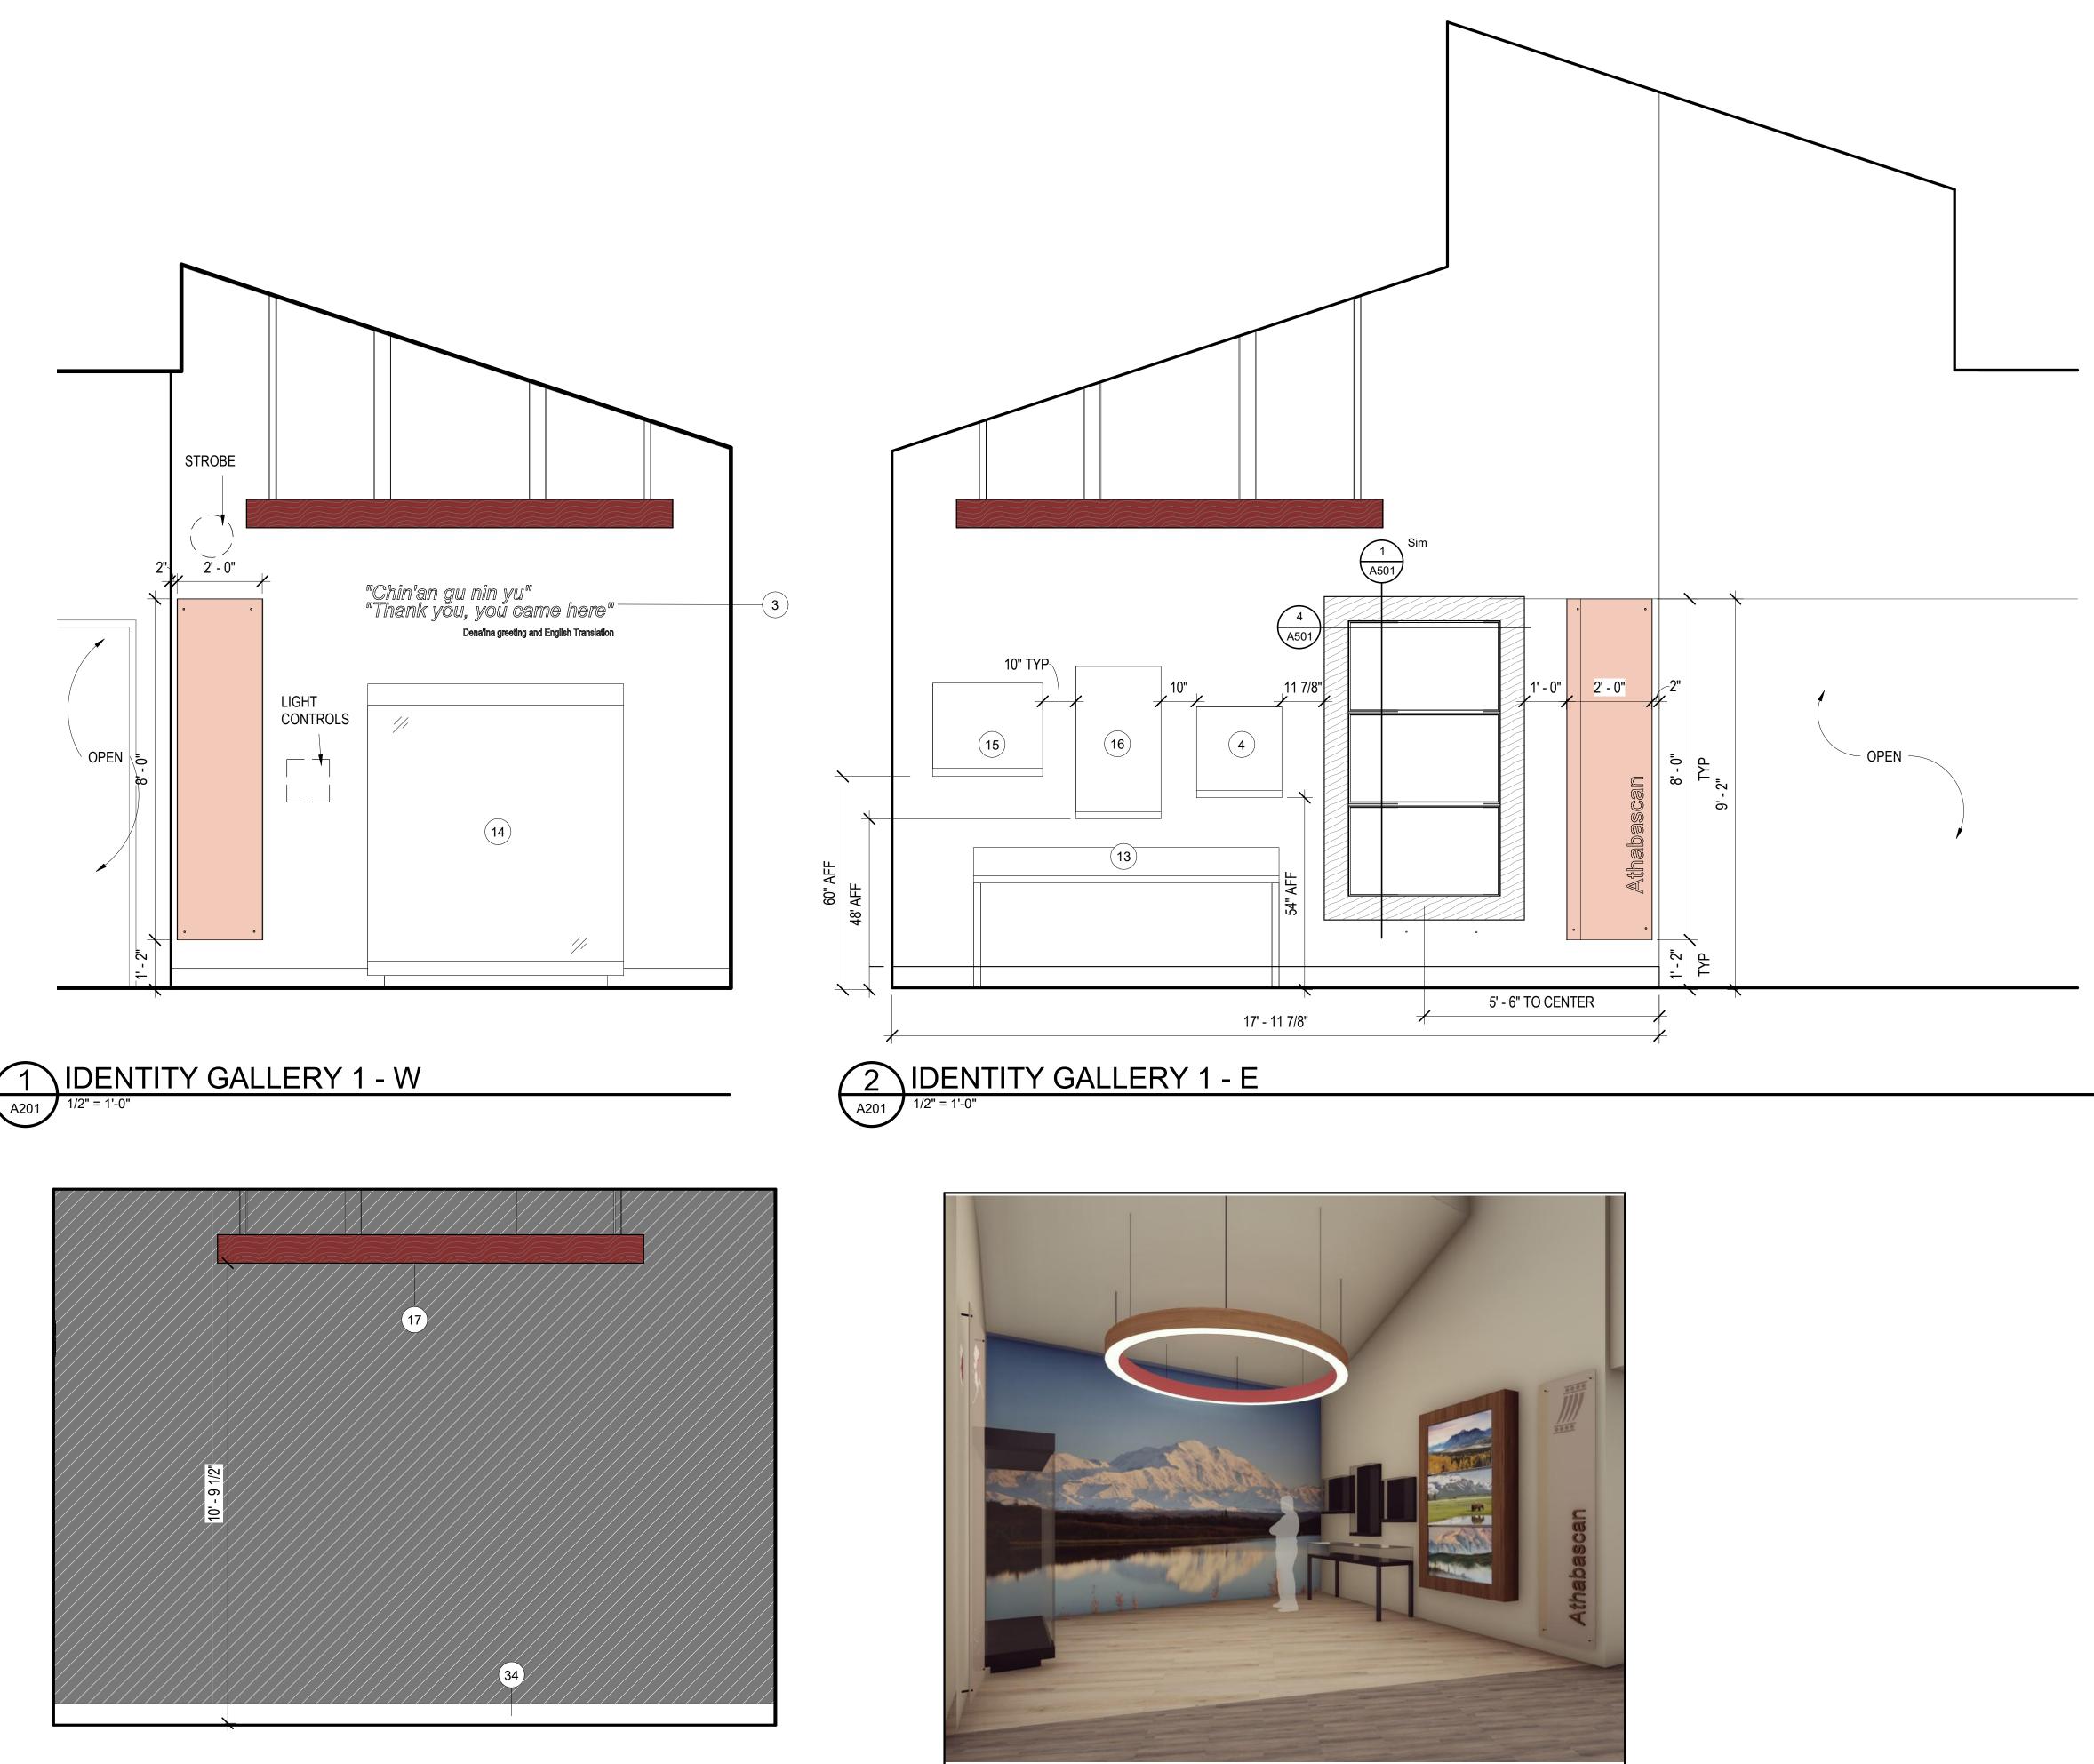





F O R: SUBMITTAL PRICING

## ELEVATION LEGEND

1/2" SCALE. REFER TO FINISH LEGEND FOR SPECIFIED FINISH INFORMATION.

	PT2	<b>DESIGN</b> 421 West 1 <sup>st</sup> Avenue, Suite 300 Anchorage, Alaska 99501 907.563.8474   F 907.563.457:
	PT3	explore design.com
	WC1	
	IDENTITY GALLERY SIGN	49th
	PL1 SHROUD	John T. Weir 5 No. 10242
?	KEY NOTES	10.15.2023
PTX	MATERIAL TAG	ANHC
<b>1</b> i	SPECIALTY EQUIPMENT TAG, CFCI. REFER TO SPECIALTY EQUIPMENT LEGEND	ALASKA
U2	CASEWORK TAG	NATIVE
	INTERIOR COLOR LEATHER N30	HERITAGE CENTER
	INTERIOR COLOR CHIRP Y20	REMODEL
	INTERIOR COLOR BUTTERNUT 015	
	INTERIOR COLOR MAJESTY V03	
	INTERIOR COLOR JUNIPER	

## **KEYNOTES**

- 3 4" H CUT VINYL GRAPHIC QUOTE & 2" H CUT VINYL GRAPHIC TRANSLATION
- 4 WALL MOUNTED DISPLAY CASE. BASIS OF DESIGN ZONE ZW-102. SIZE 2'W X 2'H X 6"D. ANTI-GLARE UV LAMINATED GLASS, OPENING WITH HINGES, HIGH SECURITY CAM LOCK, LED LIGHT BAR AND DESICCANT COMPARTMENT. POWDER COAT BLACK FINISH.
- 13 TABLE CASE ON LEGS WITH HINGED OPENING. BASIS OF DESIGN, ZONE ZT-101. SIZE: 7'W X 2'D X 2'10" H. PROVIDE 10" HIGH GLASS BONNET WITH ANTI GLARE UV LAMINATED GLASS, HIGH SECURITY CAM LOCK(S), AND EXHIBITION DRAWERS. BLACK POWDER COAT.
- 14 FREESTANDING DISPLAY CASE WITH EXHIBITION DRAWERS. BASIS OF DESIGN: ZONE ZF-101D. SIZE: 6'W X 2'D X 7'H. ANTI-GLARE UV LAMINATE GLASS, LED LIGHT BAR, 3 SHELVES. BLACK POWDER COAT FINISHES.
- 15 WALL MOUNTED DISPLAY CASE. BASIS OF DESIGN ZONE ZW-102. SIZE 2'-6"W X 2'H X 6"D. ANTI-GLARE UV LAMINATED GLASS, OPENING WITH HINGES, HIGH SECURITY CAM LOCK, LED LIGHT BAR AND DESICCANT COMPARTMENT. POWDER COAT BLACK FINISH.
- 16 WALL MOUNTED DISPLAY CASE. BASIS OF DESIGN ZONE ZW-102. SIZE 2'W X 3' - 6"H X 6"D. ANTI-GLARE UV LAMINATED GLASS, OPENING WITH HINGES, HIGH SECURITY CAM LOCK, LED LIGHT BAR AND DESICCANT COMPARTMENT. POWDER COAT BLACK FINISH.
- 17 CENTER LIGHTS IN SPACE
- 34 BASE BOARD HEAT, REFER TO MECHANICAL FOR MORE INFORMATION.






8800 Heritage Center Drive,
Anchorage, Alaska


**BID CONSTRUCTION** DOCUMENTS

JOB NO.	2023014
DATE:	10.15.2023
PROJ. MGR.:	MLP
DRAWN BY:	MLP
REVIEWED BY:	JTW
REVISIONS:	

INTERIOR **ELEVATIONS** -IDENTITY GALLERY 1

SHEET NO.

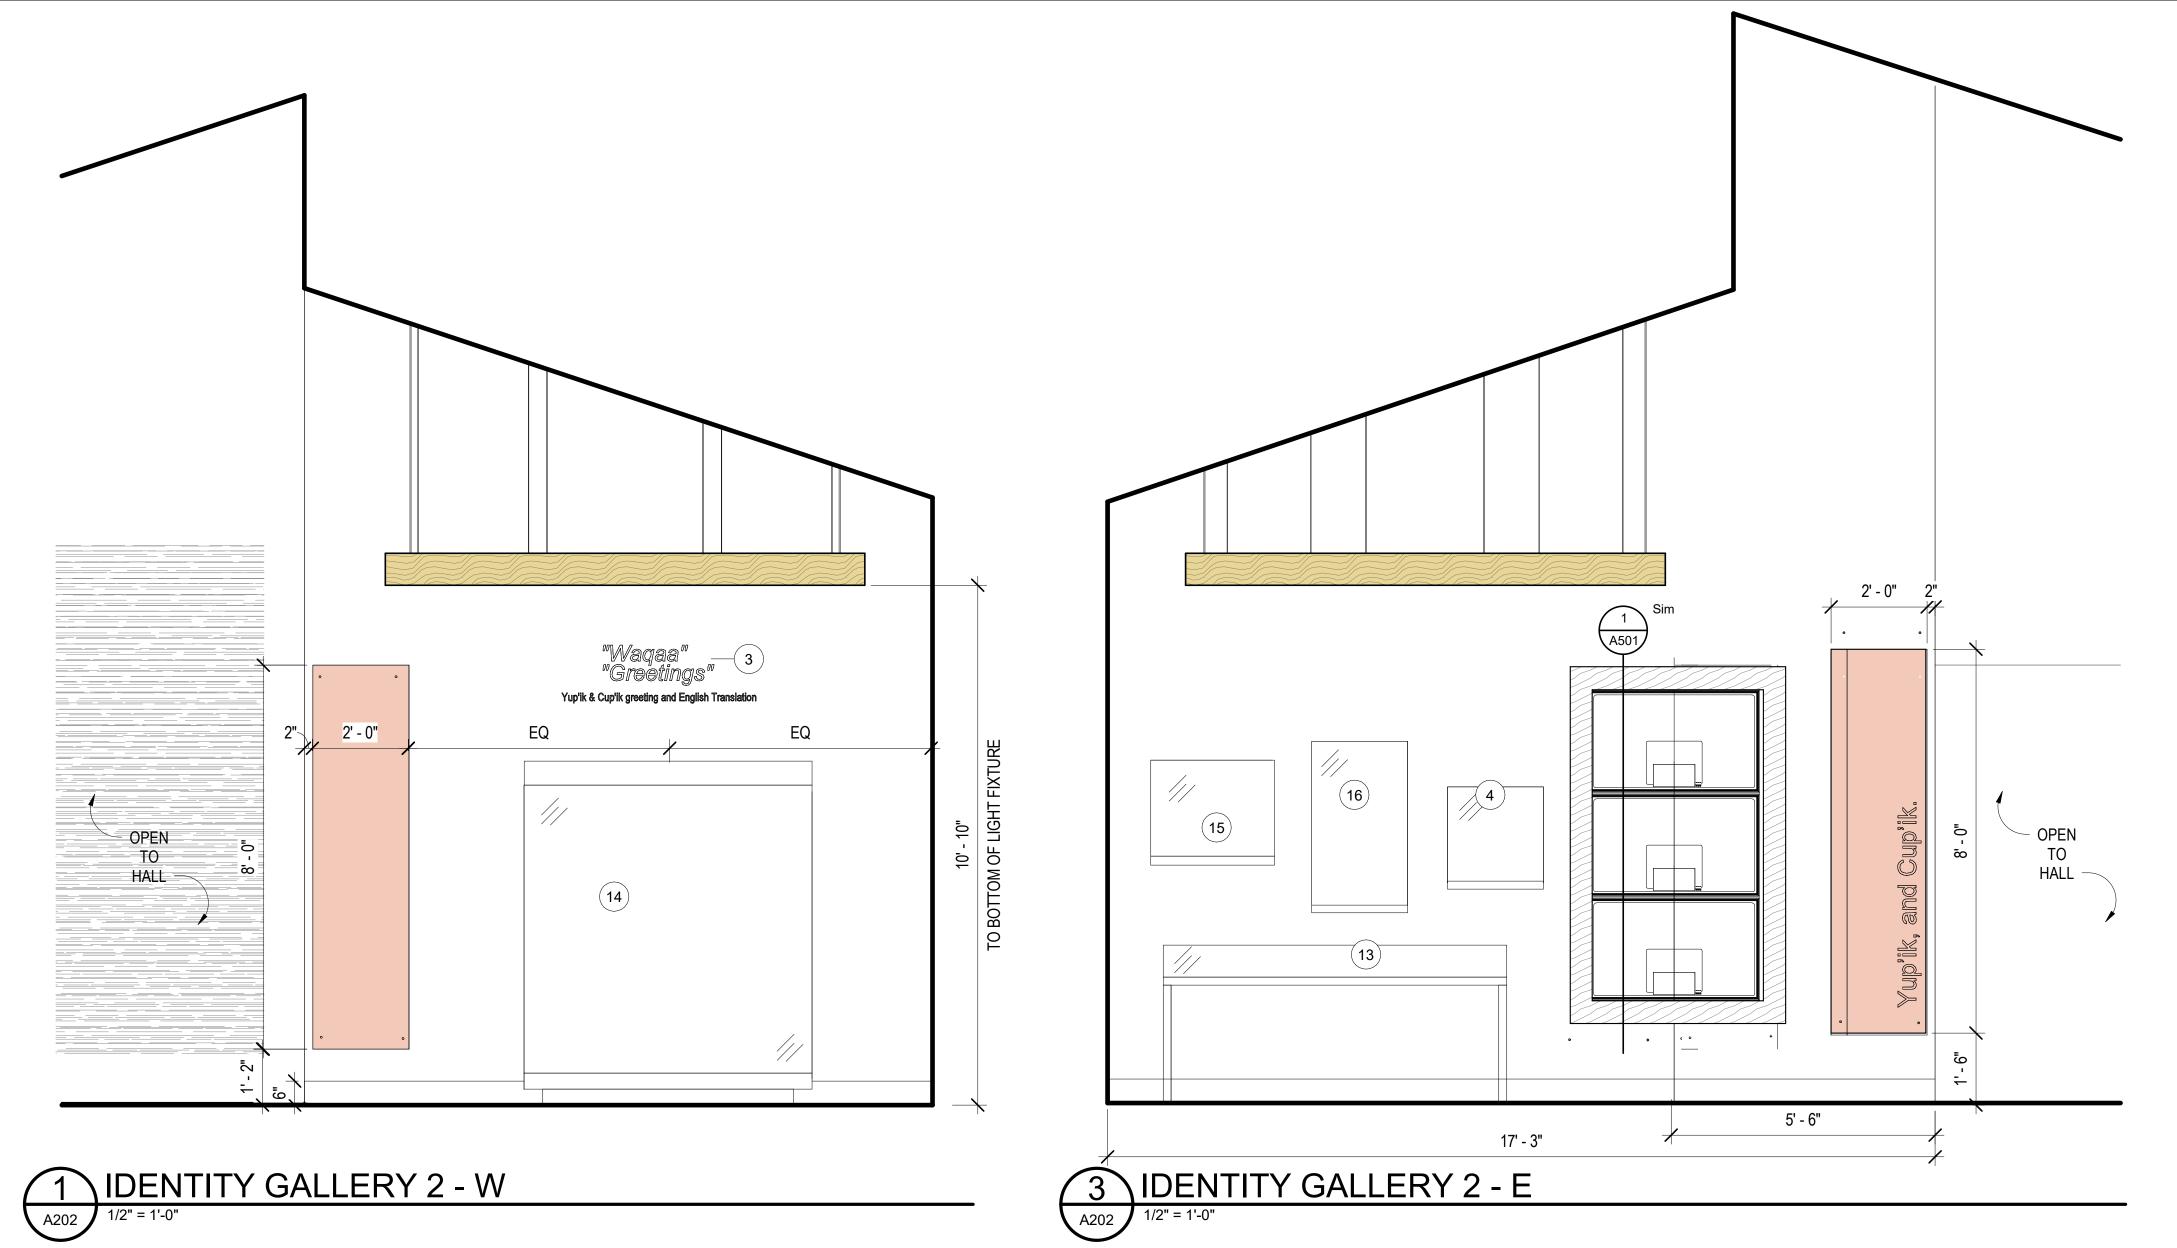

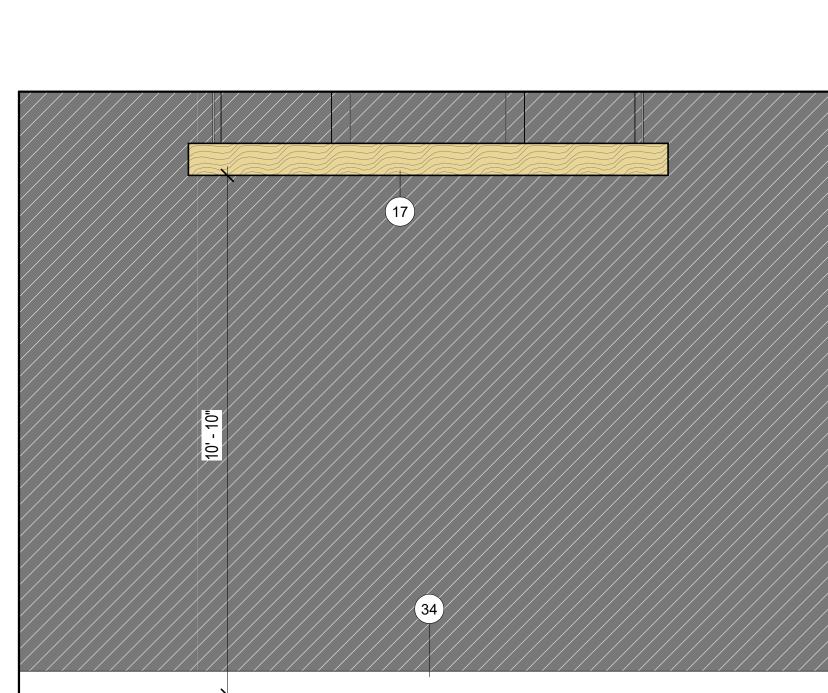





RENDER

F O R: SUBMITTAL PRICING

## **ELEVATION LEGEND**

1/2" SCALE. REFER TO FINISH LEGEND FOR SPECIFIED FINISH INFORMATION.

	PT2
	PT3
	WC1
	IDENTITY GALLERY SIGN
	PL1 SHROUD
?	KEY NOTES
PTX	MATERIAL TAG
1i	SPECIALTY EQUIPMENT TAG, CFCI. REFER TO SPECIALTY EQUIPMENT LEGEND
U2	CASEWORK TAG
	INTERIOR COLOR LEATHER N30
	INTERIOR COLOR CHIRP Y20
	INTERIOR COLOR BUTTERNUT 015
	INTERIOR COLOR MAJESTY V03
	INTERIOR COLOR JUNIPER

## KEYNOTES

- 3 4" H CUT VINYL GRAPHIC QUOTE & 2" H CUT VINYL GRAPHIC TRANSLATION
- 4 WALL MOUNTED DISPLAY CASE. BASIS OF DESIGN ZONE ZW-102. SIZE 2'W X 2'H X 6"D. ANTI-GLARE UV LAMINATED GLASS, OPENING WITH HINGES, HIGH SECURITY CAM LOCK, LED LIGHT BAR AND DESICCANT COMPARTMENT. POWDER COAT BLACK FINISH.
- 13 TABLE CASE ON LEGS WITH HINGED OPENING. BASIS OF DESIGN, ZONE ZT-101. SIZE: 7'W X 2'D X 2'10" H. PROVIDE 10" HIGH GLASS BONNET WITH ANTI GLARE UV LAMINATED GLASS, HIGH SECURITY CAM LOCK(S), AND EXHIBITION DRAWERS. BLACK POWDER COAT.
- 14 FREESTANDING DISPLAY CASE WITH EXHIBITION DRAWERS. BASIS OF DESIGN: ZONE ZF-101D. SIZE: 6'W X 2'D X 7'H. ANTI-GLARE UV LAMINATE GLASS, LED LIGHT BAR, 3 SHELVES. BLACK POWDER COAT FINISHES.
- 15 WALL MOUNTED DISPLAY CASE. BASIS OF DESIGN ZONE ZW-102. SIZE 2'-6"W X 2'H X 6"D. ANTI-GLARE UV LAMINATED GLASS, OPENING WITH HINGES, HIGH SECURITY CAM LOCK, LED LIGHT BAR AND DESICCANT COMPARTMENT. POWDER COAT BLACK FINISH.
- 16 WALL MOUNTED DISPLAY CASE. BASIS OF DESIGN ZONE ZW-102. SIZE 2'W X 3' - 6"H X 6"D. ANTI-GLARE UV LAMINATED GLASS, OPENING WITH HINGES, HIGH SECURITY CAM LOCK, LED LIGHT BAR AND DESICCANT COMPARTMENT. POWDER COAT BLACK FINISH.
- 17 CENTER LIGHTS IN SPACE
- 34 BASE BOARD HEAT, REFER TO MECHANICAL FOR MORE INFORMATION.



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#### ALASKA NATIVE HERITAGE CENTER REMODEL


8800 Heritage Center Drive, Anchorage, Alaska

#### **BID CONSTRUCTION** DOCUMENTS

JOB NO.	2023014
DATE:	10.15.2023
PROJ. MGR.:	MLP
DRAWN BY:	MLP
REVIEWED BY:	JTW
REVISIONS:	

INTERIOR **ELEVATIONS** -IDENTITY GALLERY 2

SHEET NO.

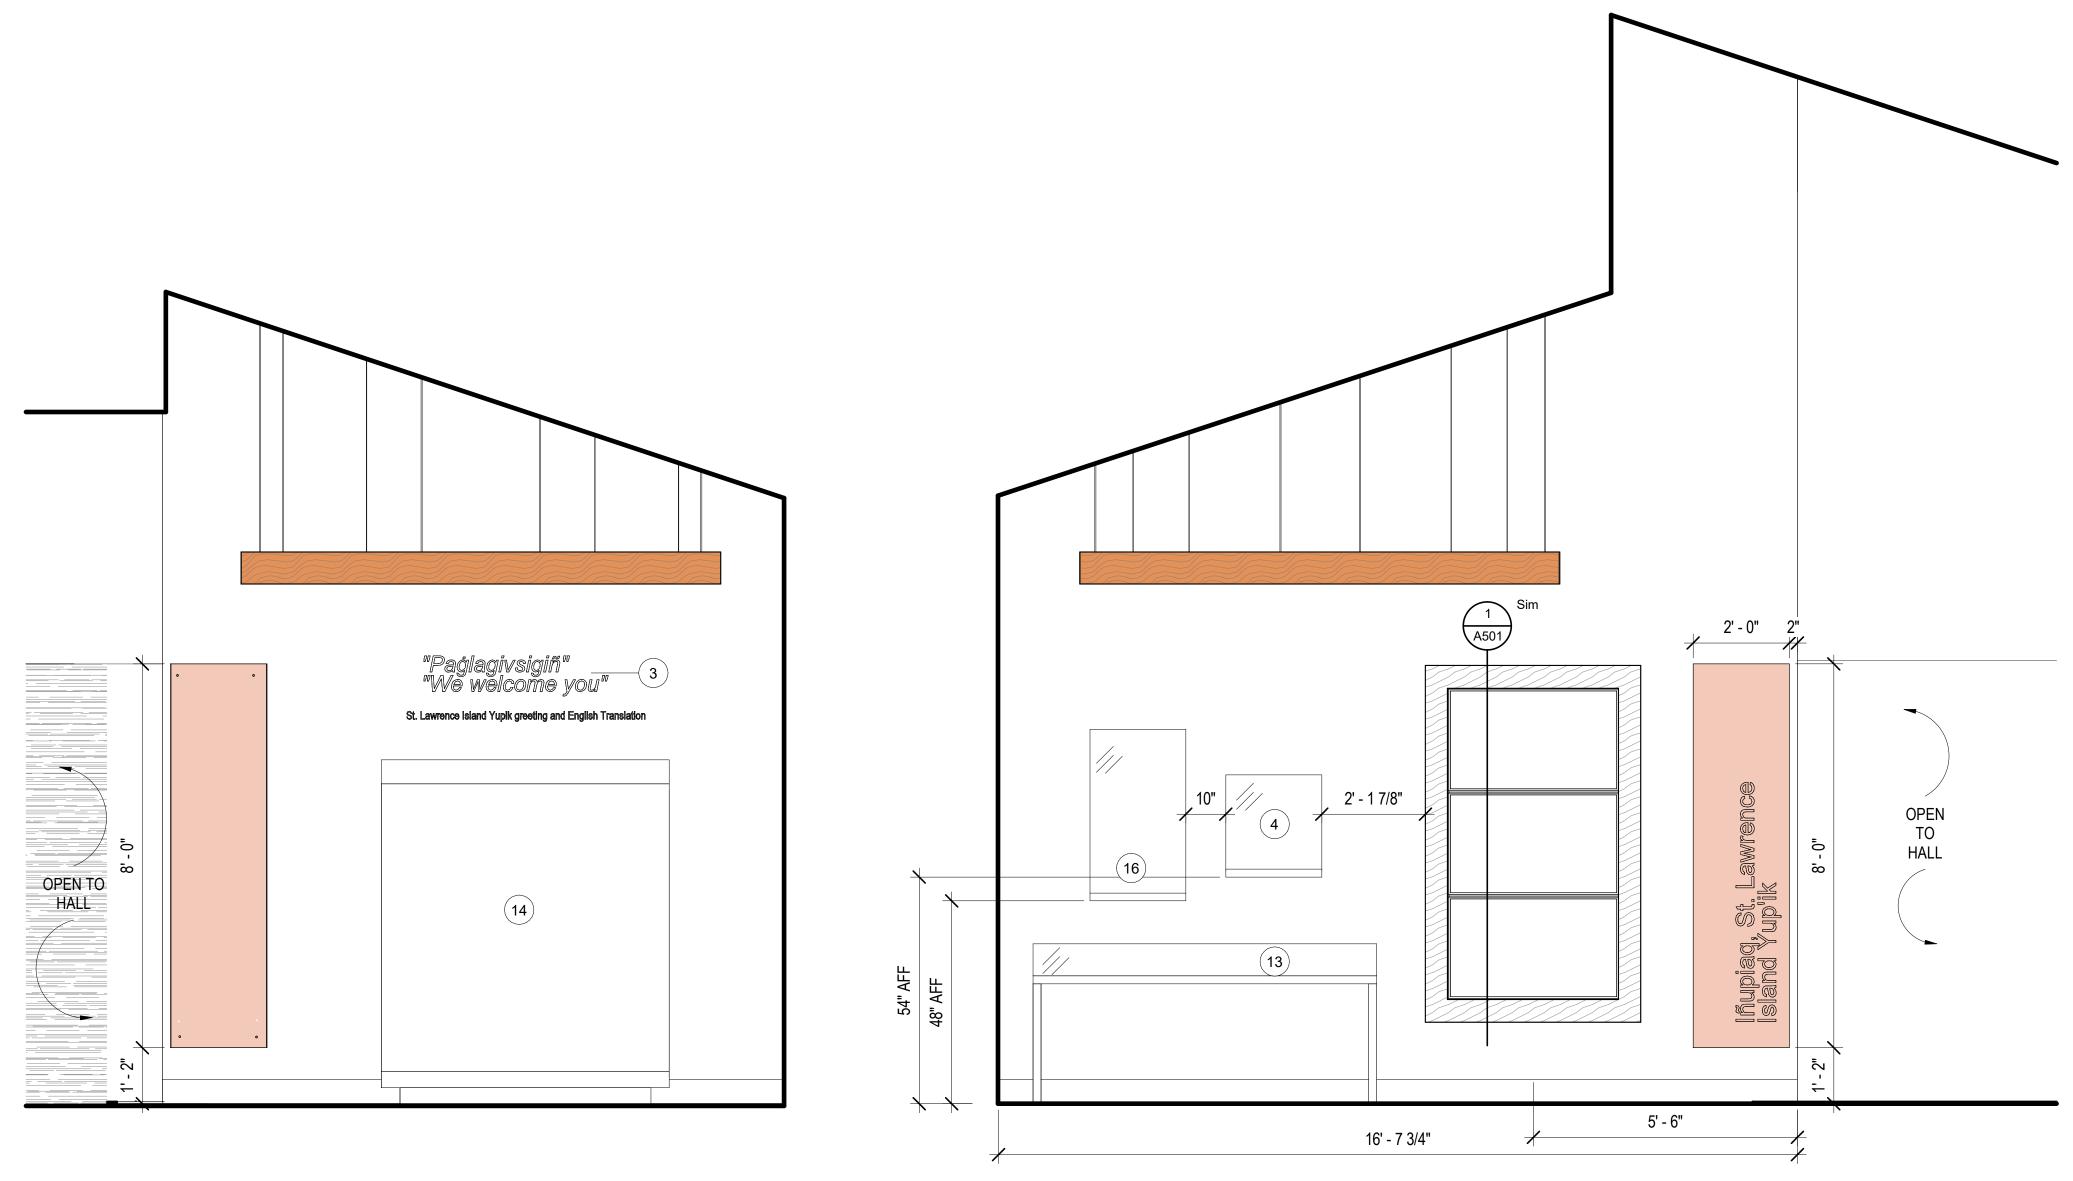


A203 / 1/2" = 1'-0"



IDENTITY GALLERY 3 - N

2 A203

1/2" = 1'-0"

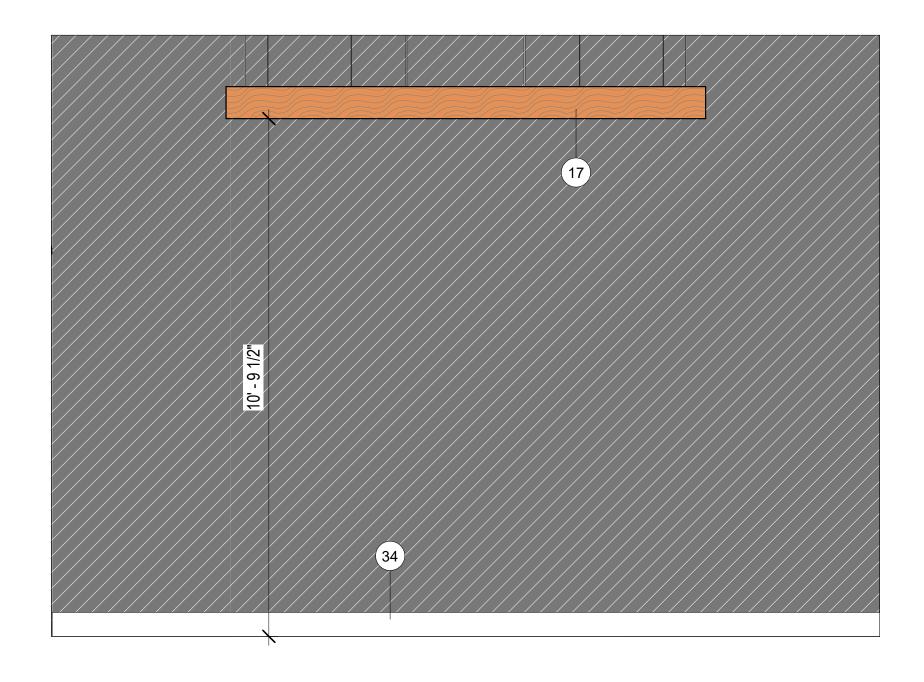



RENDER

<u>3</u> IDENTITY GALLERY 3 - E

F O R: SUBMITTAL PRICING

## ELEVATION LEGEND

1/2" SCALE. REFER TO FINISH LEGEND FOR SPECIFIED FINISH INFORMATION.

	PT2	42 An 90 <b>ex</b>
	PT3	
	WC1	H
	IDENTITY GALLERY SIGN	
	PL1 SHROUD	
?	KEY NOTES	
PTX	MATERIAL TAG	ANI
<u>1i</u>	SPECIALTY EQUIPMENT TAG, CFCI. REFER TO SPECIALTY EQUIPMENT LEGEND	AL N <i>A</i>
U2	CASEWORK TAG	HE
	INTERIOR COLOR LEATHER N30	CE
	INTERIOR COLOR CHIRP Y20	RE
	INTERIOR COLOR BUTTERNUT 015	
	INTERIOR COLOR MAJESTY V03	
	INTERIOR COLOR JUNIPER	8800

## KEYNOTES

- 3 4" H CUT VINYL GRAPHIC QUOTE & 2" H CUT VINYL GRAPHIC TRANSLATION
- 4 WALL MOUNTED DISPLAY CASE. BASIS OF DESIGN ZONE ZW-102. SIZE 2'W X 2'H X 6"D. ANTI-GLARE UV LAMINATED GLASS, OPENING WITH HINGES, HIGH SECURITY CAM LOCK, LED LIGHT BAR AND DESICCANT COMPARTMENT. POWDER COAT BLACK FINISH.
- 13 TABLE CASE ON LEGS WITH HINGED OPENING. BASIS OF DESIGN, ZONE ZT-101. SIZE: 7'W X 2'D X 2'10" H. PROVIDE 10" HIGH GLASS BONNET WITH ANTI GLARE UV LAMINATED GLASS, HIGH SECURITY CAM LOCK(S), AND EXHIBITION DRAWERS. BLACK POWDER COAT.
- 14 FREESTANDING DISPLAY CASE WITH EXHIBITION DRAWERS. BASIS OF DESIGN: ZONE ZF-101D. SIZE: 6'W X 2'D X 7'H. ANTI-GLARE UV LAMINATE GLASS, LED LIGHT BAR, 3 SHELVES. BLACK POWDER COAT FINISHES.
- 16 WALL MOUNTED DISPLAY CASE. BASIS OF DESIGN ZONE ZW-102. SIZE 2'W X 3' - 6"H X 6"D. ANTI-GLARE UV LAMINATED GLASS, OPENING WITH HINGES, HIGH SECURITY CAM LOCK, LED LIGHT BAR AND DESICCANT COMPARTMENT. POWDER COAT BLACK FINISH.
- 17 CENTER LIGHTS IN SPACE
- 34 BASE BOARD HEAT, REFER TO MECHANICAL FOR MORE INFORMATION.

# **MCG** EXPLORE DESIGN

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HC

#### LASKA ATIVE ERITAGE ENTER EMODEL


) Heritage Center Drive, Anchorage, Alaska

#### **BID CONSTRUCTION** DOCUMENTS


JOB NO.	2023014
DATE:	10.15.2023
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DRAWN BY:	MLP
REVIEWED BY:	JTW
REVISIONS:	

#### INTERIOR **ELEVATIONS** -IDENTITY GALLERY 3

SHEET NO. A203

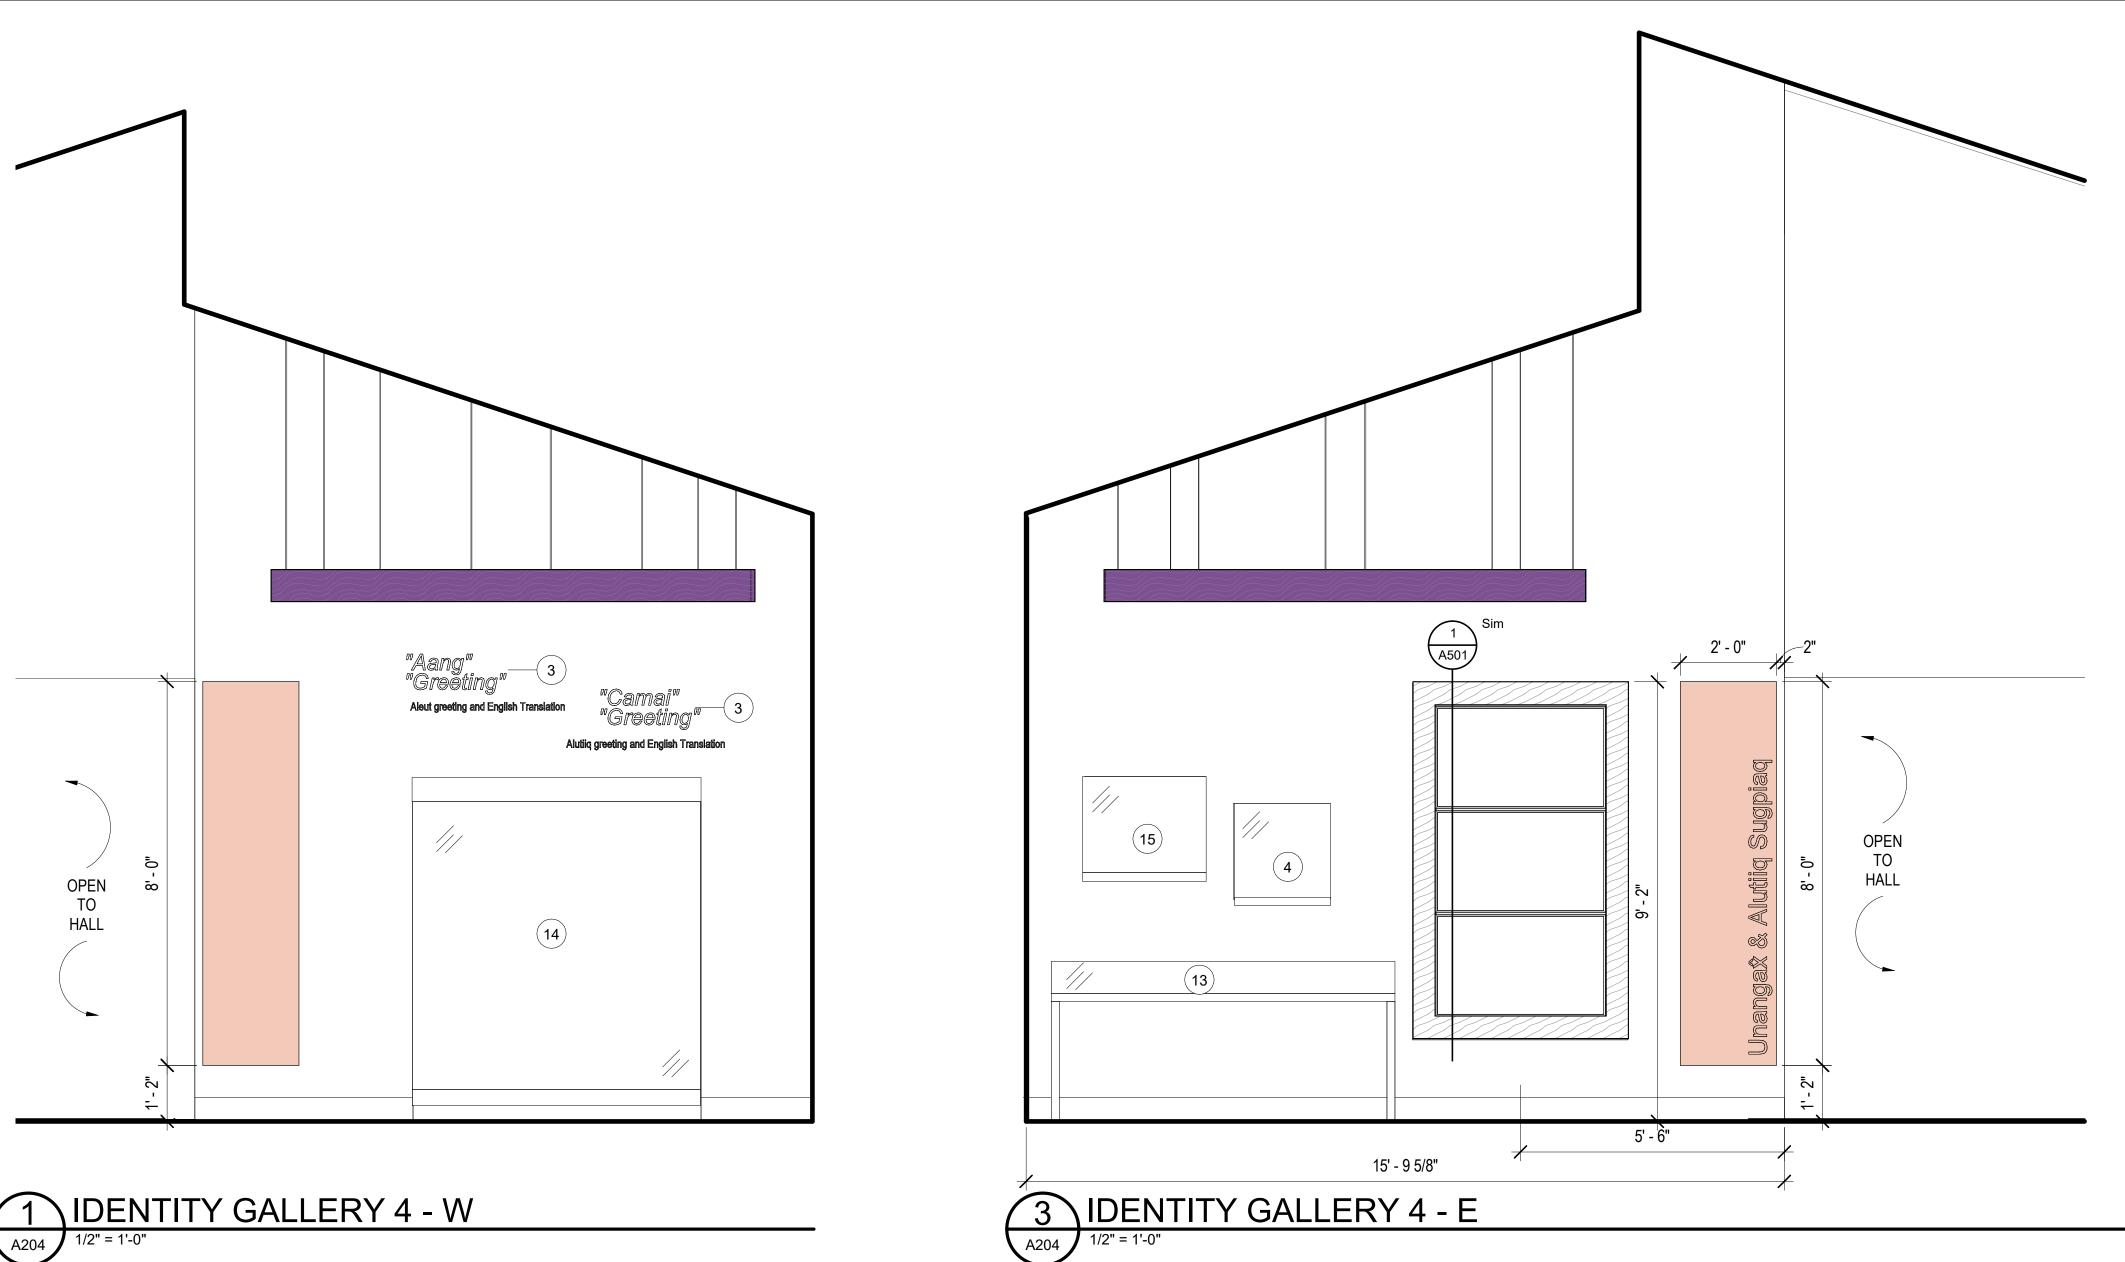



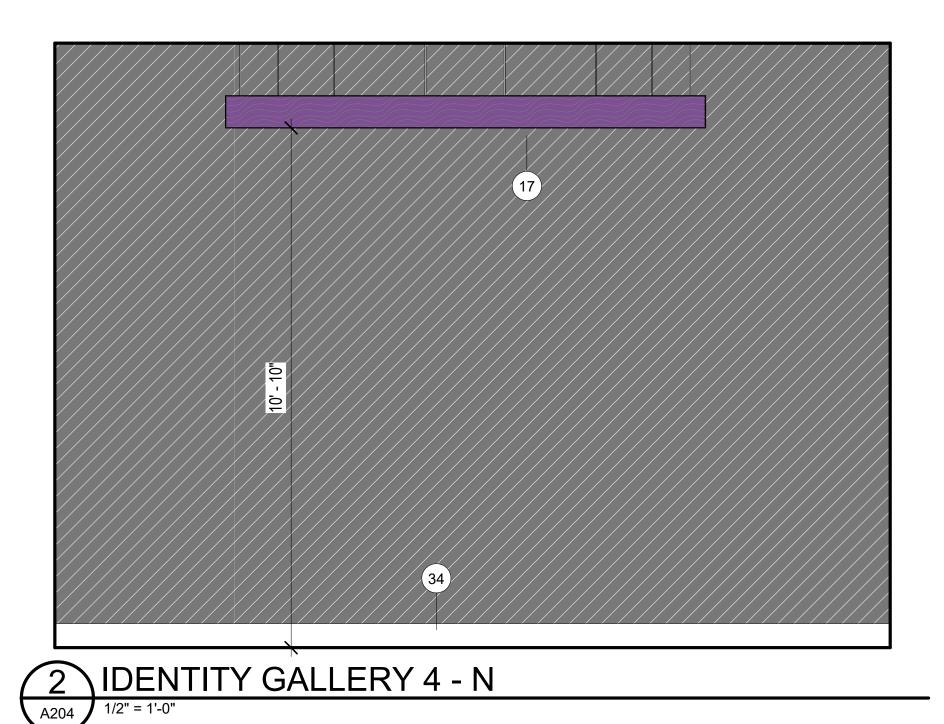




RENDER

F O R: SUBMITTAL PRICING

## ELEVATION LEGEND

1/2" SCALE. REFER TO FINISH LEGEND FOR SPECIFIED FINISH INFORMATION.

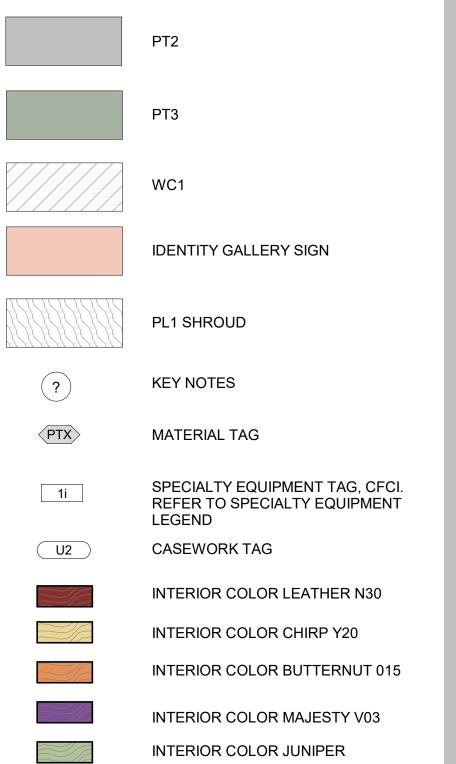

## **KEYNOTES**

- 3 4" H CUT VINYL GRAPHIC QUOTE & 2" H CUT VINYL GRAPHIC TRANSLATION
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- 14 FREESTANDING DISPLAY CASE WITH EXHIBITION DRAWERS. BASIS OF DESIGN: ZONE ZF-101D. SIZE: 6'W X 2'D X 7'H. ANTI-GLARE UV LAMINATE GLASS, LED LIGHT BAR, 3 SHELVES. BLACK POWDER COAT FINISHES.
- 15 WALL MOUNTED DISPLAY CASE. BASIS OF DESIGN ZONE ZW-102. SIZE 2'-6"W X 2'H X 6"D. ANTI-GLARE UV LAMINATED GLASS, OPENING WITH HINGES, HIGH SECURITY CAM LOCK, LED LIGHT BAR AND DESICCANT COMPARTMENT. POWDER COAT BLACK FINISH.
- 17 CENTER LIGHTS IN SPACE
- 34 BASE BOARD HEAT, REFER TO MECHANICAL FOR MORE INFORMATION.



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#### ALASKA NATIVE HERITAGE CENTER REMODEL


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**BID CONSTRUCTION** DOCUMENTS


JOB NO.	2023014
DATE:	10.15.2023
PROJ. MGR.:	MLP
DRAWN BY:	MLP
REVIEWED BY:	JTW
REVISIONS:	

INTERIOR **ELEVATIONS** -IDENTITY GALLERY 4





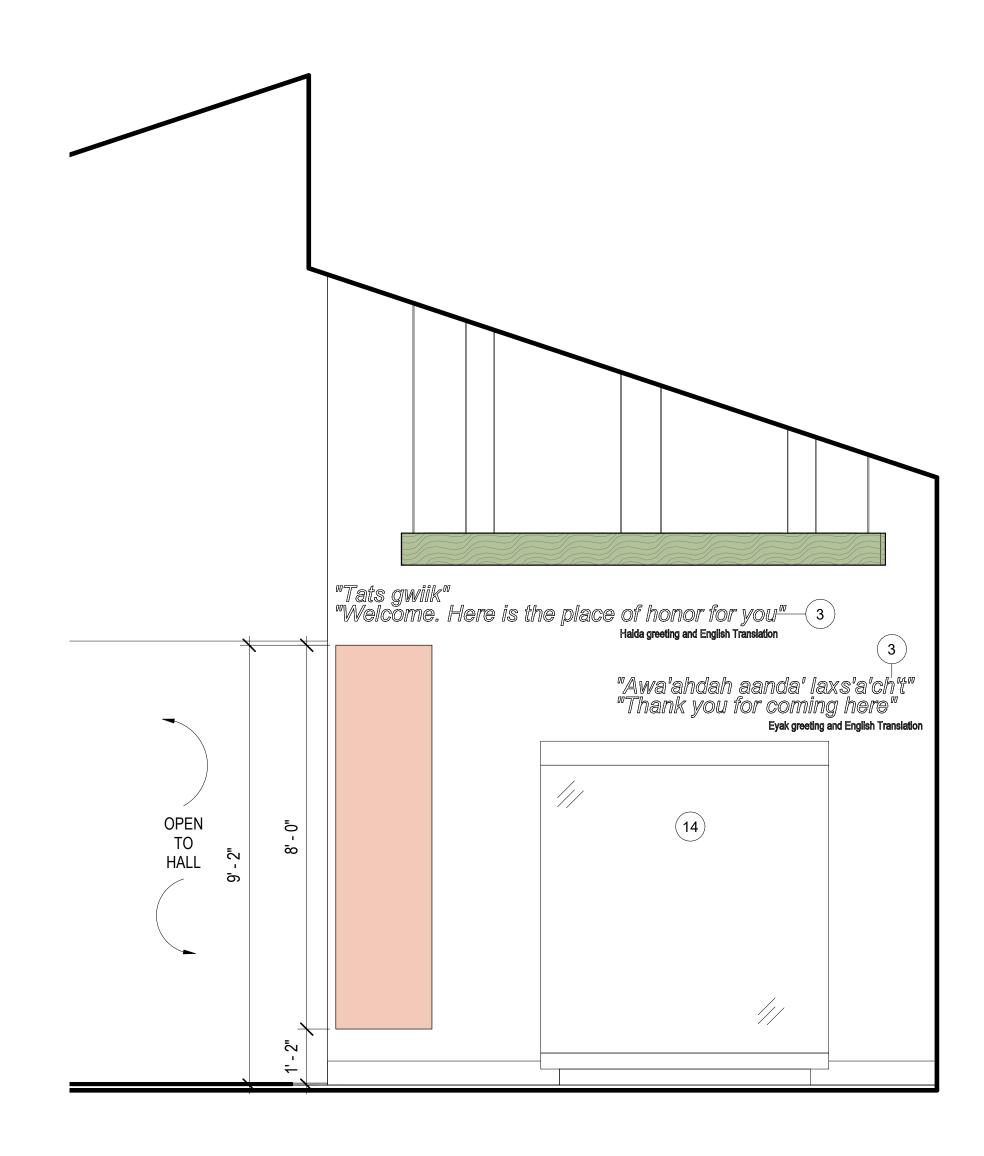

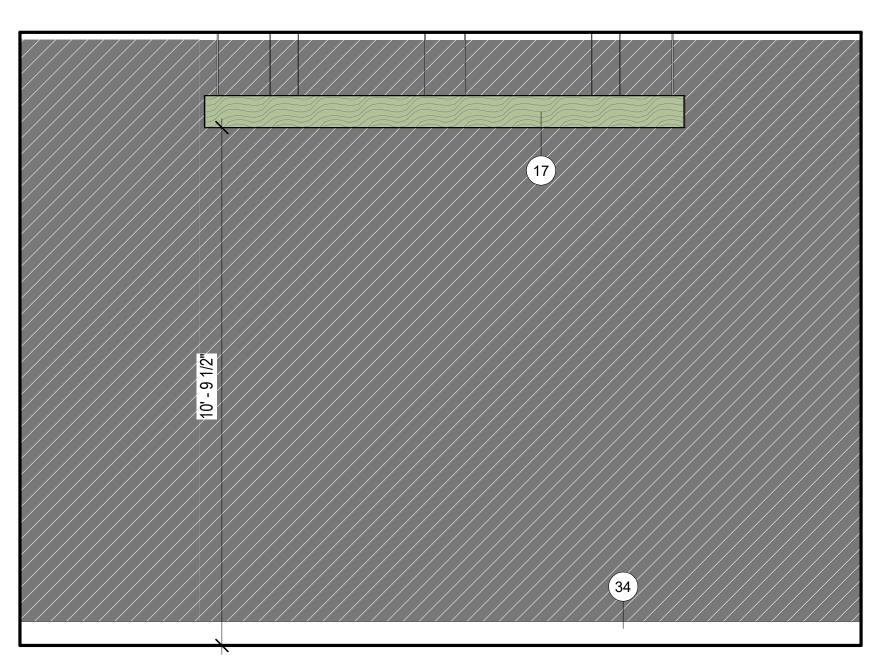






RENDER

A205

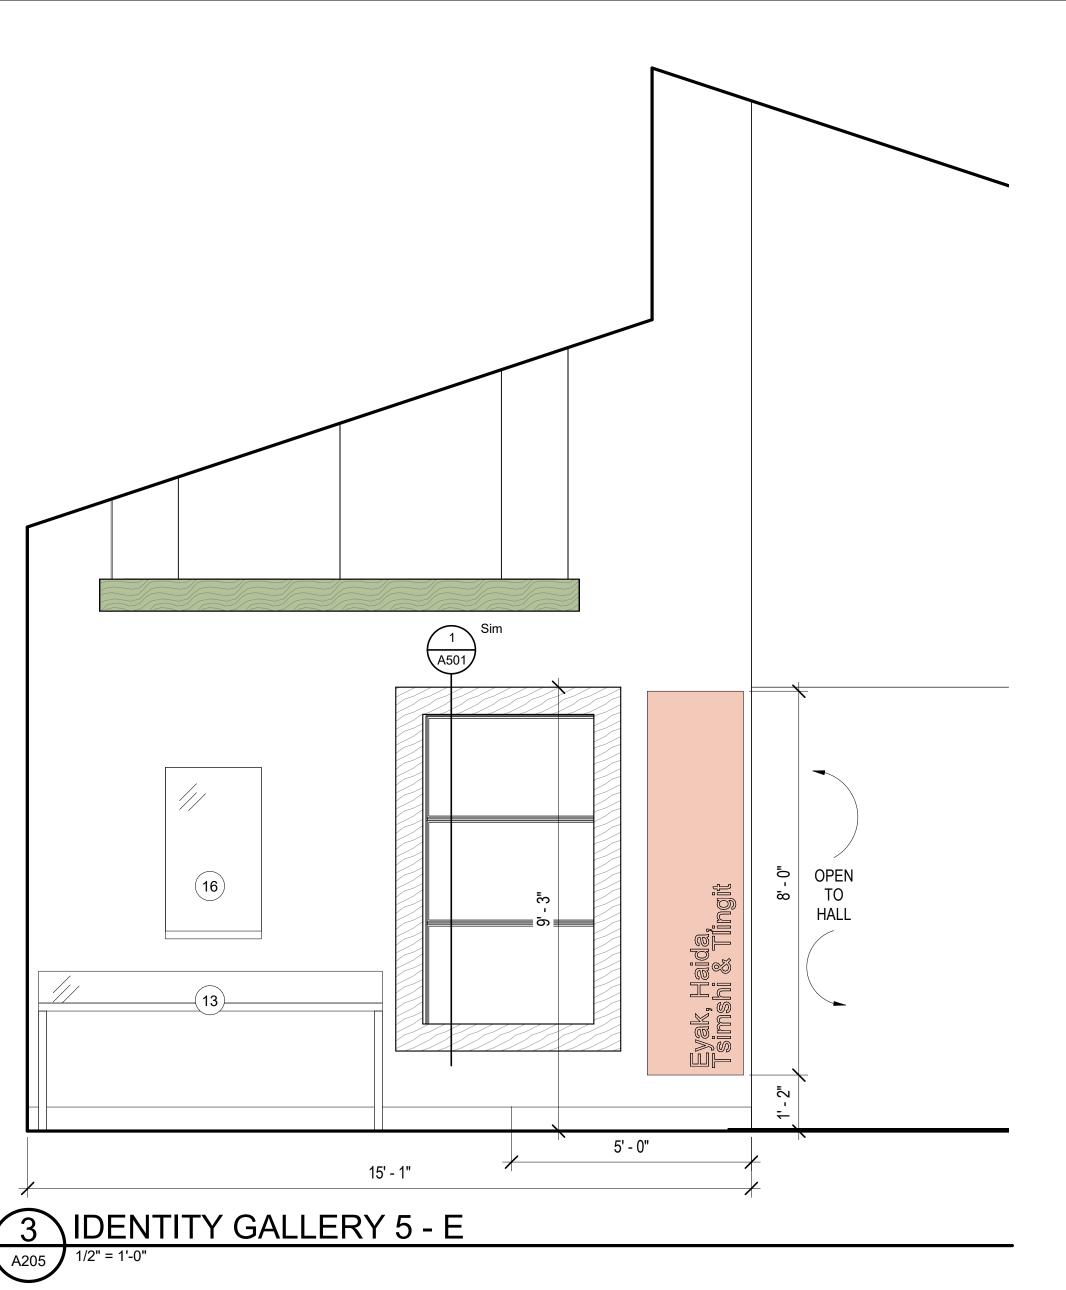

**ELEVATION LEGEND** 

1/2" SCALE. REFER TO FINISH LEGEND FOR SPECIFIED FINISH INFORMATION.

	PT2
	PT3
	WC1
	IDENTITY GALLERY SIGN
	PL1 SHROUD
?	KEY NOTES
PTX	MATERIAL TAG
	SPECIALTY EQUIPMENT TAG, CFCI. REFER TO SPECIALTY EQUIPMENT LEGEND
<u>U2</u>	CASEWORK TAG
	INTERIOR COLOR LEATHER N30
	INTERIOR COLOR CHIRP Y20
	INTERIOR COLOR BUTTERNUT 015
	INTERIOR COLOR MAJESTY V03
	INTERIOR COLOR JUNIPER

## KEYNOTES

- 3 4" H CUT VINYL GRAPHIC QUOTE & 2" H CUT VINYL GRAPHIC TRANSLATION
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- 17 CENTER LIGHTS IN SPACE
- 34 BASE BOARD HEAT, REFER TO MECHANICAL FOR MORE INFORMATION.

F O R: SUBMITTAL PRICING



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REVISIONS:	

#### INTERIOR **ELEVATIONS** -IDENTITY GALLERY 5







VIEW OF LOBBY

1/4" = 1'-0"

A206

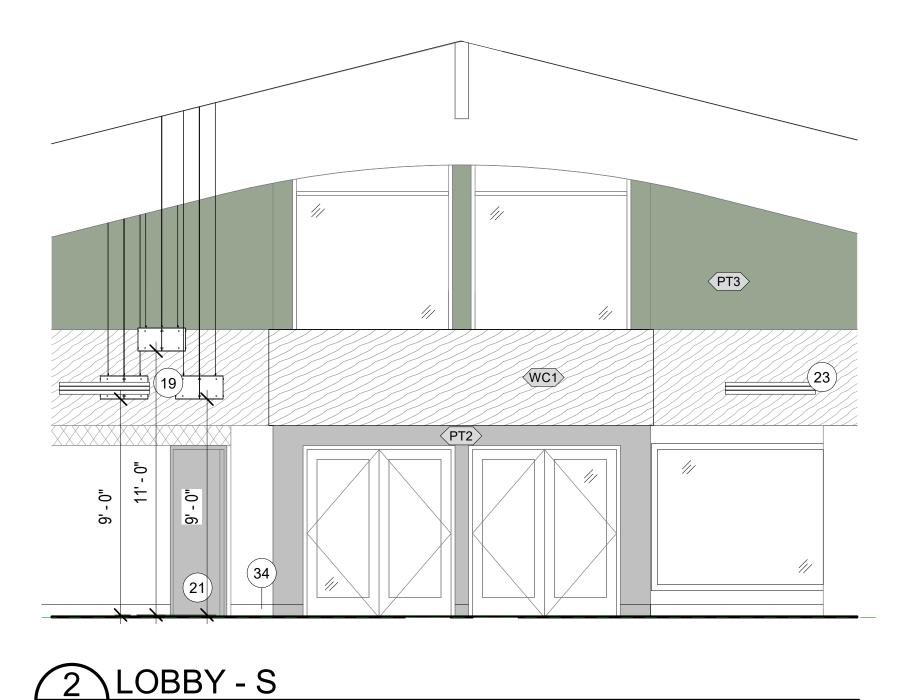


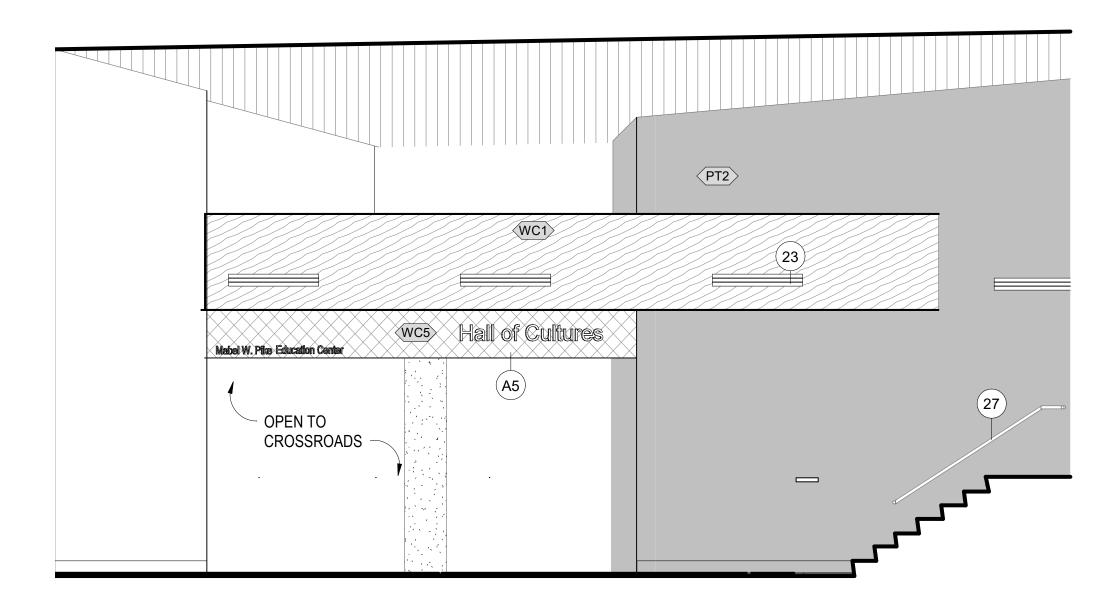


# 4 CROSSROADS ENTRANCE - E





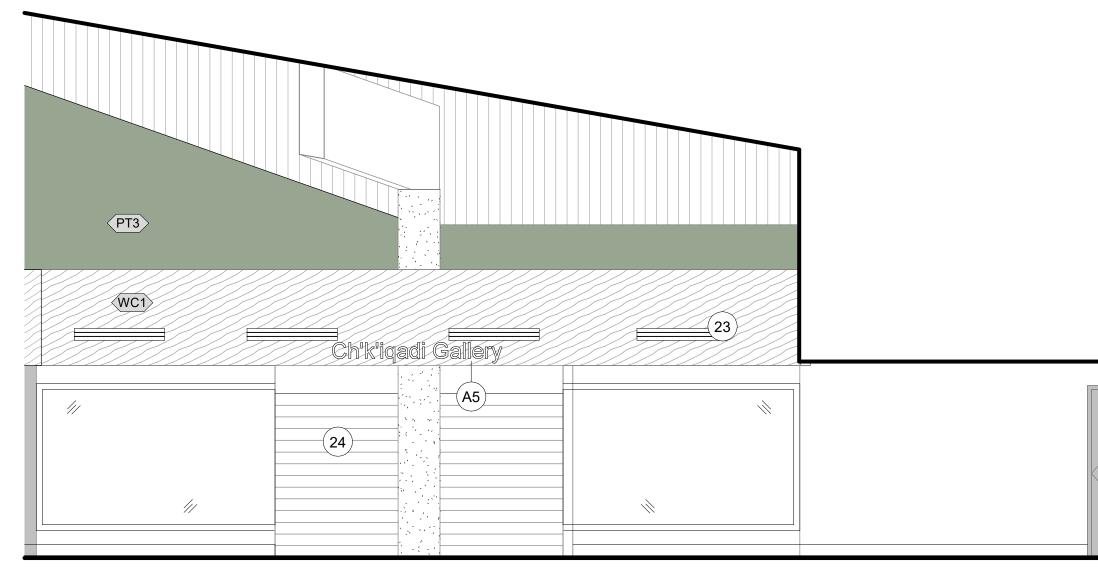


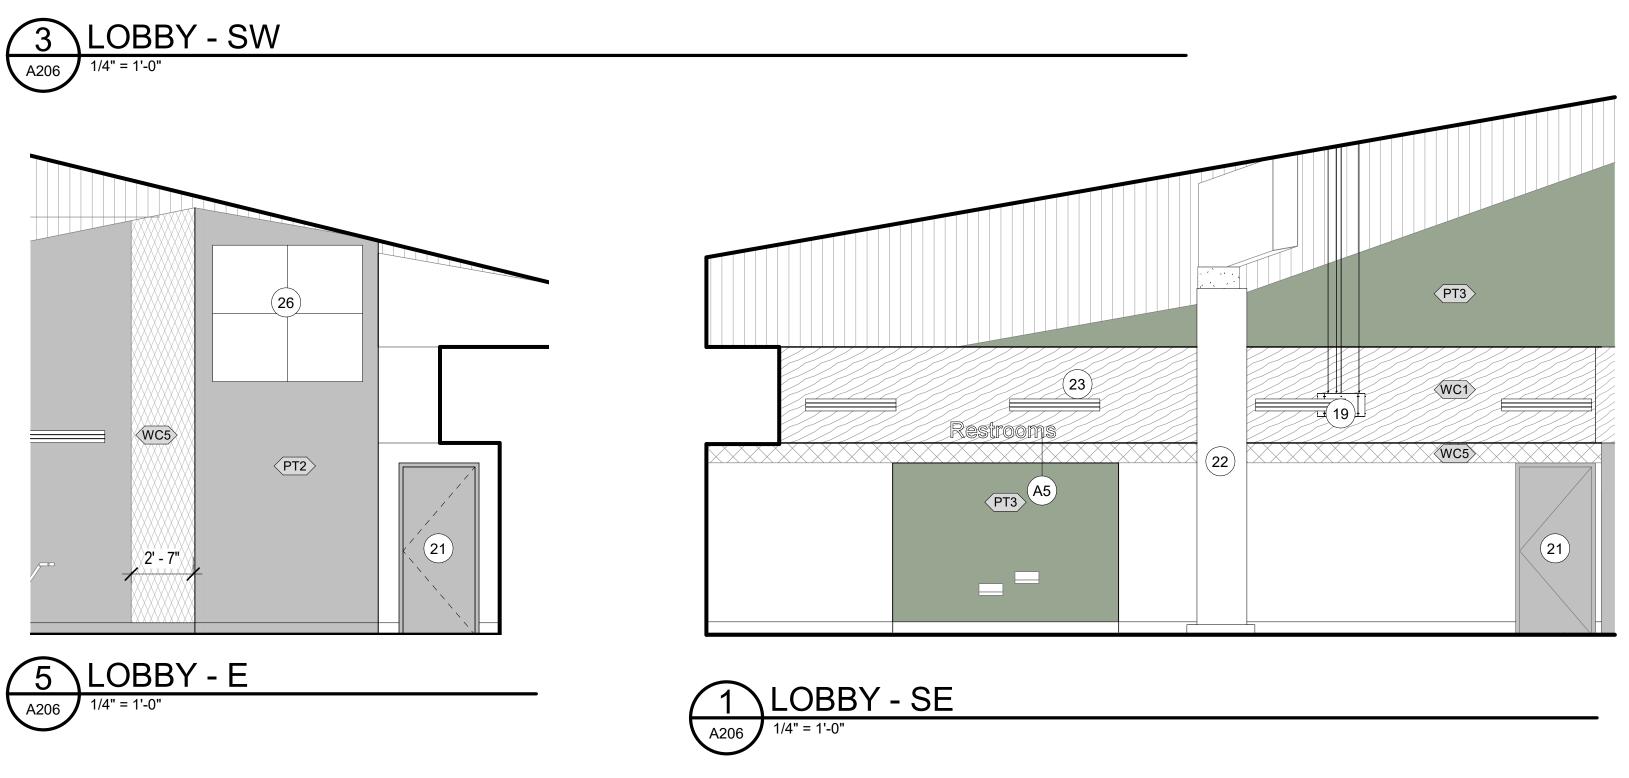


FOR: SUBMITTAL PRICING

## ELEVATION LEGEND

1. REFER TO FINISH LEGEND FOR SPECIFIED FINISH INFORMATION.

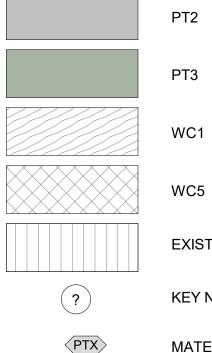

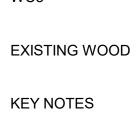

MATERIAL TAG

## KEYNOTES

- 19 24" SEAL SKIN LAMPS. REFER TO ELECTRICAL FOR MORE INFORMATION. MOUNT BOTTOM OF PENDANT AT 9' / 9'-6"
- 20 PAINT EXISTING DOOR AND FRAME PT2
- 21 PAINT EXISTING DOOR FRAME AT THIS LOCATION PT2
- 22 EXISTING TOTEM
- 23 EXISTING DIFFUSERS, CLEAN AND REINSTALL AFTER APPLICATION OF WC1
- 24 EXISTING SECURITY DOOR
- 26 EXISTING MECHANICAL, CLEAN TO BRING TO LIKE NEW CONDITION.
  27 REMOVE AND RE-INSTALL EXISTING HANDRAILS,
- 27 REMOVE AND RE-INSTALL EXISTING HANDRAILS, CLEAN TO BRING TO LIKE NEW CONDITION.
  34 BASE BOARD HEAT, REFER TO MECHANICAL FOR MORE INFORMATION.
- A5 ADD ALTERNATE 5



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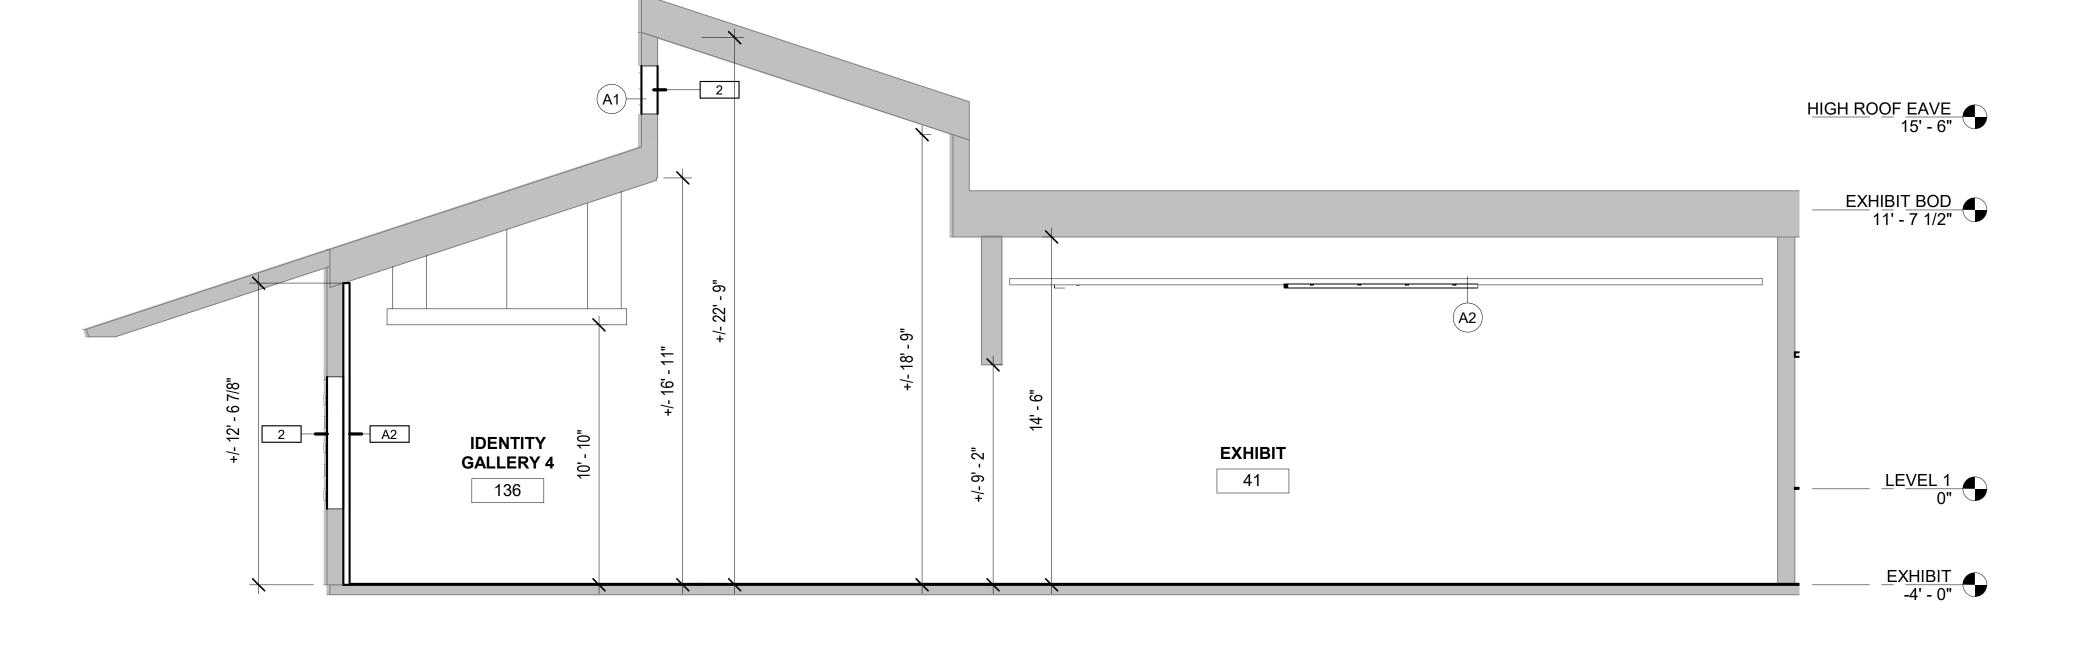
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REVIEWED BY:	JTW
REVISIONS:	

#### INTERIOR ELEVATIONS -LOBBY









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## KEYNOTES

A1 REMOVAL OF HIGH TRANSOM WINDOWS AND INFILL WALL ASSEMBLY TO MATCH EXISTING; ALT #1

A2 ADD ALTERNATE 2: WOOD CEILING ACCENT (ACT2). CONTRACTOR TO COORDINATE WITH NICET DESIGN TO APPROVE ANY MODIFICATIONS TO THE EXISTING SPRINKLER SYSTEM AND ADJUST AS NEEDED TO ACCOMMODATE A SMALLER PERCENTAGE OF OPENNESS. FINAL DESIGN LAYOUT WILL NEED TO BE COORDINATED WITH EXISTING ELECTRICAL AND MECHANICAL ITEMS.



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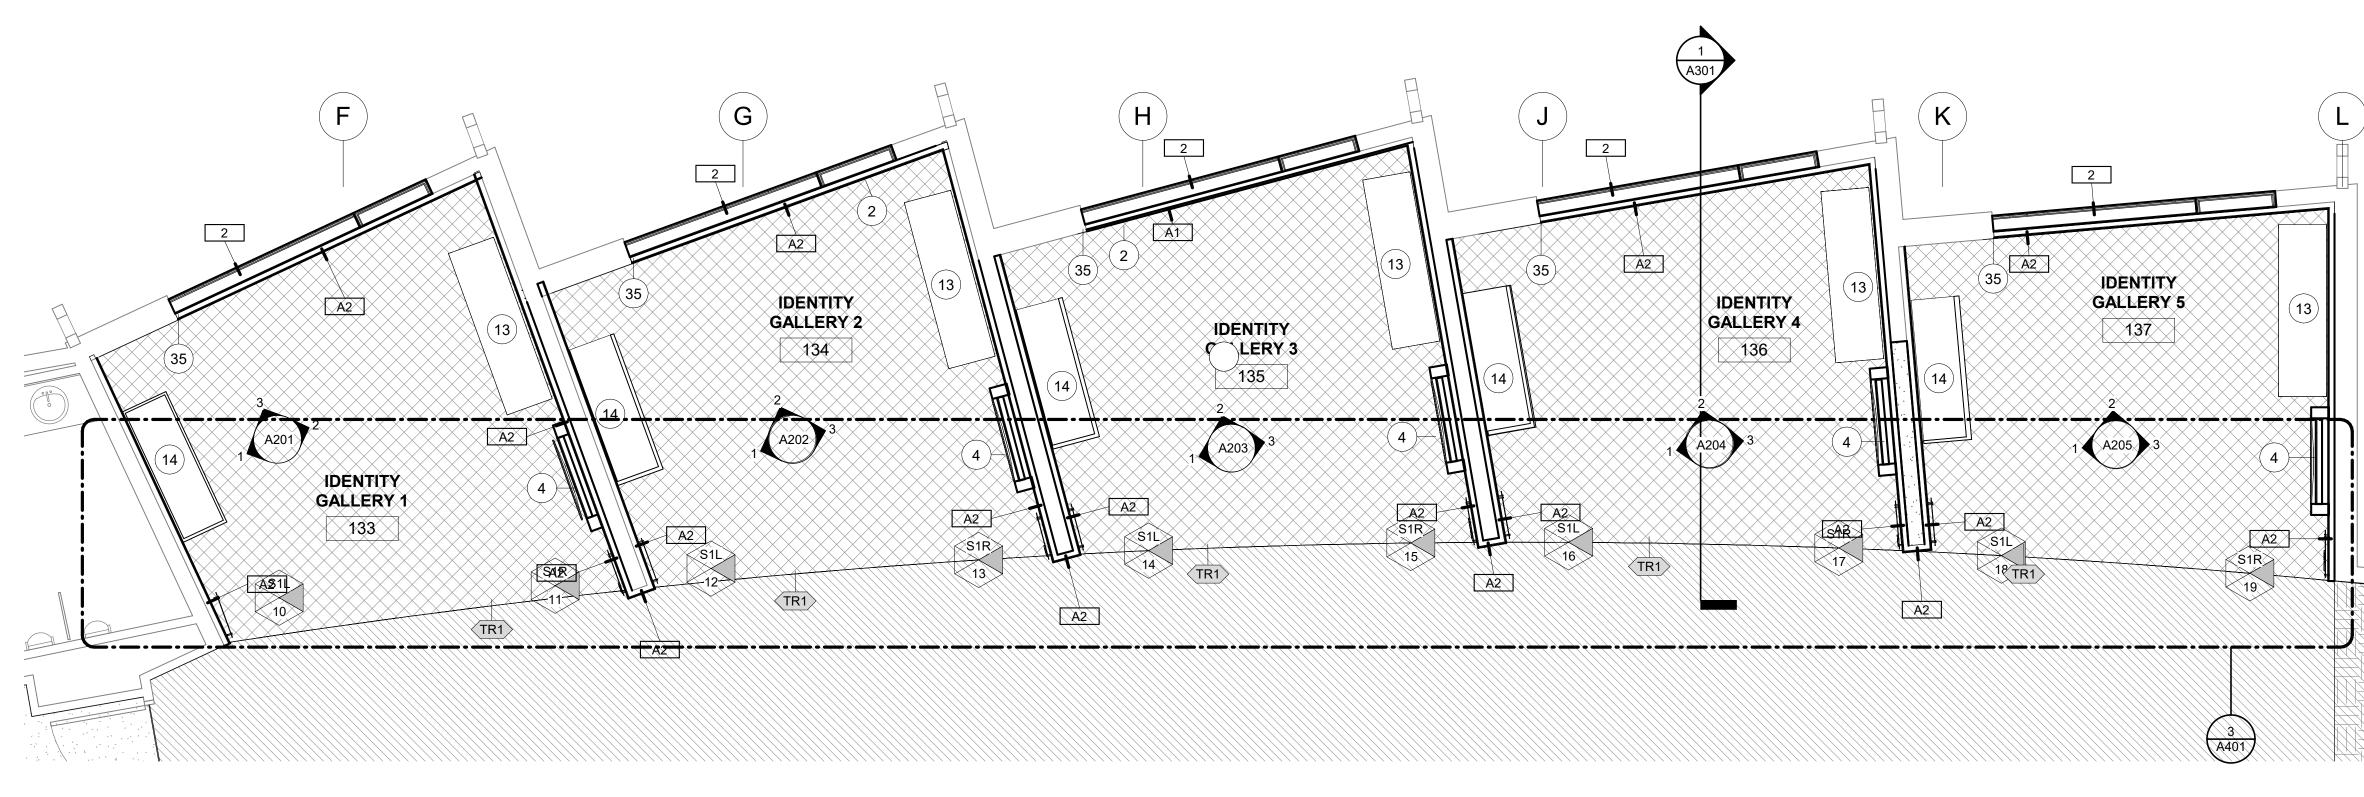
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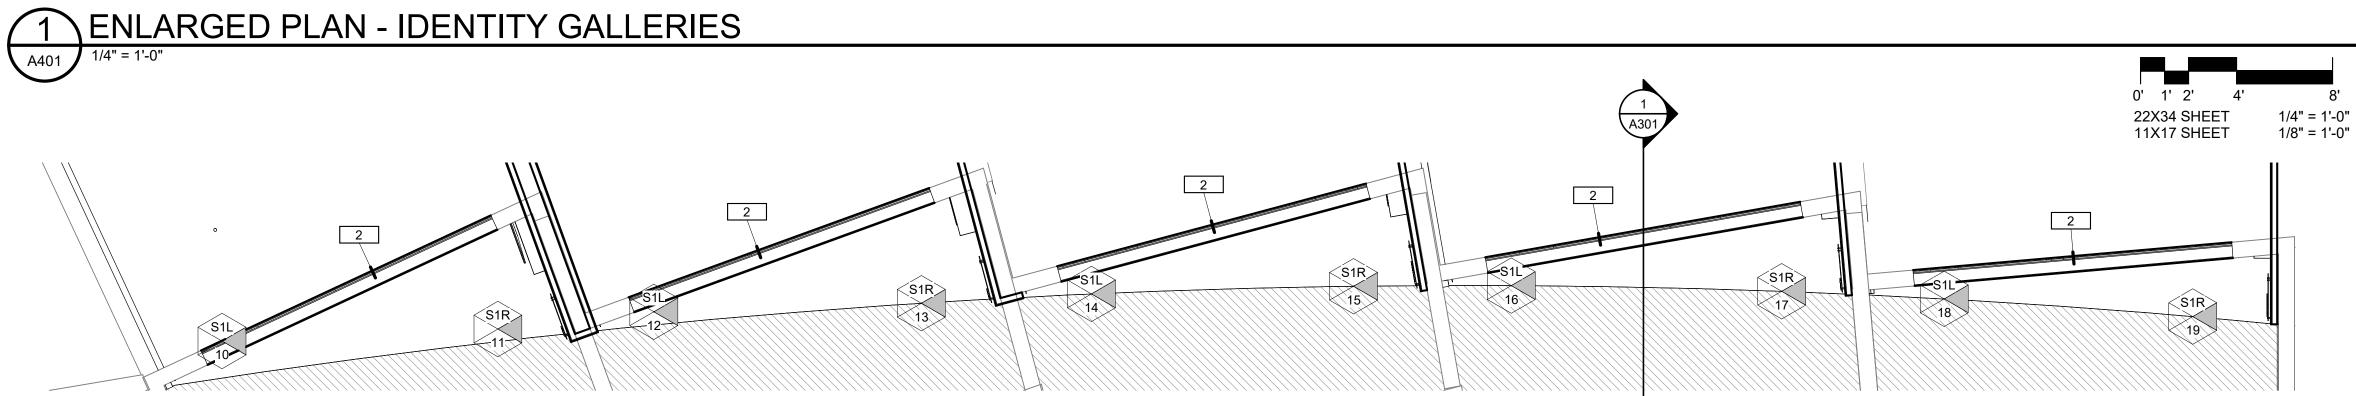
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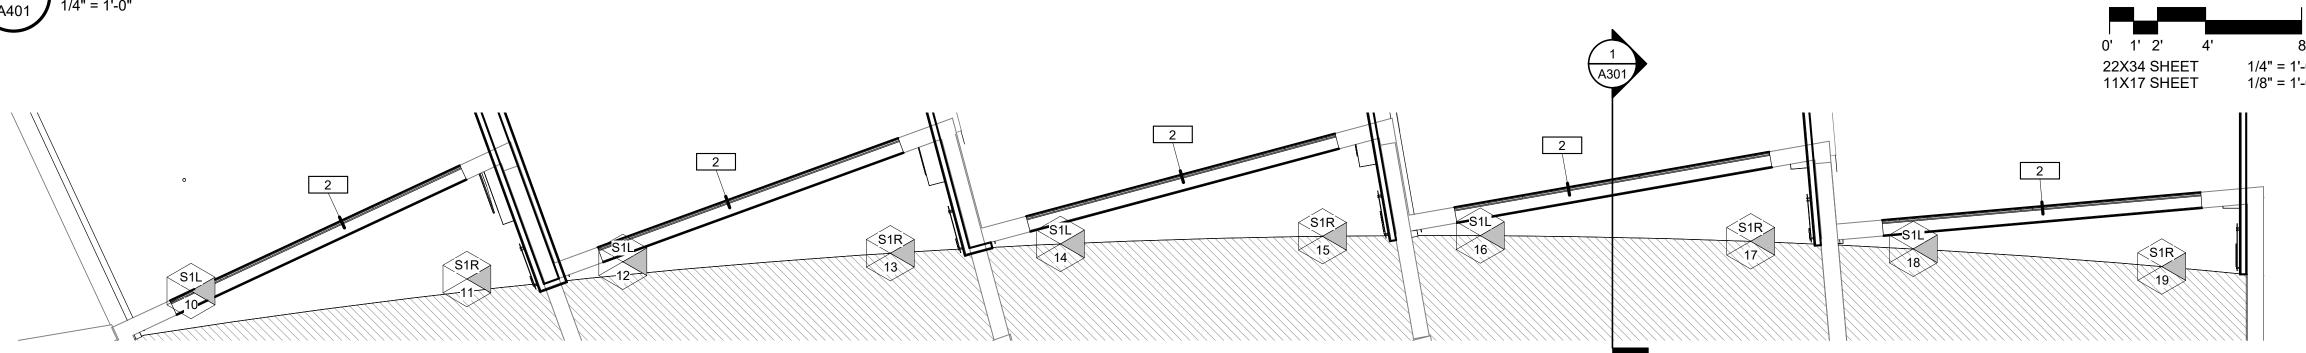
JOB NO.	2023014
DATE:	10.15.2023
PROJ. MGR.:	Designer
DRAWN BY:	Author
REVIEWED BY:	Checker
REVISIONS:	

BUILDING SECTIONS













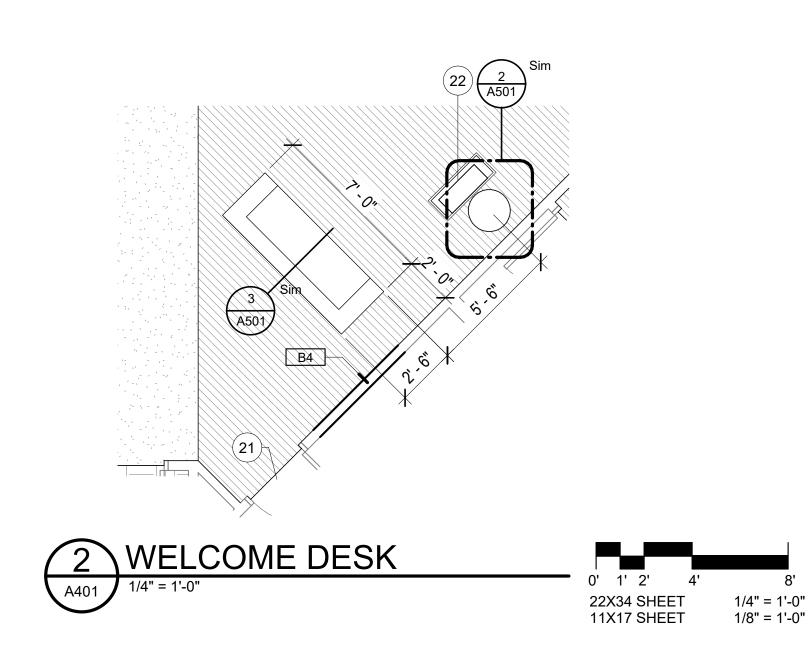

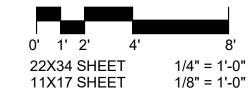



T G002 FOR GENERAL NOTES
NOT IN SCOPE
CPT1
CPT2
CPT3
RT1
RT2
WOM1
EXISTING FLOOR TO REMAIN
ACCENT PAINT LOCATION
WALL COVERING

••••WC1>•••

FINISH LEGEND

**ARTIST GRAPHIC** 

NEW WALL

**KEY NOTES** 


EXISTING WALL

(?)

PTX

MATRIAL TAG; REFER TO MATERIAL LEGEND FOR MORE INFORMATION

#### SIGNAGE TAG

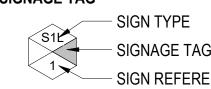

- SIGNAGE TAG - SIGN REFERENCE NUMBER

## **KEYNOTES**

- 2 FULL WALL GRAPHIC PRINTED TO WALL COVERING SUBSTRATE
- 4 WALL MOUNTED DISPLAY CASE. BASIS OF DESIGN ZONE ZW-102. SIZE 2'W X 2'H X 6"D. ANTI-GLARE UV LAMINATED GLASS, OPENING WITH HINGES, HIGH SECURITY CAM LOCK, LED LIGHT BAR AND DESICCANT COMPARTMENT. POWDER COAT BLACK FINISH.
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- 21 PAINT EXISTING DOOR FRAME AT THIS LOCATION PT2
- 22 EXISTING TOTEM
- 35 ALIGN WALL WITH EXISTING FACE. LEVEL 5 FINISH.

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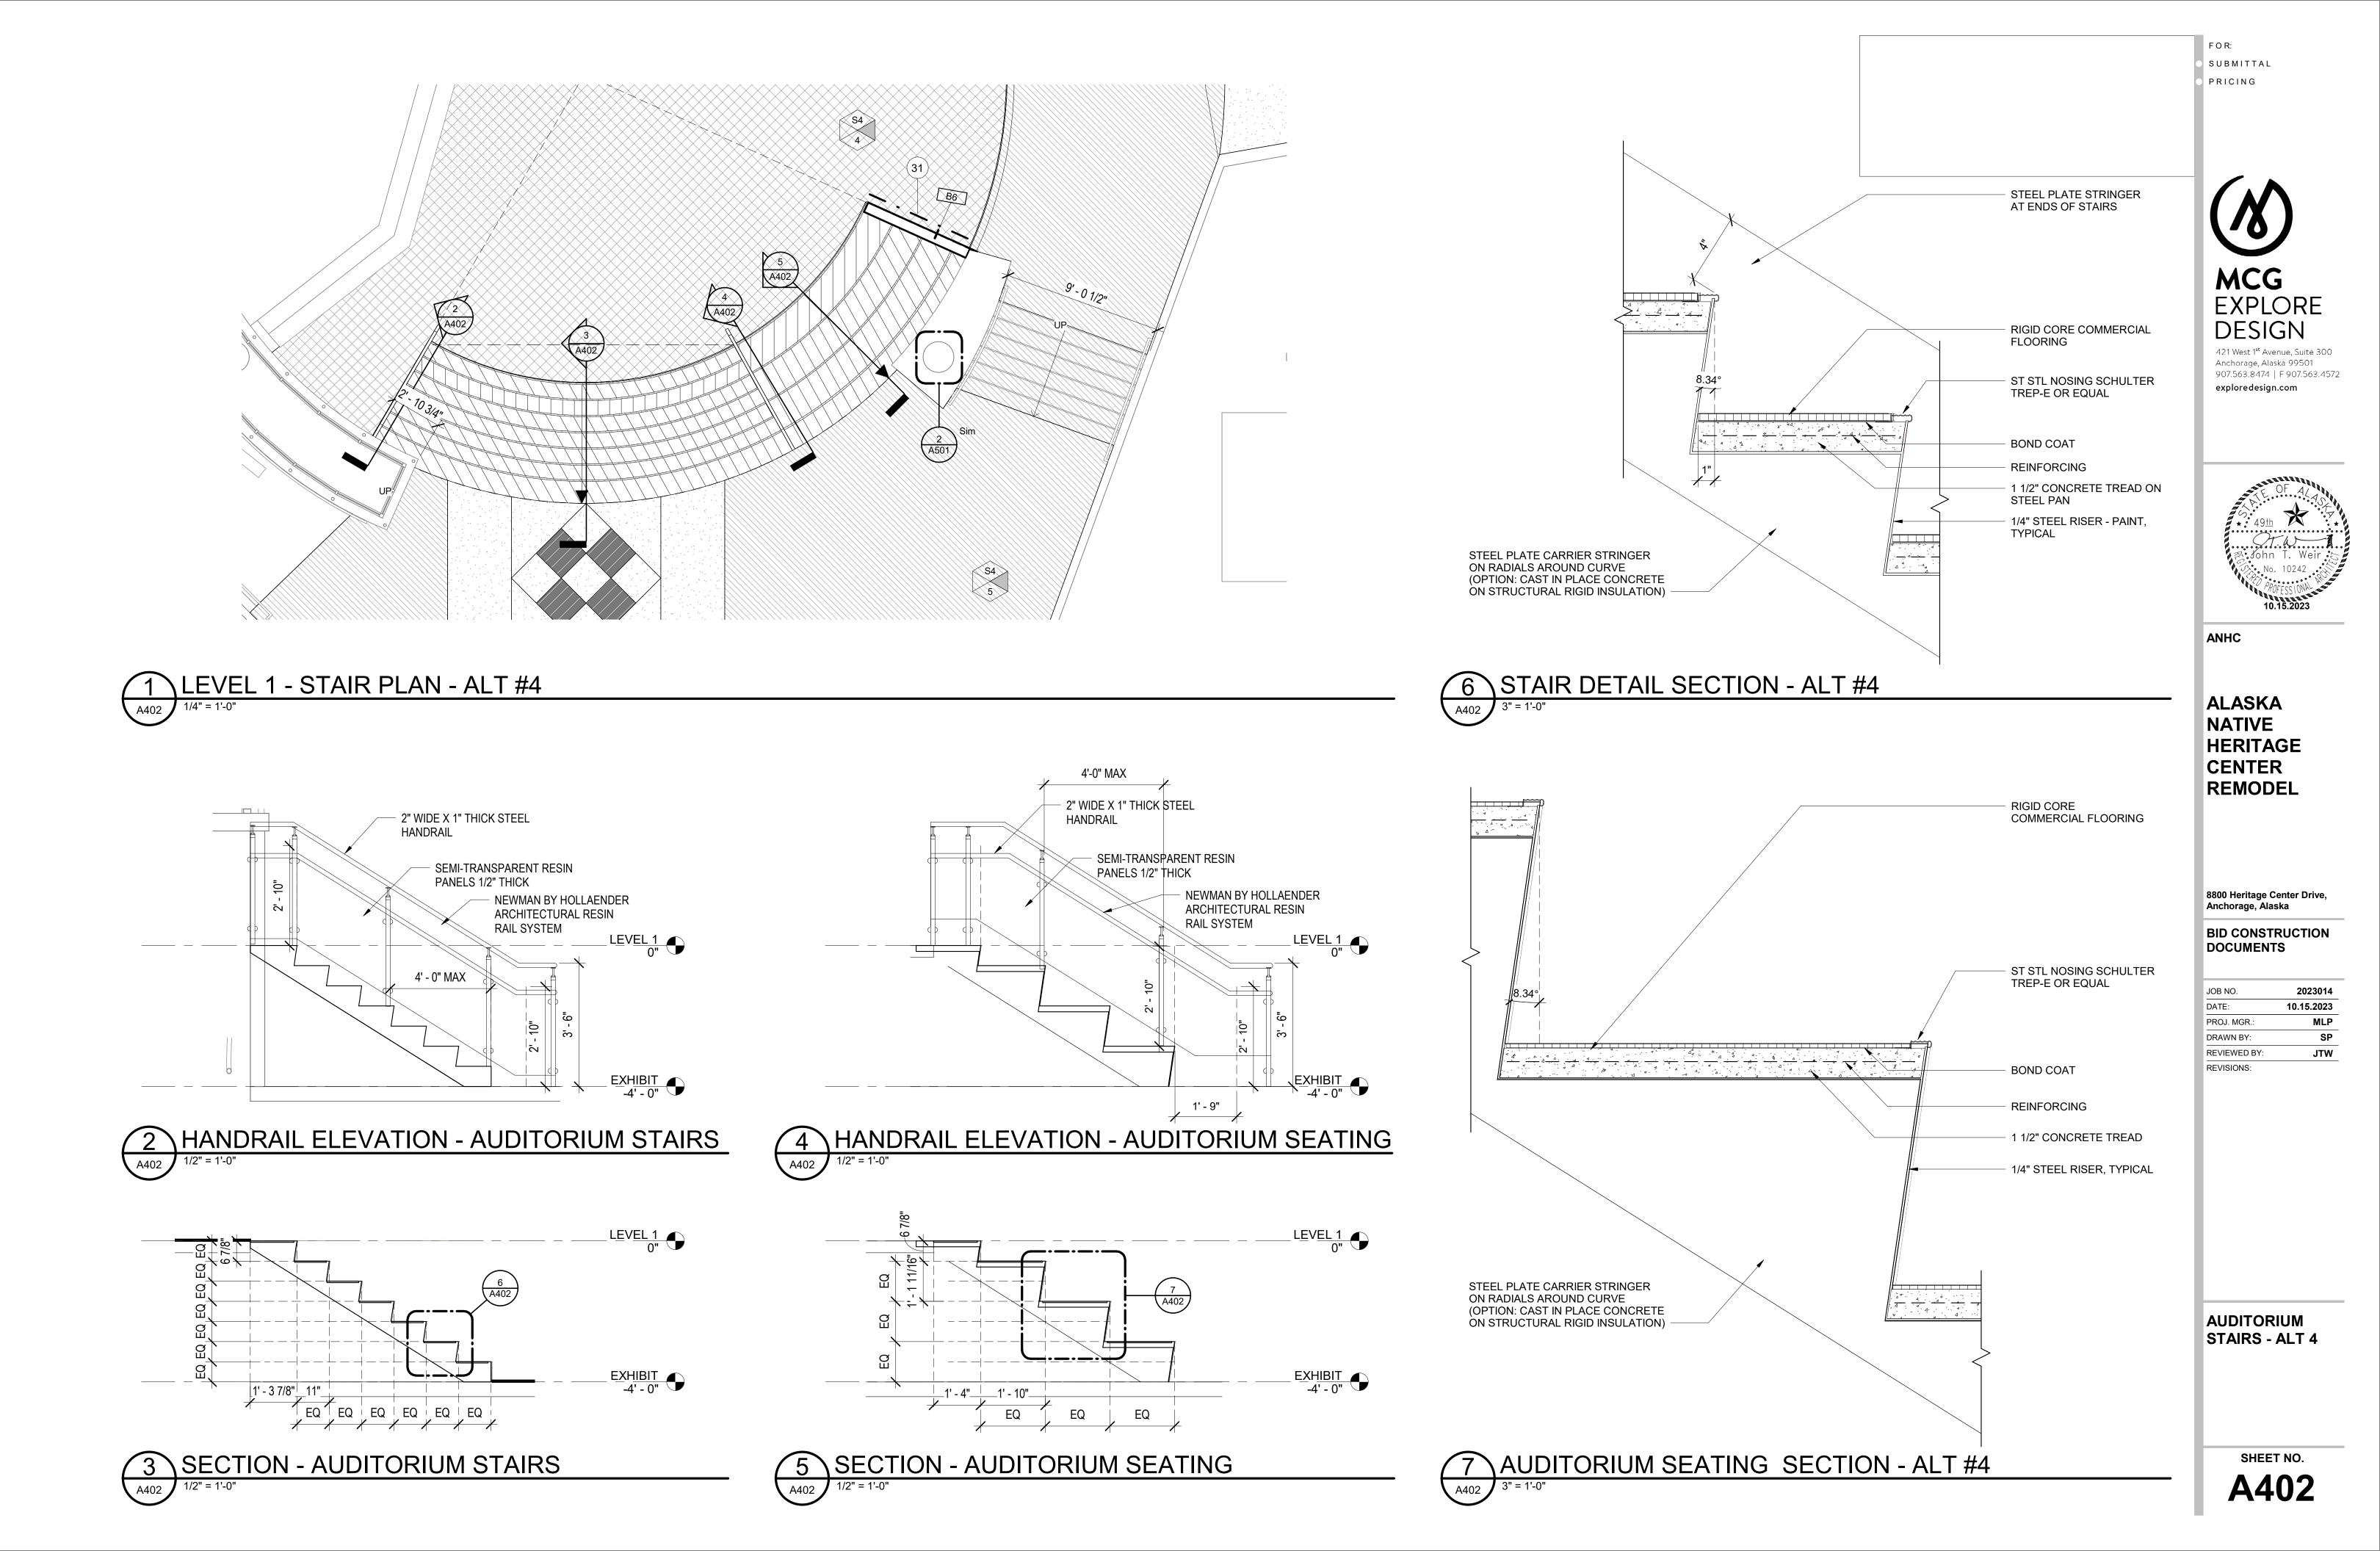
#### **BID CONSTRUCTION** DOCUMENTS


JOB NO.	2023014
DATE:	10.15.2023
PROJ. MGR.:	MLP
DRAWN BY:	MLP
REVIEWED BY:	JTW
REVISIONS:	


#### ENLARGED PLANS


SHEET NO.






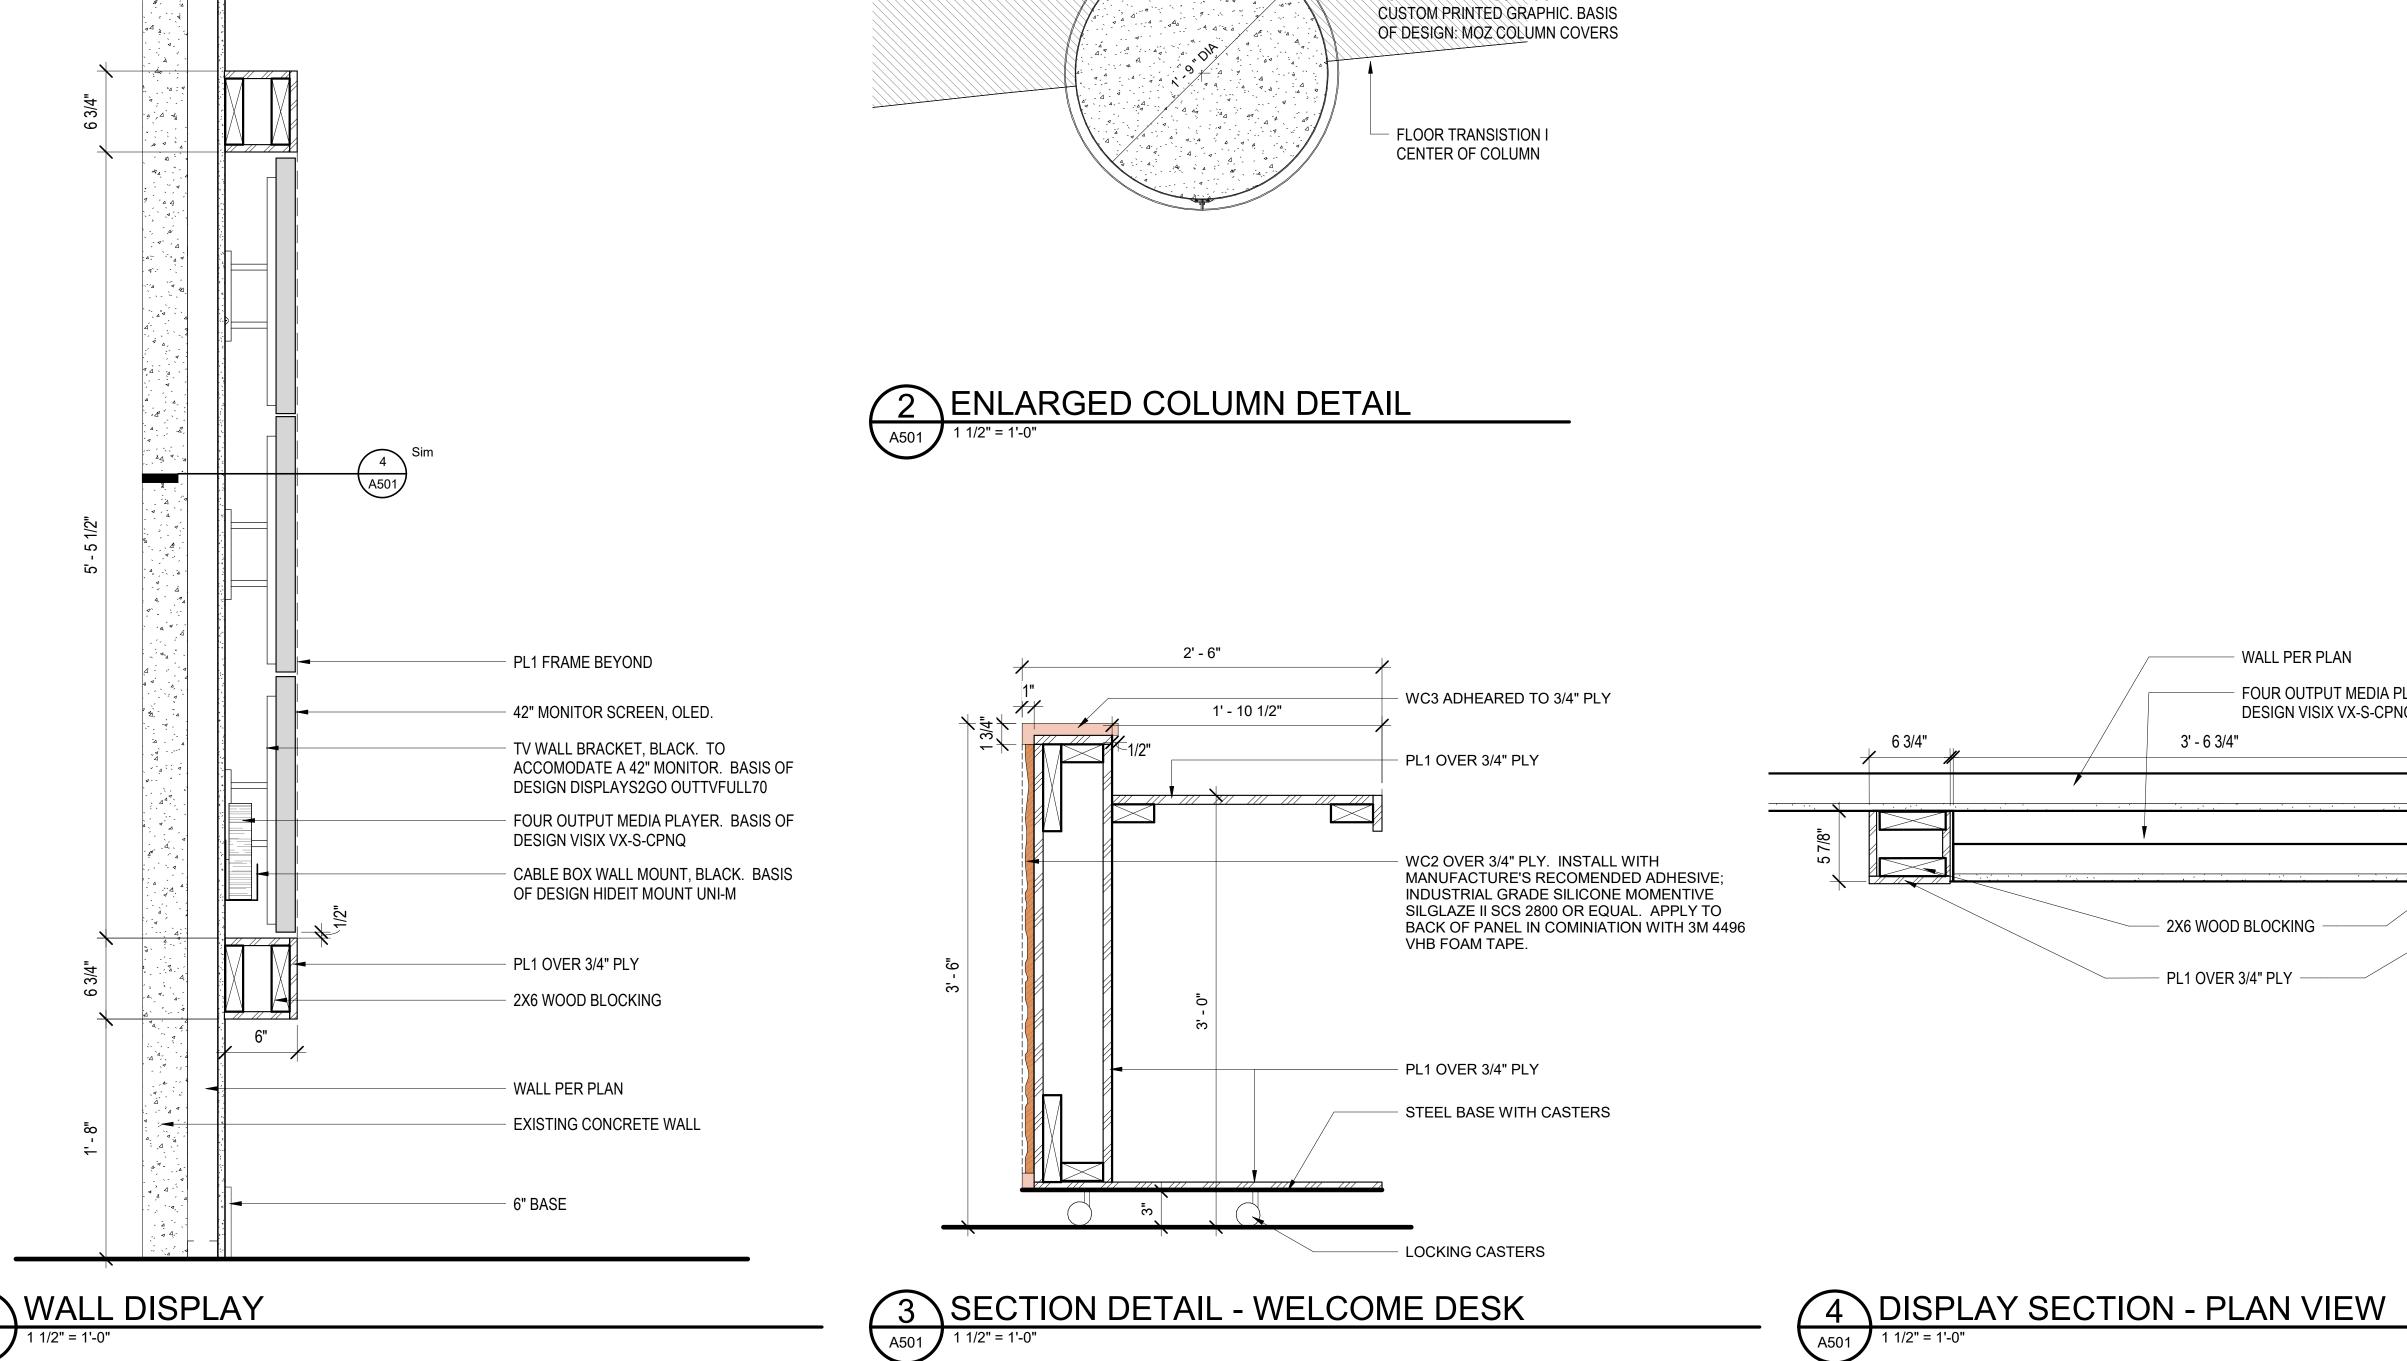

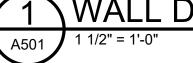

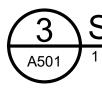

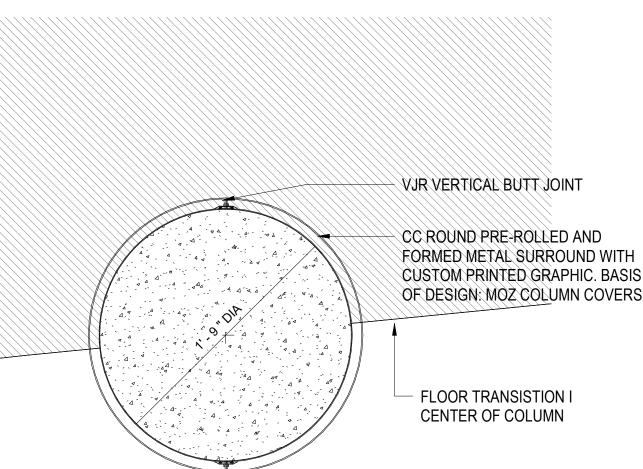

	WALL PER PLAN		
	FOUR OUTPUT MEDIA PLAYER. DESIGN VISIX VX-S-CPNQ	BASIS OF	
3' - 6 3/4'	•	6 3/4"	
			_
· · · · · ·			
2X6 WOOD	BLOCKING		
PL1 OVER	3/4" PLY		

**MCG** EXPLORE DESIGN

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#### ALASKA NATIVE HERITAGE CENTER REMODEL

**BID CONSTRUCTION** DOCUMENTS

2023014

MP

SP

MP

10.15.2023

JOB NO.

PROJ. MGR.:

DRAWN BY:

**REVISIONS:** 

REVIEWED BY:

DATE:

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SHEET NO. A501

INTERIOR DETAILS

	INTERIOR MATERIALS LEGEND							
CODE	DESCRIPTION	MANUFACTURER	STYLE	COLOR	SIZE (INCHES)	REMARKS	INSTALLATION	SUSTAINABILITY
PL1	LAMINATE	FORMICA	PLANED URBAN OAK	-	-	-	-	LEED
TR1	TRANSITION STRIP (RT TO RT)	JOHNSONITE	CD-XX-C	BEIGE 49	0.75		PER MANUFACTURER RECOMENDATIONS	LEED
TR2	TRANSITION STRIP (CPT TO RT)	JOHNSONITE	SLTC-XX-F	STEEL 179	0.25		PER MANUFACTURER RECOMENDATIONS	-
CEILING				-				
ACT1	ACOUSTIC CEILING TILE	ARMSTRONG	ANHS STANDARD	WHITE	24X48	-	PER MANUFACTURER RECOMENDATIONS	LEED, DELCARE
ACT2	ACOUSTIC WOOD CEILING	TURF	ARBOR	TBD	-	-	ATTACHED TO EXISTING UNISTRUT	LEED, DELCARE
FLOOR		1			I			
CPT1	CARPET TILE	MILLIKEN	CUSTOM GRAPHIC	TBD	TBD	FILE TO BE PROVIDED BY OWNER	TBD	LEED
CPT2	CARPET TILE	SHAW CONTRACT	DYELAB	CORNFLOWER	24X24	-	ASHLAR INSTALLATION	LEED, DELCARE
CPT3	FLOCKED FLOORING	FORBO	SEAGRASS	WALNUT	9X39X0.2	-	BRICK INSTALLATION METHOD: DIRECT GLUE	BREEAM / OEKO-TE
RT1	RESILIENT PLANK	SHAW CONTRACT	REGID CORE; ORIGIN	PRELUDE 38710	6X48X0.236	-	BRICK INSTALLATION METHOD: DIRECT GLUE	FLOORSCORE CERTIFIED; PVC FREE
RT2	RESILIENT PLANK	SHAW CONTRACT	REGID CORE; ORIGIN	THEORY 38140	6X48X0.236	-	BRICK INSTALLATION METHOD; DIRECT GLUE	FLOORSCORE CERTIFIED; PVC FREE
WALL								
PT1	PAINT - GENERAL (WHITE)	PPG	EGGSHELL	TOASTED ALMOND 15-26	-	-	-	LEED
PT2	PAINT - ACCENT (BEIGE)	PPG	EGGSHELL	EL CAPITAN 1020-4	-	USE EPOXY PAINT ON DOOR AND DOOR FRAMES WHERE NOTED.	-	LEED
PT3	PAINT - ACCENT (GREEN)	PPG	EGGSHELL	LIVELY IVY 11-30	-	-	-	LEED
RB1	RUBBER WALL BASE	JOHNSONITE	REVEAL MW-XX-F6	CLAY WB 09	6X0.25	-	See Tarkett Millwork Wall Finishing Systems or Chair Rail installation instructions for complete details	FLOORSCORE
WC1	WALL COVERING	MOMENTUM	WALLCOVERING WOODS	BROWN BIRCH		-	PER MANUFACTURER RECOMENDATIONS	LEED
WC2	CHROMA	3FORM	VELLUM	MARIENER B33	1"	-	-	LEED, DELCARE
WC3	MOLDED MDF	3FORM	PROFILE CREST	BALTIC BIRCH	-	-	-	LEED
WC4	WALL GRAPHIC	MOMENTUM	CUSTOM PHOTO	TBD		FILES TO BE SUPPLIED BY OWNER	PER MANUFACTURER RECOMENDATIONS	LEED
WC5	WALL GRAPHIC	TBD	VINYL GRAHPICS	TBD		FILES TO BE SUPPLIED BY OWNER	-	-

		<b>INTERIOR - SIGNAG</b>	
SIGN	SIGN ID		
TYPE	NUMBER	LOCATION - DOOR (or room ) NUMBER	TEXT
S1L			
S1L	10	IDENTITY GALLERY 1	-
S1L	12	IDENTITY GALLERY 2	-
S1L	14	IDENTITY GALLERY 3	-
S1L	16	IDENTITY GALLERY 4	-
S1L	18	IDENTITY GALLERY 5	-
S1R		1	1
S1R	11	IDENTITY GALLERY 1	Athabascan
S1R	13	IDENTITY GALLERY 2	Yup'ik, and Cup'ik.
S1R	15	IDENTITY GALLERY 3	Iñupiaq St. Lawrence Island Yup'ik
S1R	17	IDENTITY GALLERY 4	Unangax & Alutiiq / Sugpiaq
S1R	19	IDENTITY GALLERY 5	Eyak, Haida, Tsimshian, Tlingit,
S2			
S2	20	EXHIBIT	Mabel W. Pike Education Center
S2	2	GATHERING/CROSSROADS ENTRANCE	Hall of Cultures
S2	8	LOBBY/GIFT SHOP ENTRANCE	Ch'k'iqadi Gallery
S2	6	RESTROOM ENTRANCE	Restrooms
S3			
S3	1	GATHERING/CROSSROADS ENTRANCE	Mabel W. Pike Education Center
S4			
S4	4	GATHERING	-
S4	3	GATHERING/CROSSROADS ENTRANCE	-
S4	9	HALL 125 ENTRANCE	-
S4	5	LOBBY	-
S4	7	RESTROOM ENTRANCE	-
Grand	total: 20	·	·

SUSTAINABILITY LEGEND			
ABV	DESCRIPTION	ADDITIONAL INFO	
GG	GREEN GUARD	WWW.GREENGUARD.ORG	
GG-G	GREEN GUARD GOLD	WWW.GREENGUARD.ORG	
GG-S	GREEN GUARD SILVER	WWW.GREENGUARD.ORG	
DECLARED	LIVING BUILDING CHALLENGE DECLARED	WWW.LIVING-FUTURE.ORG	
LBC RLF	LIVING BUILDING CHALLENGE RED LIST FREE	WWW.LIVING-FUTURE.ORG	
LBC RLA	LIVING BUILDING CHALLENGE RED LIST APPROVED	WWW.LIVING-FUTURE.ORG	
CTC	CRADLE TO CRADLE	WWW.C2CCERTIFIED.ORG	
CTC-S	CRADLE TO CRADLE SILVER	WWW.C2CCERTIFIED.ORG	
CTC-G	CRADLE TO CRADLE GOLD	WWW.C2CCERTIFIED.ORG	
FSC	FOREST STEARDSHIP COUNCIL	WWW.US.FSC.ORG	
LEED	LEADERSHIP IN ENERGY AND ENVIORNMENTAL DESIGN - CREDIT	WWW.USGBC.ORG	
MM	MINDFUL MATERIALS	WWW.MINDFULMATERIALS.COM	
BB	USDA BIO BASED	WWW.BIOPREFERED.GOV	

## FINISH GENERAL NOTES

#### GENERAL WALL FINISHES:

1. ALL GWB WALL FINISH SHALL BE PT1, UNLESS NOTED OTHERWISE.

#### FLOORING:

1. FLOORING TRANSITIONS AT DOORS SHALL OCCUR CENTERED WITH DOOR WHEN CLOSED, TYPICAL.

#### EXPOSED STRUCTURE:

1. ALL EXPOSED STRUCTURE IS TO BE PAINTED PER REFLECTED CEILING PLAN.

#### DOOR:

- NON EXISTING WOOD DOORS AND 1.
- FRAMES TO BE PAINTED PT2 2. ALL EXISTING FRAMES TO BE PAINTED PT2, UNO

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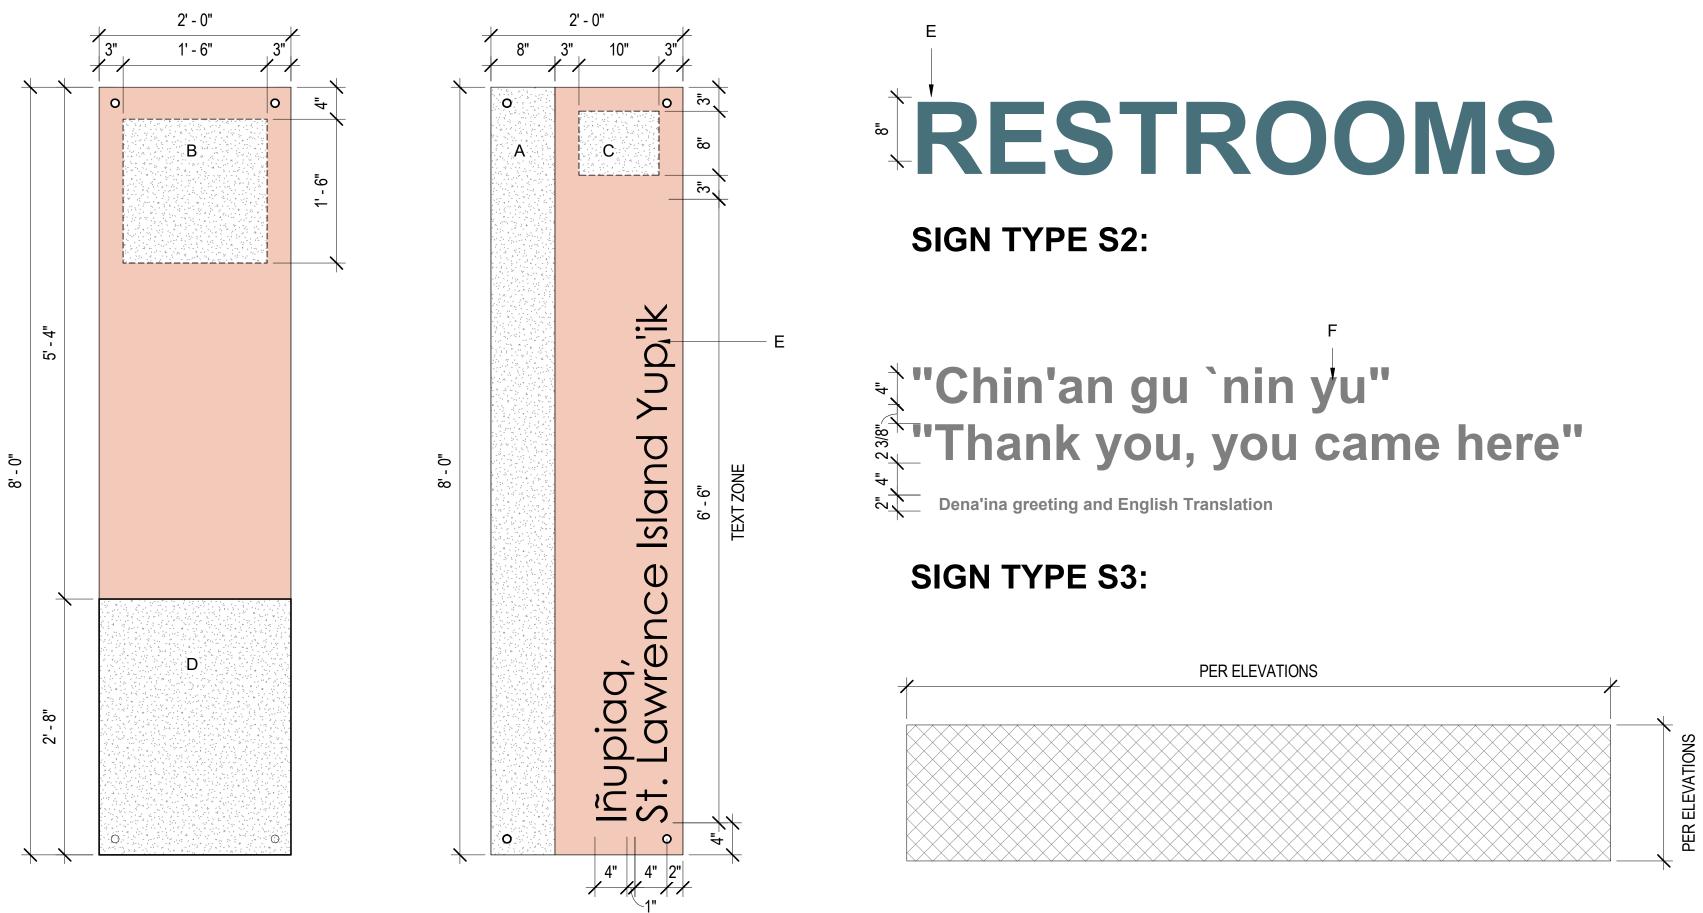
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DRAWN BY:	MLP
REVIEWED BY:	JTW
REVISIONS:	

#### SCHEDULES

SHEET NO.



**SIGN TYPE S1L:** LEFT PANEL


**SIGN TYPE S1R: RIGHT PANEL** 

SIGN TYPE S1L & S1R: DESIGN CONCEPTS




## **SIGN TYPE S4:** ARTIST GRAPHIC TBD

## LEGEND

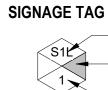

SIGN TYPE - SIGNAGE TAG

SIGN REFERENCE NUMBER

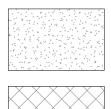

CUSTOM PRINTED GRAPHIC ONTO CHROMA; GRAPHICS TO BE COORDINATED WITH OWNER'S ARTISTS.

CUSTOM PRINTED GRAPHIC ONTO WC5; GRAPHICS TO BE COORDINATED WITH OWNER'S ARTISTS.

3FORM CHROMA, COLOR PINK CHAMPAGNE, 1/2" THICK OUNTED WITH STAINLESS STEEL STANDOFFS.




3FORM DIMENSIONAL LETTERS, WALNUT 4" COPY, FONT: MYRIAD PRO SEMIBOLD

## **IMAGE KEY**

- TRIBAL PATTERN
- LOCATION MAP SYMBOL С
- FINE LINE ILLUSTRATION D
- **3FORM DIMENSIONAL LETTERS, WALNUT** Ε. 4" COPY, FONT: MYRIAD PRO SEMIBOLD
- CUT VINYL LETTERS CUSTOM COLOR TBD **3FORM DIMENSIONAL LETTERS, MARINER** G. FONT: MYRIAD PRO SEMIBOLD

## SIGN TYPE SUMMARY

- S1: IDENTITY GALLERY
- S2: DIMENSIONAL LETTERS ALT #5
- S3: CUT VINYL LETTERS
- S4: WALL GRAPHIC PRINTED TO WC5

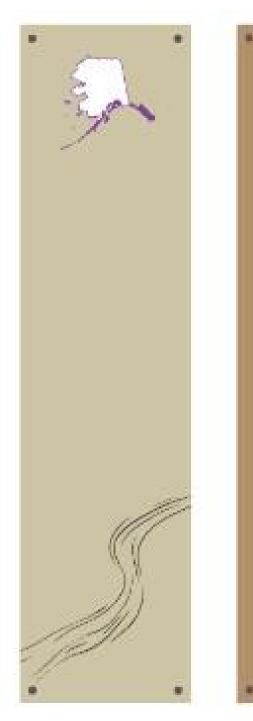

F O R: SUBMITTAL PRICING



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**BID CONSTRUCTION** DOCUMENTS


JOB NO.	2023014
DATE:	10.15.2023
PROJ. MGR.:	MLP
DRAWN BY:	MLP
REVIEWED BY:	JTW
REVISIONS:	

SIGNAGE



Sugpiaq Alutiiq 00 Unangaŝ

H

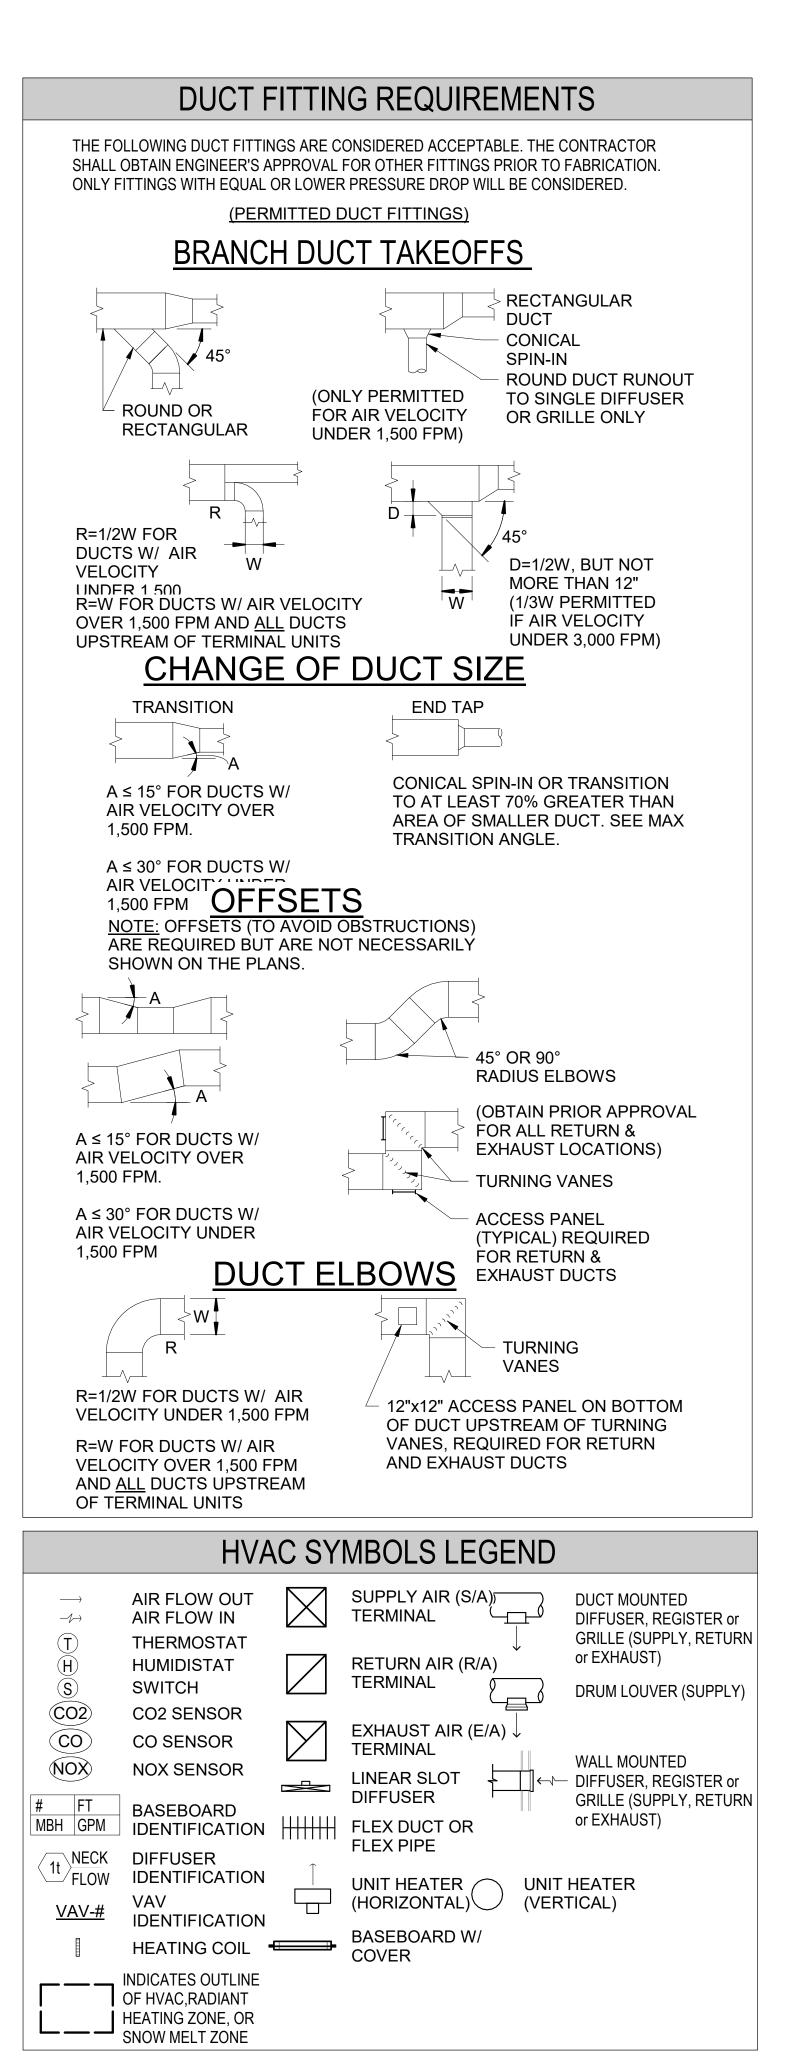

## **DUCTWORK LEGEND**

#### DUCTWORK

DUCT SIZES SHOWN ON DRAWINGS ARE CLEAR INS SHOWN DOES NOT INCLUDE INSULATION OR LINING BEL

BELOW FOR DU	JCT SIZE TAG LEGEND.	
DUC 24x12 S/A DUC	T SIZE RECTANGULAR DUCT SIZE (INCHES) FIRST DIMENSION IS SIDE OF DUCT SHOWN T SYSTEM ABBREVIATION ALWAYS BE SHOWN) FLAT OVAL DUCT SIZE (INCHES) FIRST DIMENSION IS SIDE OF DUCT SHOWN ROUND DUCT CHANGE IN DUCT SIZE AND/OR SHAPE	
<u> </u> ] 	SOUND LINED DUCT	
	INSULATED DUCT	<u> </u>
$\sim$	FLEXIBLE DUCT	
DAMPERS	VOLUME/BALANCING DAMPER	
	FIRE DAMPER	
	SMOKE DAMPER	
	FIRE/SMOKE DAMPER	
	BACKDRAFT DAMPER	
DUCT SYSTEM S/A O/A R/A T/A E/A	MOTORIZED DAMPER ABBREVIATIONS SUPPLY AIR OUTSIDE AIR RETURN AIR TRANSFER AIR EXHAUST AIR	
	<b>PIPING LEGEN</b>	ח
— — — HG — — HG	R	OL RETU
G	ENERAL	
1. NOTE AF XX-X UND SCH MEC LINETYPES	<b>S:</b> TIC TO LOCATION INDICATED. PPLIES TO ENTIRE SHEET. ERLINED DESIGNATOR HAS EDULED VALUES, SEE HANICAL SCHEDULES. ISTING (THIN)	
(E) EX (N) NE	W (MEDIUM) ISTING	

\* NOTE \* NOT ALL ABBREVIATIONS, SYMBOLS, OR LEGEND ITEMS SHOWN ON THIS SHEET WILL APPEAR IN THIS SET OF DRAWINGS

## **PIPING SYMBOLS LEGEND**

SIDE DIMENSIONS OF DUCT. DUCT SIZE GUNLESS NOTED OTHERWISE. SEE									
PLY AIR (S/A)									
	RECTANGULAR DUCT TURNED UP/SECTION								
$\otimes$	ROUND/FLAT OVAL DUCT TURNED UP/SECTION								
	RECTANGULAR DUCT TURNED DOWN/AWAY								
	ROUND/FLAT OVAL DUCT TURNED DOWN/AWAY								
JRN AIR (R	/A)								
	RECTANGULAR DUCT TURNED UP/SECTION								
	ROUND/FLAT OVAL DUCT TURNED UP/SECTION								
	RECTANGULAR DUCT TURNED DOWN/AWAY								
$\Box \bigcirc$	ROUND/FLAT OVAL DUCT TURNED DOWN/AWAY								
AUST AIR (I	E/A)								
	RECTANGULAR DUCT TURNED UP/SECTION								
$\bigcirc$	ROUND/FLAT OVAL DUCT TURNED UP/SECTION								
	RECTANGULAR DUCT TURNED DOWN/AWAY								
	ROUND/FLAT OVAL DUCT TURNED DOWN/AWAY								
r symbol:	S								
	DUCT END CAP								

RN LY

	VALVE		- FLOW DIRECTION
	GATE VALVE	S=2%	PIPE SLOPE
	BALL VALVE	.4	& DIRECTION
		KIKI	- REDUCER, CONCENTRIC
	PLUG VALVE BUTTERFLY VALVE		<ul> <li>REDUCER, ECCENTRIC</li> <li>UNION</li> </ul>
	NEEDLE VALVE	] ]	- FLANGES
	SPECIALTY VALVE		<ul> <li>PLANGES</li> <li>BLIND FLANGE/CLEANOU</li> </ul>
	AUTOMATIC BALANCING	П Г	- END CAP
(`A')	VALVE	[]	HOSE QUICK
	BALANCING VALVE		DISCONNECT
	OS & Y VALVE	T	<ul> <li>PT PLUG (TEST PORT)</li> </ul>
	STOP COCK	/	FLEX CONNECTOR/
R	PRESSURE REDUCING VALVE		COUPLING
$\overline{\nabla}$	PRESSURE REGULATING		- EXPANSION JOINT
	VALVE		<ul> <li>EXPANSION GUIDE</li> <li>PIPE ANCHOR</li> </ul>
	CHECK VALVE	~~~~	
	SPRING CHECK VALVE	HD01	_ HOSE THREAD DRAIN BALL VALVE
$-\infty$	RELIEF VALVE	/	- HOSE BIBB
Ţ		/	- WALL HYDRANT
F]	FUEL ANTI-SIPHON VALVE	т.	HOSE THREAD
A	FUSIBLE OIL SAFETY	*++	DRAIN VALVE
	VALVE	<u> </u>	FIRE DEPARTMENT
	MOTORIZED VALVE	$\overrightarrow{B}$	
S S			_ WATER HAMMER ARRESTOR (ELEV)
	SOLENOID VALVE		WATER HAMMER
	AUTOMATIC CONTROL VALVE		ARRESTOR (PLAN)
	STRAINER	 []	- THERMOWELL
	STRAINER W/	Ш	- THERMOMETER
WXXXXXXXXXXXXXXXXXXXXXXXXXXXXXXXXXXXXX	BLOWDOWN	T	
	BACKFLOW PREVENTER	P	- DIAL THERMOMETER
FS	FLOW SWITCH	<del>_</del>	PRESSURE GAUGE W/ COCK
PS	PRESSURE SWITCH		PRESSURE GAUGE
			W/ COCK & SIPHON
Ū	BASKET STRAINER	A	- AIR VENT
— <u> </u>	AIR FILTER W/		A - AUTOMATIC
Ŷ	COALESCER & DRAIN		C - COIN
	AIR FILTER W/ COALESCER, DRAIN,		M - MANUAL H - HIGH VOLUME
Ţ.	REGULATOR & GAUGE		
_	PUMP (SYMBOLIC -		- WALL CLEANOUT
<b>———</b>	ARROW INDICATES	$\ominus$	WALL CLEANOUT
$\sim$	FLOW DIRECTION)	$\otimes$	YARD CLEANOUT
M	WATER METER	$\square$	FLOOR SINK
<u> </u>			FLOOR DRAIN
<u> </u>	PIPE ELBOW DOWN (OR AWAY)	$\ominus$	FLOOR CLEANOUT
0	PIPE ELBOW UP (OR TOWARDS)	۲	
<del></del>	PIPE TEE DOWN (OR AWAY)	0	OVERFLOW DRAIN ROOF/OVERFLOW
	PIPE TEE UP (OR AWAY)	$\bigcirc \bigcirc$	DRAIN COMBO
S	PIPE BREAK		RADIANT MANIFOLD
	HOSE REEL		
	(WALL MOUNT)		

	GENERAL AB	BREVI	ATIONS
L .	COMPRESSED AIR	LAT	LEAVING AIR TEMPERATURE
AV	AUTOMATIC AIR VENT	LB	POUND
F	AIR FLOW SWITCH	LF	LINEAL FOOT
FF	ABOVE FINISH FLOOR	LWT	LEAVING WATER TEMPERATURE
G	ABOVE GROUND	MAV	MANUAL AIR VENT
.UU	AIR HANDLING UNIT	MAX	MAXIMUM
L	ACOUSTIC LINED	MCA	
RCH	ARCHITECT OR ARCHITECTURAL	MFR	MANUFACTURER
SME	AMERICAN SOCIETY OF	MIN	MINIMUM
	MECHANICAL ENGINEERS	MOP	MAXIMUM OVERCURRENT PROTECTION
V	ACID VENT	MUA	MAXIMUM OVERCORRENT FROTECTION MAKEUP AIR
	ACID VENT ACID WASTE	NC	NORMALLY CLOSED
W	AVERAGE WATER TEMPERATURE	N.I.C.	NOT IN CONTRACT
WT			
B	BASEBOARD	NO	
FF	BELOW FINISH FLOOR	NPT	NATIONAL PIPE THREAD
TU	BRITISH THERMAL UNIT	NTS	NOT TO SCALE
V	BALANCING VALVE	OA	OUTSIDE AIR
GW	BELOW GRADE WASTE	OW	OILY WASTE
G	BELOW GRADE	PG	PROPYLENE GLYCOL
A	COMPRESSED AIR	PH	PHASE
FM	CUBIC FEET PER MINUTE	POL	PETROLEUM, OIL, & LUBRICANTS
CLG	CEILING	PRV	PRESSURE REGULATING VALVE
жU	CONCRETE MASONRY UNIT	PSI	POUNDS PER SQUARE INCH GAUGE
0	CARBON MONOXIDE/CLEANOUT	PT	PRESSURE/TEMPERATURE
UH	CABINET UNIT HEATER	PW	PRESSURIZED WASTE
W	COLD WATER	RGR	RADIANT GLYCOL RETURN
B	DRY BULB	RGS	RADIANT GLYCOL SUPPLY
	DIAMETER OR PHASE	RA	RETURN AIR
EMO	DEMOLISH	REQD	REQUIRED
N	DOWN	RL	RAIN LEADER
PS	DIFFERENTIAL PRESSURE SWITCH	RND	ROUND
WG	DRAWING	R.O.	ROUGH OPENING
A	EXHAUST AIR	RP	RADIANT CEILING PANEL
AT	ENTERING AIR TEMPERATURE	RPBP	REDUCED PRESSURE
F	EXHAUST FAN		BACKFLOW PREVENTER
SP	EXTERNAL STATIC PRESSURE	RPM	REVOLUTION PER MINUTE
WT	ENTERING WATER TEMPERATURE	SA	SUPPLY AIR
XH	EXHAUST	SMR	SNOW MELT RETURN
XIST	EXISTING	SMS	SNOW MELT SUPPLY
CO	FLOOR CLEANOUT	SL	SOUNDLINING
D	FLOOR DRAIN, FIRE DAMPER	SQ	SQUARE
DC	FIRE DEPARTMENT CONNECTION	SQ FT	
PC	FIRE PUMP CONTROLLER	SP	
S	FLOOR SINK		STAINLESS STEEL
SD	FIRE SMOKE DAMPER		TEMPERATURE
T	FOOT	TAB	TEST, ADJUST & BALANCE
TR	FINNED TUBE RADIATION	THD	
ן אר או	GAS	TP	
AL		TSP	TOTAL STATIC PRESSURE
PH	GALLONS PER HOUR	TYP	TYPICAL
SPM	GALLONS PER MINUTE	UF	UNDERFLOOR
IB	HOSE BIBB	UG	UNDERGROUND
IP	HORSE POWER	UH	UNIT HEATER
IR	HOUR	UNO	UNLESS NOTED OTHERWISE
ITG	HEATING	V	VENT OR VOLTS
IGR	HEATING GLYCOL RETURN	VAC	VOLTAGE ALTERNATING CURRENT
IGS	HEATING GLYCOL SUPPLY	VAV	VARIABLE AIR VOLUME
IWC	HOT WATER CIRCULATION	VTR	VENT THRU ROOF
W	HOT WATER	W	WASTE
E.	INVERT ELEVATION	WB	WET BULB

#### MEC

- CONTRACTOR TO DEMOLISH EXISTING PLUMBING FIXTURES, PIPING, AND ALL ASSOCIATED ITEMS IN (EXISTING) ARTIST LOFT 1, 2, 3, 4, AND 5. CONTRACTOR TO DEMOLISH FIXTURES, COLD WATER, HOT WATER, HOT WATER CIRC, WASTE, AND VENT TO BELOW SLAB AND CAP.
- 2. CONTRACTOR TO DEMOLISH EXISTING BASEBOARD IN (NEW) IDENTITY GALLERY 1, 2, 3, 4, AND 5 AND PREPARE THE EXISTING 3/4" HEATING GLYCOL SUPPLY AND RETURN PIPES FOR NEW BASEBOARD AND CONNECTIONS.
- CONTRACTOR TO DEMOLISH EXHAUST FAN, EXHAUST GRILLES, AND ALL EXHAUST DUCTWORK SERVING RESTROOMS TO BE DEMOLISHED. THIS INCLUDES BUT MAY NOT BE LIMITED TO 3 EXHAUST FAN EF-3 IN MENS 148, WOMENS 150, LOCKER ROOM 151, AND LOCKER ROOM 147. CONTRACTOR TO DEMOLISH DUCTWORK UP TO CURB AND DEMOLISH ROOF HOOD.
- CONTRACTOR TO DEMOLISH EXISTING SUPPLY GRILLES AND DUCTWORK IN LIBRARY, MENS 148, WOMENS 150, LOCKER ROOM 151, AND LOCKER ROOM 147 DOWNSTREAM OF HC-22 AND 4 HC-25. EXISTING HEATING COILS HC-22 AND HC-25 ARE TO REMAIN. CONTRACTOR TO PROVIDE NEW SUPPLY DUCTWORK, SUPPLY GRILLES AND FLEXIBLE DUCTWORK.
- 5. CONTRACTOR TO DEMOLISH ALL PLUMBING FIXTURES, PIPING, AND ALL ASSOCIATED ITEMS SERVING MENS 148, WOMENS 150, LOCKER ROOM 151, AND LOCKER ROOM 147. CONTRACTOR TO DEMOLISH FIXTURES, COLD WATER, HOT WATER, HOT WATER CIRC, WASTE, AND VENT. DEMOLISH PLUMBING AS REQUIRED TO SERVE NEW CONVERTED USE IN THE AREA. CAP AND PERMANENTLY SEAL REMAINING PRESSURE PIPING. UNDERFLOOR PIPING TO BE DEMOLISHED TO BELOW SLAB, CAPPED, AND ABANDONED-IN-PLACE.
- REPLACE EXISTING FAILED HUMIDIFIERS ON (E) AHU-1 AND (E) AHU-2. DEMOLISH AND DISCARD EXISTING HUMIDIFIERS AND REPLACE WITH NEW UNITS OF SIMILAR SIZE AND SERVICE AS 6. SHOWN ON DRAWINGS.
- INTEGRATE NEW BASEBOARDS INTO EXISTING CONTROLS FOR A COMPLETE AND FUNCTIONAL SYSTEM.

TEST, ADJUST, AND BALANCE MECHANICAL SYSTEMS TO FLOWS INDICATED IN DRAWINGS. TAB CONTRACTOR TO BE TABB OR NEBB CERTIFIED AND CONDUCT WORK IN ACCORDANCE WITH INDUSTRY STANDARDS.

F)

SPACE RESERVED FOR MOA PERMIT STAMP

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FOR: SUBMITTAL

PRICING

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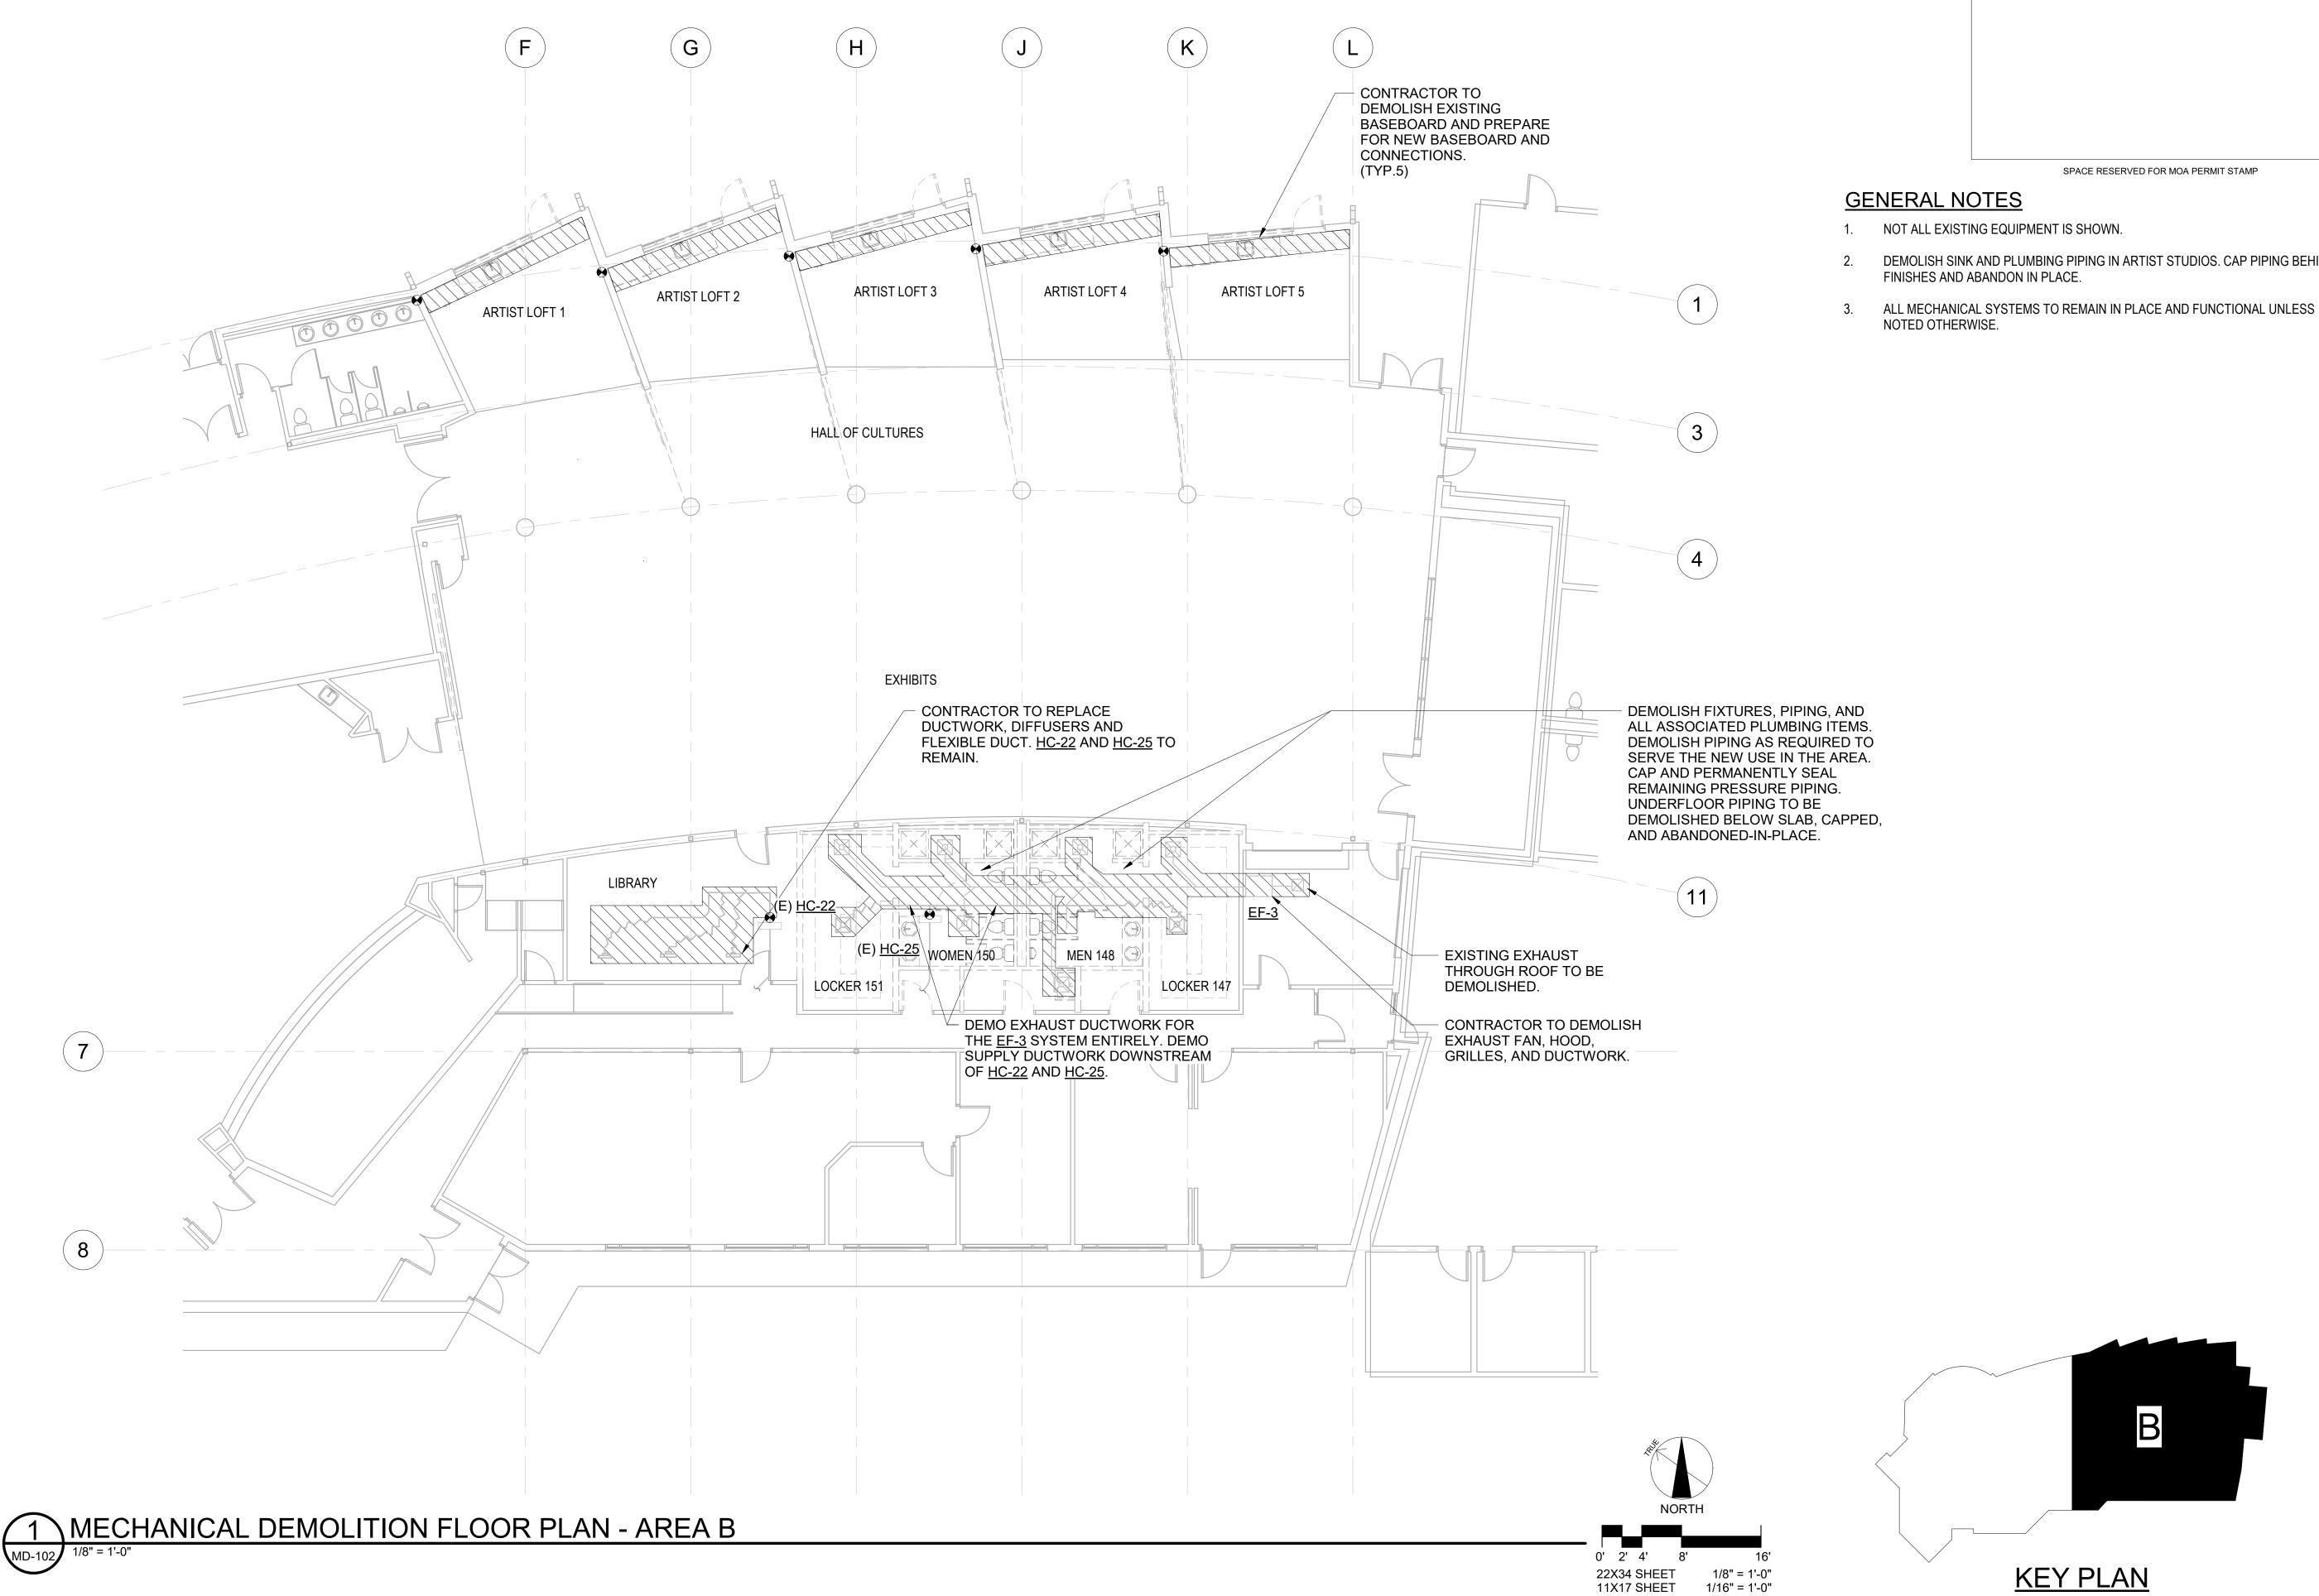
**BID CONSTRUCTION** DOCUMENTS

JOB NO.	231248
DATE:	10.15.2023
PROJ. MGR.:	DCN
DRAWN BY:	CDH
REVIEWED BY:	BLL
REVISIONS:	

#### MECHANICAL LEGEND AND ABBREVIATIONS

SHEET NO.

**M-001** 



F O R: • SUBMITTAL PRICING

DEMOLISH SINK AND PLUMBING PIPING IN ARTIST STUDIOS. CAP PIPING BEHIND FINISHES AND ABANDON IN PLACE.



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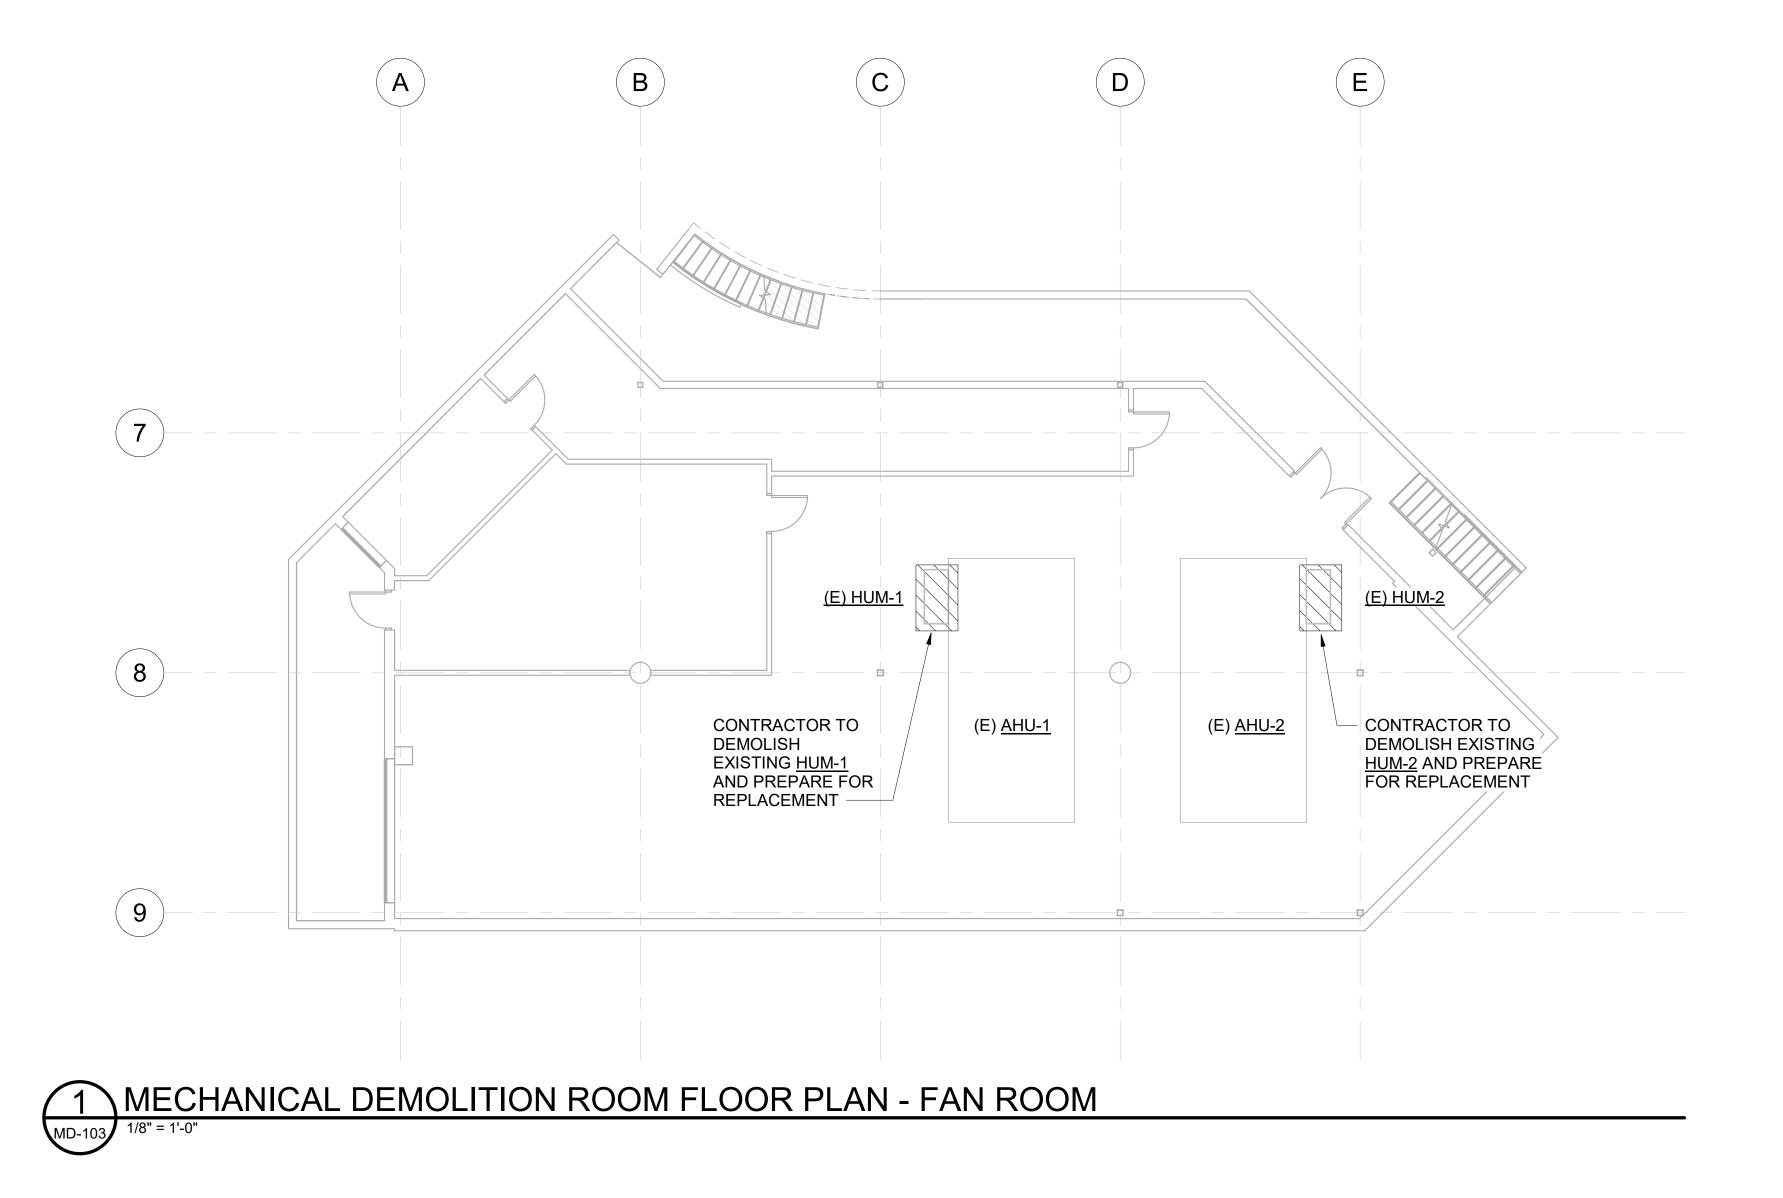
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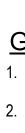
BID CONSTRUCTION DOCUMENTS


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DATE:	10.15.2023
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REVIEWED BY:	BLL
REVISIONS:	

MECHANICAL DEMOLITION FLOOR PLAN -AREA B







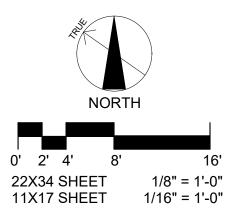

SPACE RESERVED FOR MOA PERMIT STAMP

## **GENERAL NOTES**

1. NOT ALL EXISTING EQUIPMENT IS SHOWN.

2. PREPARE HUMIDIFIER MOUNTING LOCATIONS AND PIPING FOR NEW WORK AS SHOWN ON M-103.



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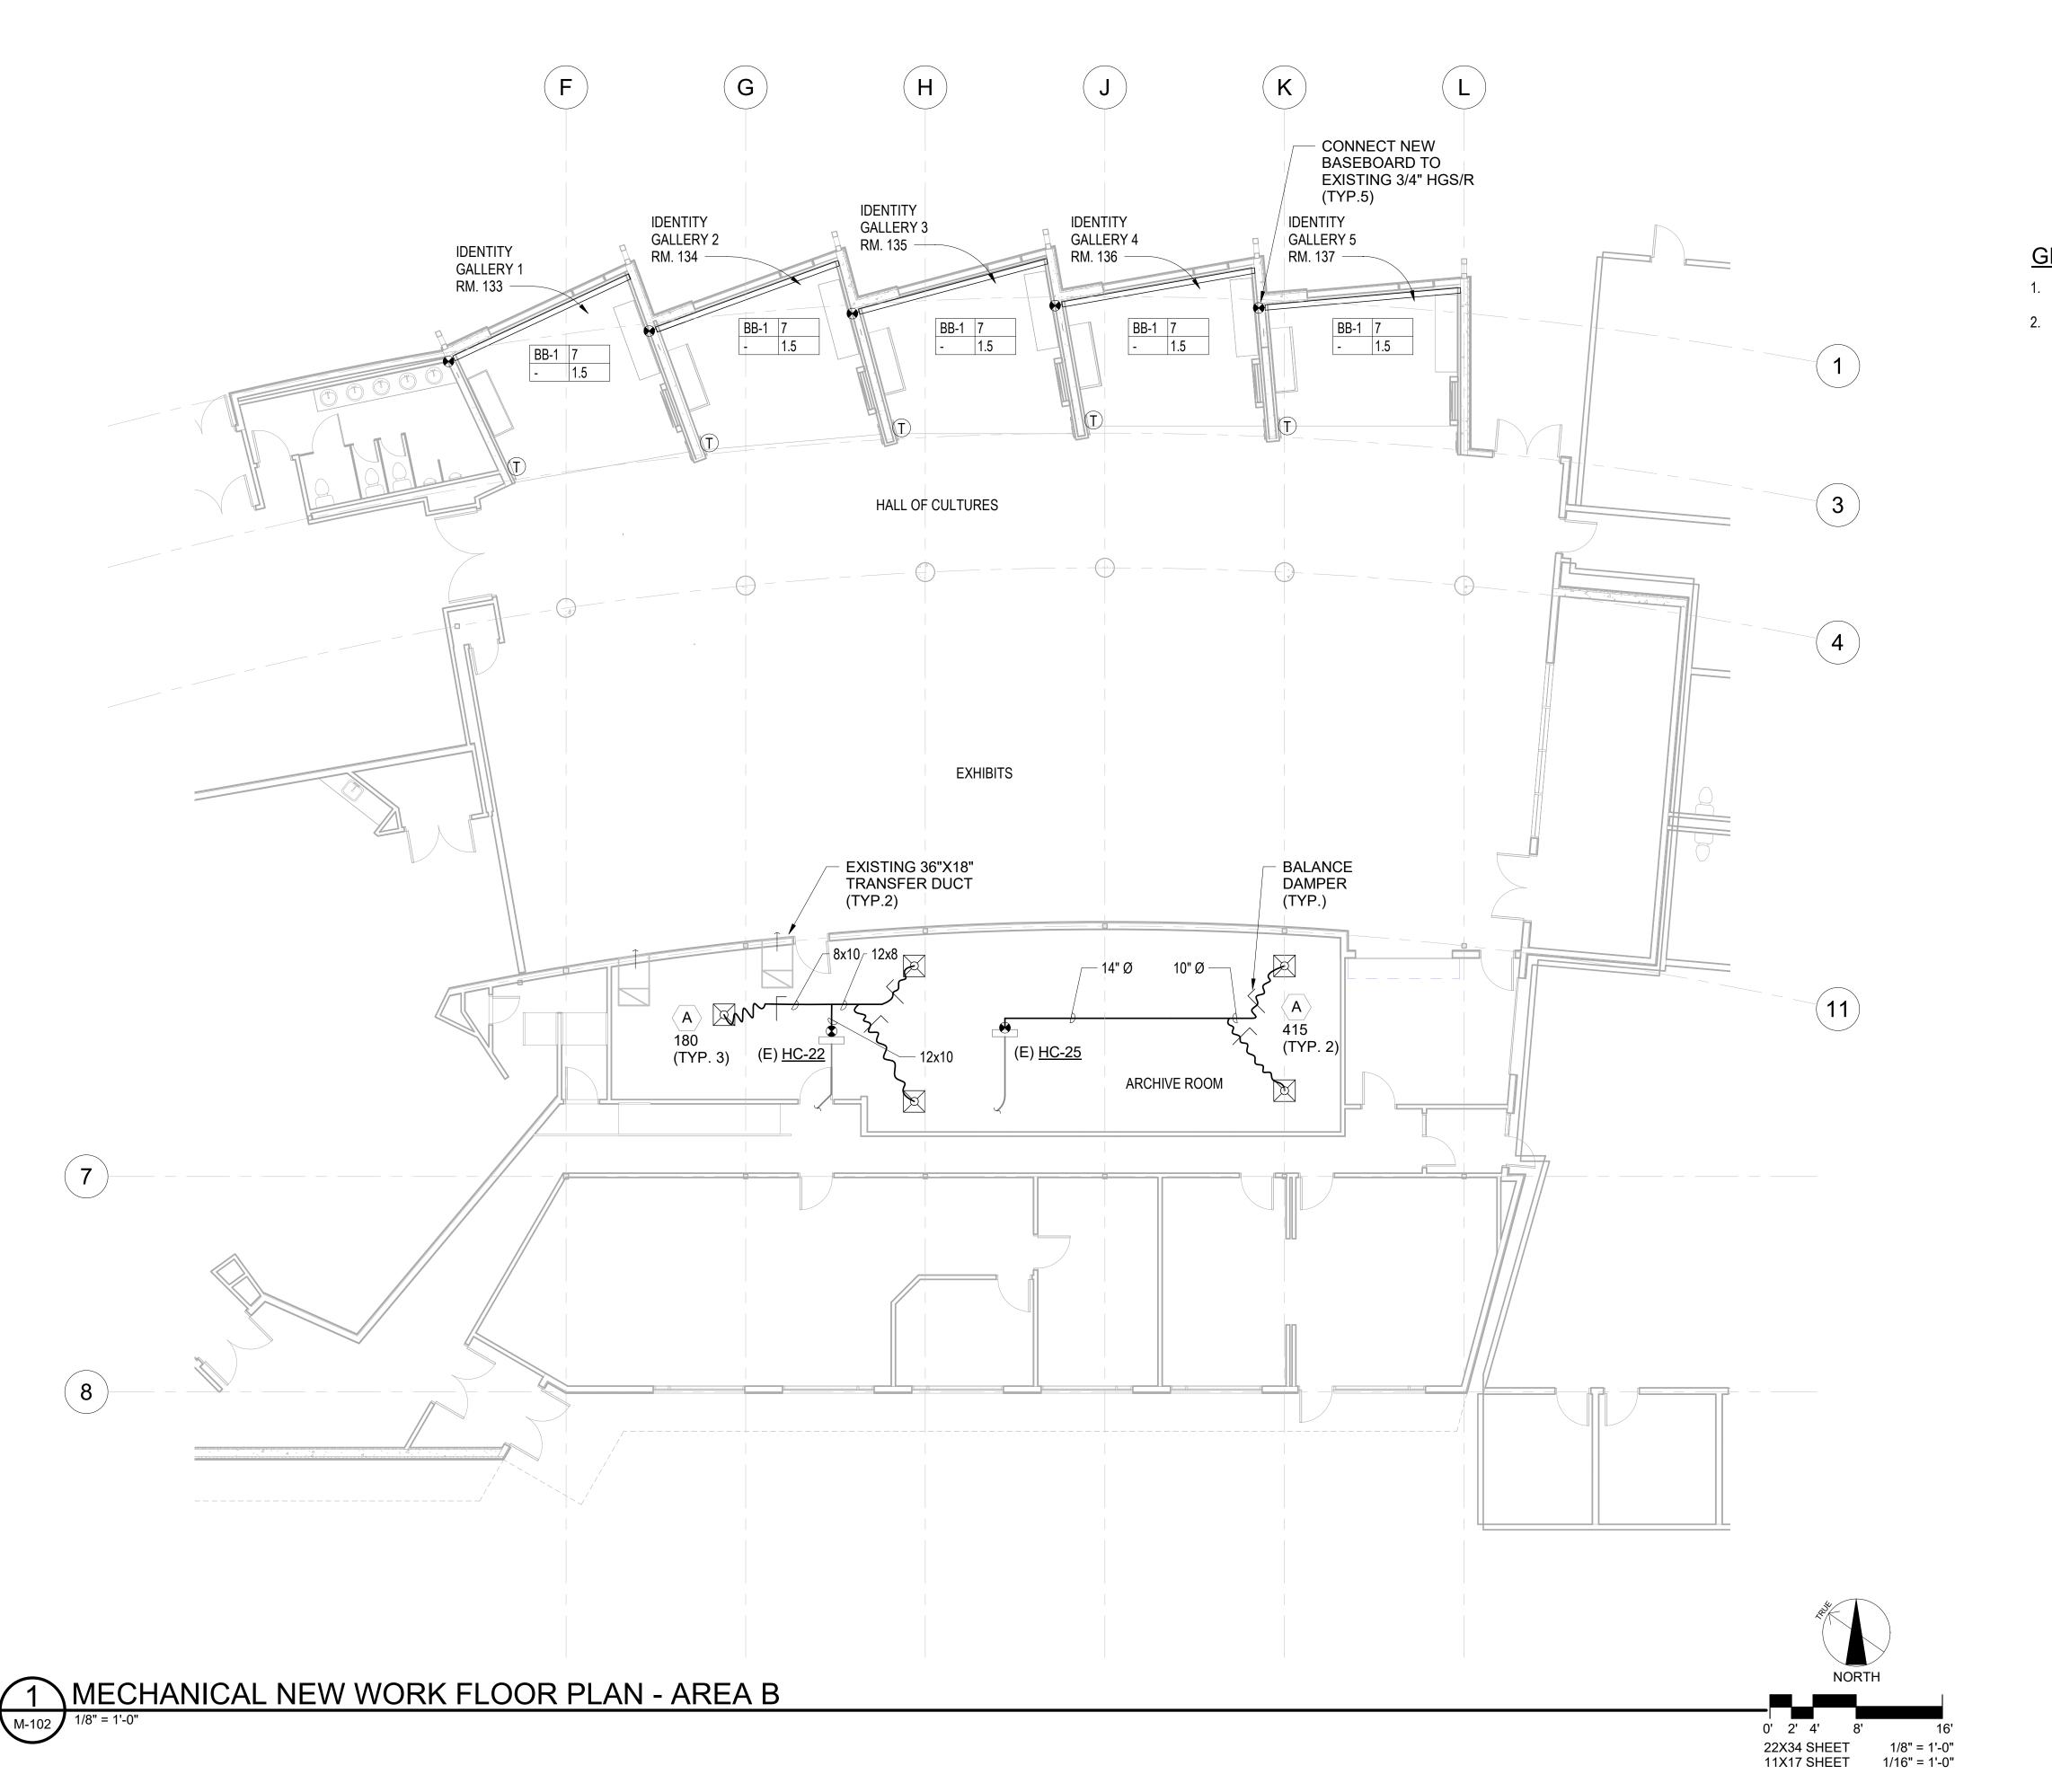
1	
JOB NO.	231248
DATE:	10.15.2023
PROJ. MGR.:	DCN
DRAWN BY:	CDH
REVIEWED BY:	BLL
REVISIONS:	





BASEMENT

<u>KEY PLAN</u>




SPACE RESERVED FOR MOA PERMIT STAMP

## GENERAL NOTES

1. NOT ALL EXISTING EQUIPMENT IS SHOWN.

ARCHIVE ROOM VENTILATION BASED ON 2018 IMC TABLE 403.3.1.1 STORAGE ROOM.

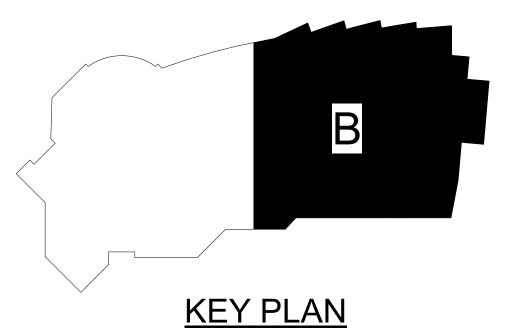

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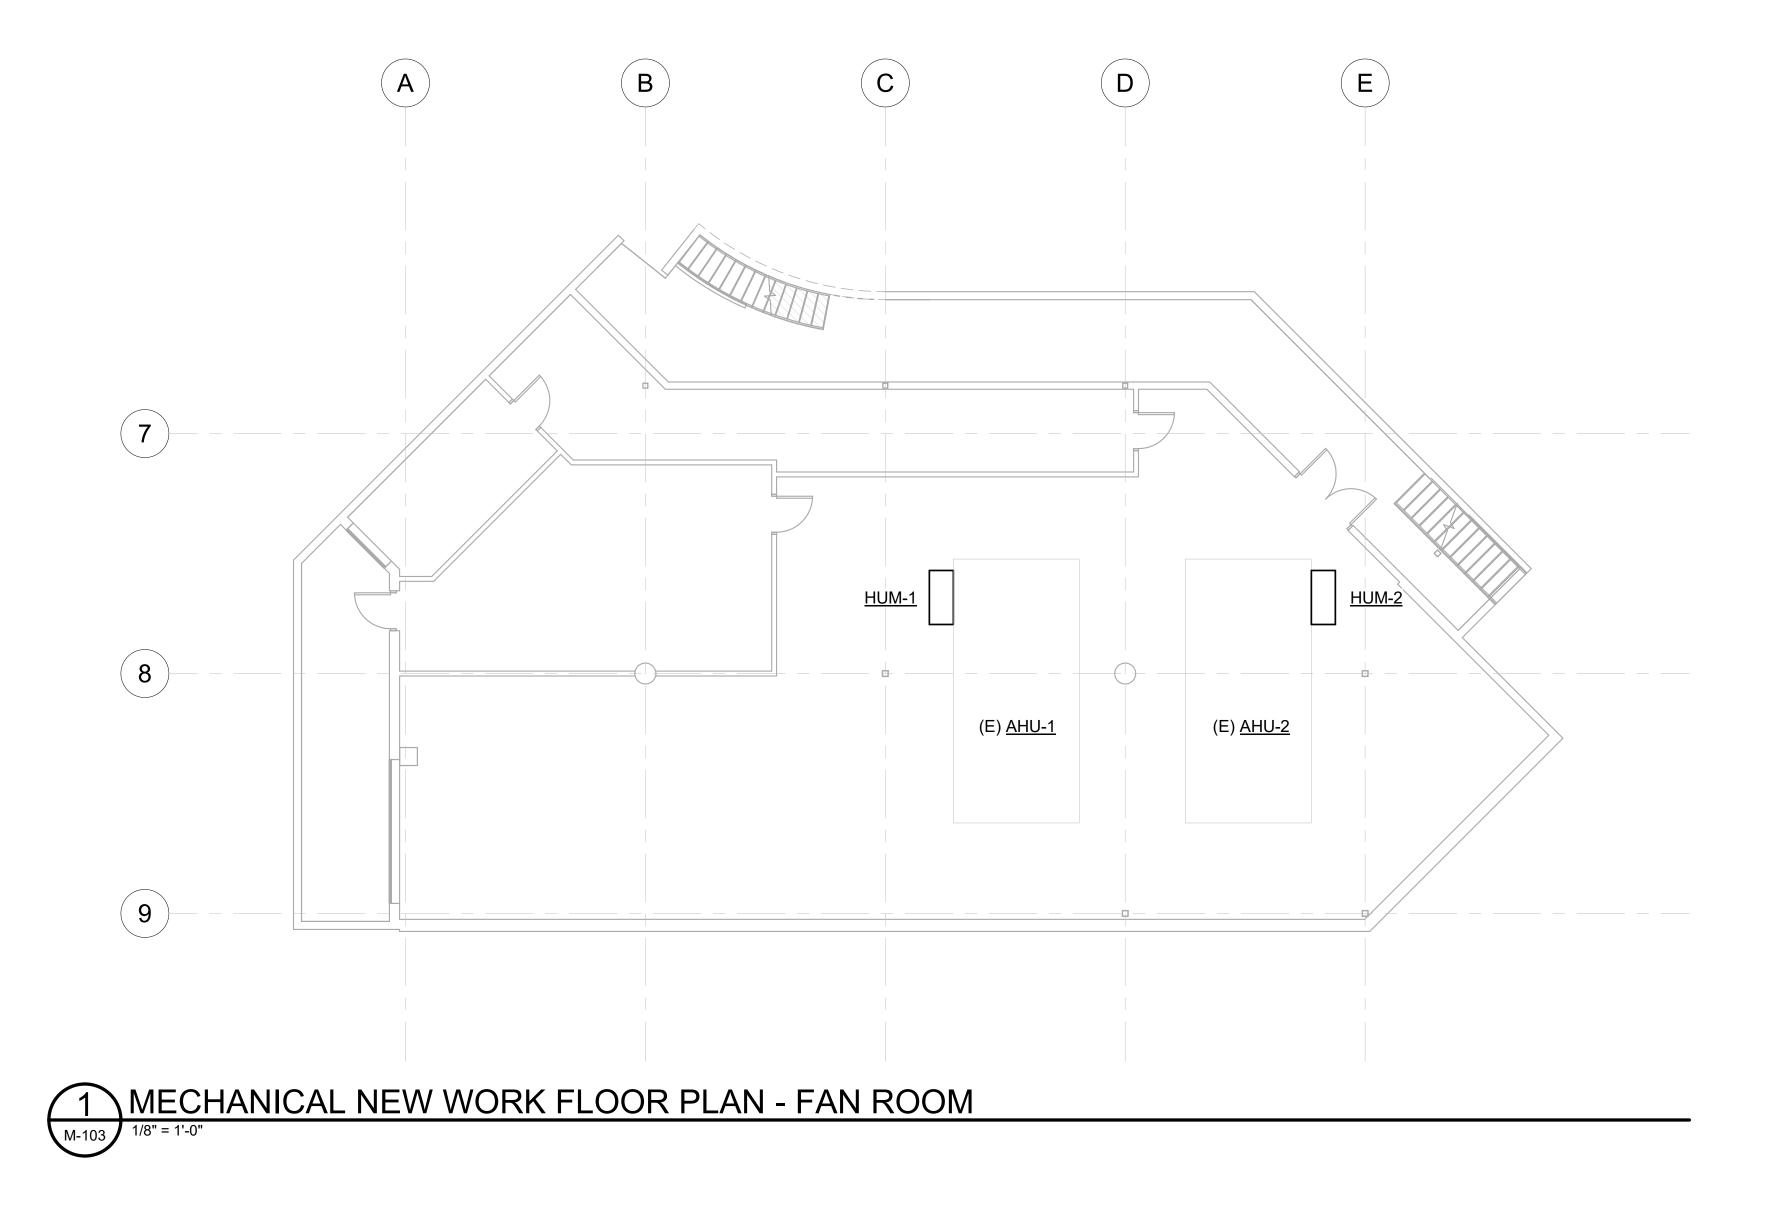
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BID CONSTRUCTION DOCUMENTS


JOB NO.	231248
DATE:	10.15.2023
PROJ. MGR.:	DCN
DRAWN BY:	CDH
REVIEWED BY:	BLL
REVISIONS:	

MECHANICAL FLOOR PLAN -AREA B





<u>G</u> 1. 2.

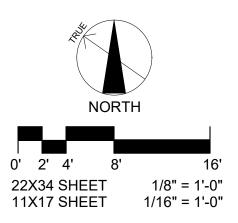

SPACE RESERVED FOR MOA PERMIT STAMP

## **GENERAL NOTES**

1. NOT ALL EXISTING EQUIPMENT IS SHOWN.

PROVIDE NEW HUMIDIFIERS <u>HUM-1</u> AND <u>HUM-2</u> IN SAME LOCATIONS AND SERVICE AS DEMOLISHED HUMIFIDIERS. NEW HUMIDIFERS TO BE PROVIDED WITH ALL NECESSARY CONTROLS, PIPING, APPURTENANCES, AND SPECIALTIES FOR A COMPLETE AND WORKING SYSTEM. PROVIDE NEW ISOLATION VALVES FOR COLD WATER INLET AND CLEAN STEAM OUTLET. TIE INTO EXISTING BUILDING CONTROLS TO ALLOW EXISTING CONTROLS TO CONTROL HUMIDIFIER. F O R: • SUBMITTAL • PRICING



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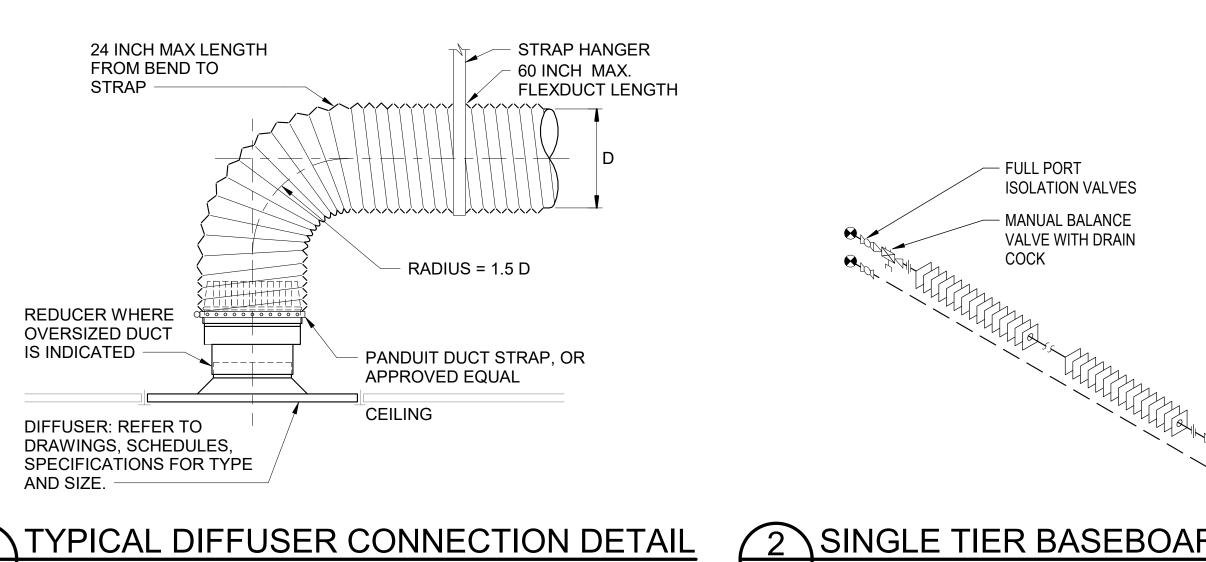
#### ENLARGED MECHANICAL PLAN - FAN ROOM



## BASEMENT

<u>KEY PLAN</u>

1 M-501





	ENCLOSURE					ELEMENT						BASIS OF DESIGN				
TAG	TYPE	SIZ	E (IN.)	MOUNTING	COLOR		SIZE (IN	N.)	FIN/FT.	NO. OF	EGT	LGT	HTG.	MFGR	MODEL	NOTES
	ITE	HT	WIDTH	HEIGHT (IN)	COLOR	TUBE	FIN. HT.	FIN. WIDTH		TIERS	(F)	(F)	CAPACITY (BTU/FT)	WIFGR	WODEL	
<u>BB-1</u>	TOP LOUVERED OUTLET	3-5/8	3-1/2	7-5/8	PER ARCH	3/4	3-1/4	3-1/4	48	1	190	160	672	RITTLING	ETO 3/4C-3-1/4 x 3-1/4-48	1,2,3
NOTES:		·		•	•		•			•						

1. RATING PROVIDED HEREIN HAS BEEN CORRECTED FOR 190°F-160°F AND 50% PG.

2. MOUNTING HEIGHT IS FROM FLOOR TO TOP REAR PANEL OF ENCLOSURE.

3. PROVIDE FULL LENGTH ENCLOSURE (WALL TO WALL).

## AIR INLET AND OUTLET SCHEDULE

TAG	LOCATION	PURPOSE			MAXIMUM	BORDER TYPE	BASIS OF DESIGN		NOTES
TAG	LUCATION	FURFUSE	NECK SIZE (IN.)	FACE SIZE (IN.)	DESIGN CFM	BORDERTIFE	MANUFACTURER	MODEL	NOTES
А	VARIOUS	SUPPLY	VARIOUS	24X24	VARIOUS	LAY IN OR SURFACE	TITUS	TMS	1,2,3

NOTES:


M-501 NTS

1. ALL INLETS TO BE PROVIDED WITH VOLUME DAMPER. SEE PLANS FOR VOLUME DAMPER LOCATED IN DUCTWORK. 2. SELECTIONS AT NC 25 OR LESS FOR ALL AIR TERMINALS ON PLANS. 3. AIR TERMINALS TO BE WITH LAY IN OR PLASTER FRAME AS REQUIRED.

			ŀ	IUM	IDIF	IER SCHED	ULE		
TAG	TYPE	CLEAN STEAM CAPACITY (LB/HR)	ELECTRICAL		BASIS OF DESIGN			NOTES	
			VOLT	PH	A	MFR	MODEL	DIMENSIONS (L"xW"xH")	
<u>HUM-1</u>	ELECTRIC	143.0	460	3	58.8	ARMSTRONG	EHU-804	33.6" x 31.8" x 14.1"	1,2
<u>HUM-2</u>	ELECTRIC	143.0	460	3	58.8	ARMSTRONG	EHU-804	33.6" x 31.8" x 14.1"	1,2
NOTES: 1. DDC I	NTERFACE.	RATED FOR USE W							

2. PROVIDE WITH FULLY PACKAGED CONTROLLER WITH INTEGRAL SAFETIES, COMMUNICATIONS INTERFACE FOR DDC MONITORING AND CONTROL.

SPACE RESERVED FOR MOA PERMIT STAMP

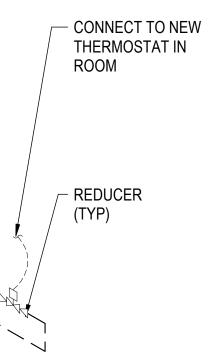


## 2 SINGLE TIER BASEBOARD CONNECTION

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## BID CONSTRUCTION DOCUMENTS

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DATE:	10.15.2023
PROJ. MGR.:	DCN
DRAWN BY:	CDH
REVIEWED BY:	BLL
REVISIONS:	

DIAGRAMS, DETAILS, AND SCHEDULES

SHEET NO.

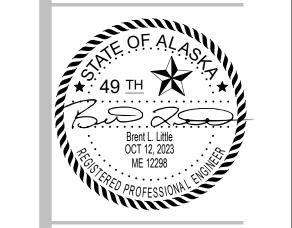**M-501** 

## **GENERAL LIGHTING**

2'x4' SURFACE MOUNTED FIXTURE

1'x4' SURFACE MOUNTED FIXTURE

Ho> UPLIGHT WALL MOUNTED FIXTURE

O RECESSED DOWNLIGHT FIXTURE

O RECESSED DIRECTIONAL FIXTURE

SPECIFIC SWITCHING GROUP

**DIRECTION OF EGRESS**)

EMERGENCY LIGHTING

EXIT SIGN - CEILING MOUNTED (ARROW

INDICATES DIRECTION OF EGRESS)

BATTERY POWERED EMERGENCY LIGHT

₩ EXIT SIGN - WALL MOUNTED (ARROW INDICATES

□ a LOWER-CASE LETTER ADJACENT TO FIXTURE INDICATES

NL INDICATES NIGHT LIGHT WIRED TO UNSWITCHED CIRCUIT

REGION INDICATES FIXTURE WIRED TO EMERGENCY POWER.

NOTE: ANY OF THE ABOVE FIXTURE SYMBOLS WITH A BLACK FILLED

⊲ TRACK LIGHT FIXTURE HEAD -

PENDANT DOWNLIGHT FIXTURE

ID> UPLIGHT PENDANT MOUNTED FIXTURE

2'x4' RECESSED FIXTURE

2'x2' RECESSED FIXTURE

HO WALL MOUNTED FIXTURE

HO► DIRECTIONAL FIXTURE

LIGHT FIXTURE IDENTIFICATION TAG. REFER TO LIGHT

FIXTURE SCHEDULE FOR ADDITIONAL INFORMATION.

## **POWER GENERAL**

- (J) JUNCTION BOX
- MY MOTOR CONNECTION
- G GENERATOR
- $\odot$  EQUIPMENT CONNECTION
- ① THERMOSTAT
- EQUIPMENT CABINET
- $\square$  RECESSED FLOOR BOX
- POKE-THRU TYPE FITTING
- ◎ FLUSH FLOOR COUPLING
- ⊕ EMERGENCY SHUT DOWN SWITCH
- PUSHBUTTON
- XX-X EQUIPMENT TAG REFER TO EQUIPMENT CONNECTION SCHEDULE FOR ADDITIONAL INFORMATION.

## POWER OUTLETS

- DUPLEX RECEPTACLE, SUBSCRIPT INDICATES TYPE: **O - OCCUPANCY SENSOR CONTROLLED** 
  - **G GFCI PROTECTED** WP - WEATHERPROOF WHILE IN USE TV - OUTLET FOR FLAT PANEL TELEVISION
- H● SPECIAL PURPOSE RECEPTACLE
- DUPLEX RECEPTACLE CEILING MOUNTED
- DOUBLE DUPLEX RECEPTACLE
- DOUBLE DUPLEX RECEPTACLE CEILING MOUNTED
- ↔ SINGLE RECEPTACLE
- PEDESTAL DUPLEX RECEPTACLE
- PEDESTAL DOUBLE DUPLEX RECEPTACLE X:X CIRCUIT IDENTIFIER (PANEL:CIRCUIT NUMBER)

LIGHTING CONTROL

5	WALL SWITCH - SUBSCRIPT	INDICATES TYPE:
' !	3 - THREE WAY	M - MANUAL MOTOR STARTER
	D - DIMMER	P - SWITCH W/ PILOT LIGHT
	WP - WEATHERPROOF	K - KEY OPERATED
	LV - LOW VOLTAGE	O - OCCUPANCY SENSOR
a	LOWER-CASE LETTER ADJA INDICATES SPECIFIC SWITC	

COMBINATION EXIT SIGN/EMERGENCY LIGHT - WALL MOUNTED

OCCUPANCY SENSOR - DUAL TECHNOLOGY **CEILING MOUNTED** 

## ALL SYMBOLS AND ABBREVIATIONS DO NOT NECESSARILY APPEAR ON DRAWINGS

## **PROJECT NOTES**

- INFORMATION SHOWN ON THESE DRAWINGS IS BASED ON RECORD DRAWINGS AND NON-DESTRUCTIVE SITE INVESTIGATIONS OF THE BUILDING COMPLETED IN JUNE OF 2023, AND SHALL BE FIELD VERIFIED. ELECTRICAL RECORD DRAWINGS FROM THE ORIGINAL BUILDING CONSTRUCTION ARE AVAIALBLE AS A SET OF REFERENCE DOCUMENTS IN PDF FORMAT.
- 2 CIRCUITING IS IDENTIFIED ON THESE DRAWINGS PER RECORD DRAWINGS AND SHALL BE FIELD VERIFIED. RECORD DRAWING PANEL SCHEDULES ARE PROVIDED AS REFERENCE DOCUMENTATION. CONTRACTOR SHALL FIELD VERIFY EXISTING CIRCUITING AND SWITCHING.
- THE WORK DESCRIBED IN THIS PROJECT WILL RESULT IN A NET LOAD REDUCTION. ALL REPLACEMENT LIGHT FIXTURES ARE LED AND REPRESENT A SIGNIFICANT REDUCTION IN LOAD. THE EXISTING ELECTRICAL SERVICE REMAINS ADEQUATE AND DOES NOT REQUIRE AN UPGRADE FROM THIS PROJECT WORK.
- PORTIONS OF EXISTING INTERIOR LIGHTING OR RECEPTACLE CIRCUITS MAY BE REUSED OR EXTENDED AS REQUIRED FOR NEW DEVICE OR FIXTURE LAYOUT OR 4 CONTROL CHANGES PROVIDED THAT THE CONDUIT AND WIRING MEET ALL PROJECT AND NEC CODE REQUIREMENTS.
- PROJECT INCLUDES DEMOLITION OF EXISTING FLUORESCENT AND HID LIGHT FIXTURES. CONTRACTOR IS RESPONSIBILE FOR DISPOSAL OF ALL MATERIALS REMOVED FROM THIS PROJECT, INCLUDING LAMPS AND BALLASTS WHICH REQUIRE SPECIAL HANDLING AND/OR DISPOSAL. ALL NON-HAZARDOUS/SANITARY WASTE SHALL BE DISPOSED OF BY MUNICIPALITY OF ANCHORAGE SOLID WASTE SERVICES. ALL LAMPS AND BALLASTS MUST BE DISPOSED OF IN ACCORDANCE WITH ALL APPLICABLE FEDERAL, STATE, AND LOCAL WASTE DISPOSAL REGULATIONS. THESE INCLUDE THE U.S. EPA UNIVERSAL WASTE RULES FOR DISPOSAL OF LAMPS CONTAINING MERCURY AND THE U.S. TOXICS SUBSTANCES CONTROL ACT AND EPA RULES FOR DISPOSAL OF BALLASTS CONTAINING PCBS. ALL LIGHTING BALLASTS THAT CONTAIN PCB OR ARE NOT MARKED "NOT CONTAINING PCB", MUST BE DISPOSED OF BY A HAZARD WASTE DISPOSAL COMPANY THAT HAS A CONTRACT WITH A TOXIC SUBSTANCE CONTROL ACT (TSCA) APPROVED FACILITY. THE LIGHTING BALLASTS MUST BE PACKAGED, LABELED AND SHIPPED TO A TSCA APPROVED FACILITY IN ACCORDANCE WITH ALL APPLICABLE EPA AND DOT REGULATIONS.
- THE OWNER SHALL HAVE FIRST RIGHT OF REFUSAL TO SALVAGE ANY REMOVED MATERIALS.
- VERIFY MOUNTING HARDWARE PRIOR TO ORDERING LIGHT FIXTURES. PROVIDE COMPATIBLE MOUNTING ACCESSORIES AND ALL TRIM. FLANGES. SUPPORTS. OUTLET 7 BOXES, ETC. FOR A COMPLETE AND FINISHED INSTALLATION.
- THE ELECTRICAL INSTALLATION SHALL COMPLY WITH THE CURRENT ADOPTED NATIONAL ELECTRIC CODE, NFPA 101, NFPA 72, STATE AND LOCAL AMENDMENTS, AND 8. NECA STANDARDS OF INSTALLATION.
- ALL ELECTRICAL EQUIPMENT AND MATERIALS SHALL BE LISTED AND LABELED FOR THEIR INTENDED APPLICATION BY A NATIONALLY RECOGNIZED TESTING LABORATORY 9 ACCEPTABLE TO THE AUTHORITY HAVING JURISDICTION.
- 10. CONTRACTOR SHALL VERIFY LOCATION OF ALL EXISTING UTILITIES AND STRUCTURES AFFECTING THE WORK. NOTIFY THE PROJECT MANAGER IN WRITING OF ANY DISCREPANCIES BETWEEN EXISTING CONDITIONS AND THOSE SHOWN IN THE CONTRACT DOCUMENTS WHICH ADVERSELY IMPACT THE WORK.
- CONTRACTOR SHALL MAINTAIN CURRENT A RED-LINE SET OF CONSTRUCTION DOCUMENTS DURING CONSTRUCTION. RED-LINE DRAWINGS SHALL BE SUBMITTED TO THE 11. OWNER UPON PROJECT COMPLETION. UPDATE ALL PANEL SCHEDULES REFLECTING CIRCUITING CHANGES MADE BY THIS PROJECT ...

## DISTRIBUTION

- STARTER, 3-POLE, NEMA SIZE 1
- **MINIMUM UNLESS OTHERWISE NOTED** ☑ COMBINATION STARTER/DISCONNECT
- ☐ DISCONNECT SWITCH
- Sh FUSED DISCONNECT SWITCH
- ☑ CONTACTOR

## GENERAL

?> SHEET NOTE, SPECIFIC TO LOCATION INDICATED.

GENERAL NOTE, APPLIES TO ENTIRE SHEET

(E-801 P? PHOTO REFERENCE

## **FIRE ALARM**

FACP FIRE ALARM CONTROL PANEL

- FIRE ALARM HORN STROBE
- ΗF FIRE ALARM PULL STATION
- $\langle S \rangle$ PHOTO ELECTRIC SMOKE DETECTOR

## SECURITY/CCTV

- (M)SECURITY SYSTEM MAGNETIC DOOR SWITCH
- MS SECURITY SYSTEM MOTION SENSOR

## TELECOM

 $\langle |$ DATA OUTLET 18" AFF UNLESS OTHERWISE NOTED. ADJACENT NUMBER INDICATES QUANTITY OF CAT 6 RJ45 JACKS. PROVIDE WITH TWO (2) CAT 6, RJ45 DATA JACKS AND ONE (2) SPARE SPACE PER OUTLET IF NO NUMBER IS INDICATED.

## ABBREVIATIONS

AAMPEREACALTERNATING CURRENTAFFABOVE FINISHED FLOORCCABLE, CONDUIT, COILCBCIRCUIT BREAKERCKTCIRCUITCOCONDUIT ONLYCONTRCONTRACTORCUCOPPERDDEMODISCDISCONNECTDWGDRAWINGEAEACHELECELECTRICALEQUIPEQUIPMENTE, (E)EXISTING TO REMAINETCELECTRONIC THEATRE CONTROLS, INC.FTFEET; FOOTGALVGALVANIZEDGFIGROUND FAULT INTERRUPTERHIDHIGH INTENSITY DISCHARGEKKELVINMAXMAXIMUMMFRMANUFACTURERMINMINIMUMMOAMUNICIPALITY OF ANCHORAGEMTGMOUNTINGNEUTNEUTRALNICNOT TO SCALEPNLPANEL; PANELBOARDR, (R)RELOCATE OR RELOCATEDRMROOMSCHEDULESECTSECTIONSPECSPECIFICATIONSSWSWITCHTEMPORARY; TEMPERATURETYPTYPICALUONUNLESS OTHERWISE NOTEDVVOLT (S)WWATT (S), WIDE (DIM), WESTWGWIRE GUARDWRWARTWGWIRE GUARD	JANEL SCRUE POWER CONNECTION FOR THE SUBJECT WILL RESULT IN A NULL RESULT IN A POWER ADDE FORM THIS PROJECT WORK PANEL SCHEDULES AND PARELS FORM THIS PROJECT WORK PANEL SCHEDULES AND PAREL LOAD CHANGES AND PANEL SCHEDULES AND PANEL DOAD CHANGE         (E) PANEL A       1,010VA         (E) PANEL B       1,010VA         (E) PANEL A       1,010VA         (E) PANEL B       1,045VA         (E) PANEL BE       1,045VA         (E) PANEL RE       1,045VA         (E) PANEL S       1,045WA         (E) P
	<ol> <li>PROVIDE POWER CONNECTION FOR THE ONE FOR ONE EQUIPMENT LOCATED IN THE LOWER LEVEL MECHANIC/</li> <li>PROVIDE REPAIRS TO THE ETC DIMMING SYSTEM TO REPAIRS TO THE SYSTEM TO SYS</li></ol>
	THE MUSEUM LIGHTING.

- 12. CONDUCTORS SHALL BE #12 AWG COPPER MINIMUM OR AS SHOWN ON DRAWINGS. HOME RUN CONDUCTORS SHALL BE #10 AWG COPPER MINIMUM OR AS REQUIRED BY THE NEC. THE MINIMUM SIZE FOR 20A BRANCH CIRCUITS MEASURED FROM THE PANELBOARD TO THE FURTHEST DEVICE ON THE CIRCUIT UNLESS NOTED ON DRAWINGS: #10 AWG CONDUCTORS FOR 120V BRANCH CIRCUITS GREATER THAN 75' #8 AWG CONDUCTORS FOR 120V BRANCH CIRCUITS GREATER THAN 175' INCREASE GROUND CONDUCTOR SIZE PER NEC FOR 15A AND 20A CIRCUITS TRANSITION TO #12 AWG WITHIN 15' OF DEVICE IF A SMALL CONDUCTOR IS REQUIRED FOR DEVICE TERMINATION. 13. OUTAGES OF ELECTRICAL, TELECOMMUNICATIONS, FIRE ALARM, OR SECURITY SYSTEMS SHALL OCCUR AT AN ABSOLUTE MINIMUM. COORDINATE SCHEDULED OUTAGES WITH THE OWNER. 14. PROTECT ALL MATERIALS AND EQUIPMENT DURING THE ENTIRE DURATION OF CONSTRUCTION WORK AGAINST CONTAMINATION OR DAMAGE. REPLACE OR REPAIR TO ORIGINAL MANUFACTURED CONDITION ANY ITEMS DAMAGED DURING CONSTRUCTION. IMMEDIATELY REPORT TO PROJECT MANAGER ANY ITEMS FOUND DAMAGED PRIOR TO COMMENCING CONSTRUCTION. 15. CONTRACTOR IS RESPONSIBLE FOR ALL PROJECT RELATED SAFETY MEASURES ON SITE DURING THE PROJECT CONSTRUCTION PERIOD. 16. THIS PROJECT INCLUDES WORK WHICH REQUIRES ACCESS TO FIXTURES AT HIGH MOUNTING HEIGHTS. CONTRACTOR SHALL PROVIDE SUITABLE EQUIPMENT TO SAFELY PERFORM THE WORK AND PROVIDE PROTECTION FOR FLOOR SURFACES FROM LIFT OR SCAFFOLDING TYPE EQUIPMENT. COORDINATE THE PROJECT WORK SCHEDULE AND EQUIPMENT ACCESS WITH THE PROJECT MANAGER 17. DRAWINGS ARE SCHEMATIC ONLY AND DO NOT SHOW ALL CONDUIT AND CONNECTIONS BETWEEN RESPECTIVE DEVICES AND FIXTURES. CONTRACTOR SHALL DETERMINE THE EXACT ROUTING OF CONDUIT, CABLE, AND WIRING CONNECTIONS BETWEEN RESPECTIVE DEVICES AND FIXTURES FOR A COMPLETE AND OPERATIONAL SYSTEM. 18. UPON COMPLETION OF RELOCATION OF FIRE ALARM DEVICES, FIRE ALARM PANEL SHALL BE TESTED AND CERTIFED PER NFPA 72 REACCEPTANCE TESTING REQUIREMENTS. PROVIDE TEST REPORT TO AHJ AS REQUIRED. 19. AN (R) ADJACENT TO A DEVICE INDICATES REMOVE AND RE-INSTALL EXISTING DEVICE. REMOVE CEILING AND WALL MOUNTED LIGHT FIXTURES AND DEVICES AND RE-INSTALL AT LOCATION INDICATED ON PLAN. PROVIDE MOUNTING HARWARE TO MOUNT AT NEW LOCATION AND EXTEND WIRING AS REQUIRED. 20. AN (E) ADJACENT TO A DEVICE INDICATES EXISTING TO REMAIN. PROTECT EXISTING DEVICES FROM DAMAGE DURING CONSTRUCTION. MAINTAIN CONNECTIVITY OF EXISTING DEVICES TO REMAIN.

ED FOR MOA PERMIT STAMP

A NET LOAD REDUCTION. THE DOES NOT REQUIRE AN ES ARE PROVIDED FOR ALL ES ARE SUMMARIZED BELOW:

DICATED ON THE PLANS. PROVIDE PROVIDE ALL CONDUIT/WIRING OF THE LIGHTING UPGRADES ARE

THE PLANS AS PART OF REMODEL TAGE DEVICES AS REQUIRED FOR IRE ALARM RE-TEST AND

ONE REPLACEMENT OF MECHANICAL NICAL ROOM.

TO RESTORE SCENE CONTROL OF

PROVIDE NEW LED COLOR STAGE LIGHTING WITH WIRELESS CONSOLE CONTROL FOR THE GATHERING ROOM STAGE. (ALTERNATE BID ITEM #6).

PROJECT INCLUDES ALTERNATE BID ITEMS. REFER TO ARCHECTURAL GENERAL SHEET FOR COMPLETE LIST OF ALTERNATE BID ITEMS. CONTRACTOR SHALL PROVIDE A SEPARATE PRICE FOR EACH ALTERNATE BID ITEM. THE ALTERNATE BID ITEM FOR ELECTRICAL IS AS FOLLOWS:

PROJECT WORK ASSOCIATED WITH THE INSTALLATION OF THE GATHERING ROOM STAGE LIGHTS. IDENTIFIED AS "ADD ALTERNATE #6" WITHIN ELECTRICAL PLANS.

MCG **EXPLORE** DESIGN

FOR:

SUBMITTAL PRICING

> 421 West 1st Avenue, Suite 300 Anchorage, Alaska 99501 907.563.8474 | F 907.563.4572 exploredesign.com





Owner

#### ALASKA NATIVE HERITAGE CENTER REMODEL

8800 Heritage Center Drive, Anchorage, Alaska

**BID CONSTRUCTION** DOCUMENTS

JOB NO.	231248
DATE:	10.15.2023
PROJ. MGR.:	DCN
DRAWN BY:	MAG
REVIEWED BY:	LRH
REVISIONS:	

#### ELECTRICAL PROJECT NOTES. LEGEND AND ABBREVIATIONS

SHEET NO.

E-00'

#### ELECTRICAL SPECIFICATIONS

<u>RT ′</u>		<u>GENERAL</u> OF WORK	<u>PART</u> 2.1	<u>2</u> GENE	<u>PRODI</u> RAL
	Α.	PROVIDE ALL LABOR. EQUIPMENT, MATERIALS, AND SERVICES REQUIRED FOR A COMPLETE INSTALLATION,		Α.	MATER THE U
	B.	TESTING, AND STARTUP OF ALL SYSTEMS DENOTED ON THE PLANS AND SPECIFICATIONS. VERIFY EXISTING AND LOCAL CONDITIONS AFFECTING THE ELECTRICAL WORK PRIOR TO COMMENCEMENT OF			LABOF
		PROJECT.	2.2	LABEL	ING
		RICAL DRAWINGS AND SYMBOLS		А.	PROVI
		ELECTRICAL DRAWINGS ARE DIAGRAMMATIC AND ARE NOT INTENDED TO SHOW ALL FEATURES OF WORK. HOWEVER, THE CONTRACTOR SHALL PROVIDE PRODUCTS NECESSARY FOR A COMPLETE AND OPERABLE		В.	REVIS PROVI PANEL
		SYSTEM IN ACCORDANCE WITH NEC, NFPA 101, NFPA 72, AND ALL LOCAL AMENDMENTS. INSTALL UN-DIMENSIONED ELECTRICAL ITEMS IN A MANNER TO PROVIDE SYMMETRICAL APPEARANCE. DO	2.3	WIRIN	
		NOT SCALE DRAWINGS FOR EQUIPMENT LOCATION. REVIEW ALL DRAWINGS FOR LOCATIONS. ADJUST WORK		Α.	PROV
		TO CONFORM TO ACTUAL FIELD CONDITIONS.			TEMPE
		DRAWING SYMBOLS USED FOR BASIC MATERIALS, EQUIPMENT, ETC., ARE DENOTED BY INDUSTRY STANDARD SYMBOLS. SPECIAL ITEMS ARE DENOTED BY SYMBOL LEGEND OR CALLED OUT ON THE DRAWINGS OR		B.	COND PROV
		STINDOLS. SPECIAL TIENS ARE DENOTED BY STINDOL LEGEND OR CALLED OUT ON THE DRAWINGS OR SPECIFICATION.		υ.	THE L
	COORE	DINATION		C.	WIRIN
		EXPOSED RACEWAYS AND CABLES WHERE SPECIFICALLY ALLOWED SHALL BE ROUTED IN SUCH A MANNER			1.
		AGREEABLE TO THE ENGINEER. COORDINATE ALL SUCH WORK PRIOR TO INSTALLATION. OBTAIN WRITTEN PERMISSION FROM ENGINEER OR OWNER'S REPRESENTATIVE PRIOR TO CUTTING, DRILLING			2. 3.
		OR WEAKENING STRUCTURAL COMPONENTS.		D.	ALL CO
	C.	COORDINATE WITH OWNER'S REPRESENTATIVE TO FORM A WORK PLAN AND SCHEDULE. SOME AREAS OF THE		E.	PERFO
		BUILDING MAY BE OFF LIMITS TO THE CONTRACTOR DURING SPECIFIC HOURS. WORK PLAN SHALL BE		F.	MAKE TEMPI
		SUBMITTED FOR APPROVAL. NG AND REPAIR		G.	WHER
		ALL BUILDING MATERIALS, EQUIPMENT AND FURNITURE DAMAGED DURING THE INSTALLATION OF THE WORK		0.	TERM
		MUST BE REPAIRED OR REPLACED WITH MATERIALS IN LIKE KIND AND QUALITY OF THE ORIGINAL BY SKILLED		H.	THE P
		LABOR EXPERIENCED IN THAT BUILDING TRADE.			
	В.	ITEMS SCRATCHED OR MARRED IN SHIPMENT OR INSTALLATION SHALL BE REFINISHED WITH TOUCHUP PAINT SELECTED TO MATCH INSTALLED EQUIPMENT FINISH.	2.4	RFCF	PTACLE
	REGUL	ATIONS		A.	GENE
	A.	CODES: PERFORM ALL WORK IN ACCORDANCE WITH NATIONAL, STATE AND LOCAL CODES INCLUDING:			FSUL
		1. NFPA 70 – NATIONAL ELECTRICAL CODE (NEC)	2.5	\ <b>Λ/Δ</b> ΙΙ	BRYAN PLATES
		<ol> <li>NFPA 72 AND 101 – NATIONAL FIRE ALARM CODE AND NATIONAL LIFE SAFETY CODE</li> <li>ANSI/IEEE C2 – NATIONAL ELECTRICAL SAFETY CODE (NESC)</li> </ol>	2.0	A.	DECO
		4. INTERNATIONAL BUILDING CODE (IBC)	2.6	DEVIC	ES GEN
		5. INTERNATIONAL FIRE CODE (IFC)		A.	INSTA
		<ol> <li>AMERICANS WITH DISABILITIES ACT ACCESSIBILITY GUIDELINES (ADAAG)</li> <li>STATE OF ALASKA AMENDMENTS TO NEC, IBC, AND IFC</li> </ol>		В. С.	INSTA INSTA
		8. MUNICIPALITY OF ANCHORAGE AMENDMENTS TO NEC, IBC AND IFC		0.	INSTR
		9. ALASKA ADMINISTRATIVE CODE 8AAC 70 ELECTRICAL SAFTEY CODE		D.	INSTA
	В.	STANDARDS: PROVIDE ALL EQUIPMENT, MATERIALS AND INSTALLATION IN CONFORMANCE WITH THE		E.	INSTA AREAS
		FOLLOWING LATEST CURRENT PUBLICATIONS AND STANDARDS AS APPLICABLE. 1. UNDERWRITER'S LABORATORY (UL)	2.7	GROU	
		2. AMERICAN NATIONAL STANDARDS INSTITUTE (ANSI)		A.	EQUIF
		3. AMERICAN SOCIETY OF TESTING AND MATERIÀLS (ÁSTM)			CIRCL
		4. ILLUMINATING ENGINEERING SOCIETY (IES)	2.8		ELEC1
		<ol> <li>5. NATIONAL ELECTRICAL CONTRACTORS ASSOCIATION (NECA)</li> <li>6. NATIONAL ELECTRICAL MANUFACTURERS' ASSOCIATION (NEMA)</li> </ol>	2.0	A.	PROV
		<ol> <li>INTERNATIONAL ELECTRICAL TESTING ASSOCIATION (NETA)</li> </ol>			PLANS
	C.	CERTIFICATE OF INSPECTION: OBTAIN A CERTIFICATE OF ELECTRICAL INSPECTION FROM THE LOCAL		В.	
		INSPECTING AUTHORITY INDICATING FINAL ACCEPTANCE. SUBMIT TO OWNER UPON COMPLETION OF THE PROJECT AS PART OF PROJECT CLOSEOUT.			PHOT DEPRI
		SAFETY MEASURES TO BE TAKEN: THE ENGINEER HAS NOT BEEN RETAINED OR COMPENSATED TO PROVIDE			COMP
		DESIGN AND CONSTRUCTION REVIEW SERVICES RELATING TO THE CONTRACTOR'S SAFETY PRECAUTIONS OR		C.	CORR
		TO MEANS, METHODS, TECHNIQUES, SEQUENCES, OR PROCEDURES REQUIRED FOR THE CONTRACTOR TO		D.	ALL LI
		PERFORM WORK. CONTRACTOR WILL BE SOLELY AND COMPLETELY RESPONSIBLE FOR CONDITIONS OF THE JOB SITE, INCLUDING SAFETY OF ALL PERSONS AND PROPERTY DURING PERFORMANCE OF WORK. THIS		E.	SET TI
		REQUIREMENT WILL APPLY CONTINUOUSLY AND NOT BE LIMITED TO NORMAL WORKING HOURS. THE DUTY OF		F.	PROV
		THE ENGINEER TO CONDUCT CONSTRUCTION OBSERVATIONS OF THE CONTRACTOR'S PERFORMANCE IS NOT			PLANS
		INTENDED TO INCLUDE REVIEW OF THE ADEQUACY OF THE CONTRACTOR'S SAFETY MEASURES, IN, ON, OR NEAR CONSTRUCTION SITE.		G.	ETC. LED D
		TY ASSURANCE		0.	THE O
	A.	WORKMANSHIP IS CONSIDERED IMPORTANT AND IS SUBJECT TO APPROVAL. EMPLOY WORKMEN SKILLED IN			HAVE
		THE TRADE AND FAMILIAR WITH PARTICULAR TECHNIQUES APPLICABLE TO VARIOUS SECTIONS OF WORK.		H.	PROV MINIM
		PROVIDE ALL MATERIALS TO CONFORM WITH APPLICABLE INDUSTRY STANDARDS AND UNDERWRITERS LABORATORIES STANDARDS. WHENEVER POSSIBLE, SIMILAR ITEMS SHALL BE SUPPLIED BY THE SAME	2.9	EMER	GENCY
		MANUFACTURER THROUGHOUT THE PROJECT.		A.	MAINT
	SUBMI		0.40		
		CONTRACTOR SHALL SUBSTANTIATE CONFORMANCE TO THIS SPECIFICATION BY SUPPLYING THE NECESSARY	2.10	LIGHT A.	ING CO INSTA
		DOCUMENTS, PERFORMANCE DATA AND WIRING DIAGRAMS. ANY DEVIATIONS TO THIS SPECIFICATION MUST BE CLEARLY STATED BY LETTER AND SUBMITTED FOR APPROVAL.		<i>г</i> <b>л</b> .	MANU
		SUBMIT STANDARD CATALOG LITERATURE FOR ALL DIMMING SYSTEM AND LIGHT FIXTURES AND CONTROLS			LIGHT
		WHICH INCLUDES PERFORMANCE SPECIFICATIONS INDICATING COMPLIANCE TO THE SPECIFICATION. INCLUDE	2.11		JLAR DI
		PHYSICAL DESCRIPTION, DRIVER DATA, ENERGY EFFICIENCY DATA, AND LIFE, OUTPUT, EFFICIENCY FOR ALL LUMINAIRE TYPES. PROVIDE SHOP DRAWINGS FOR THE DIMMING SYSTEM MODIFICATIONS.		Α.	SUMM DIMMI
		CATALOG SHEETS MUST CLEARLY INDICATE COMPLETE PART NUMBERS AND MEANS OF ATTACHING LIGHT			THE S
	-	FIXTURES TO SUPPORTS, AND INDICATION THAT ATTACHMENT IS SUITABLE FOR COMPONENTS INVOLVED.		-	ALLO\
	WARR/			В.	ALL N
		WARRANTY: THE CONTRACTOR SHALL GUARANTEE ALL WORK INSTALLED UNDER THIS SPECIFICATION AND MAKE GOOD, REPAIR, OR REPLACE AT THIER OWN EXPENSE, ANY DEFECTIVE WORK, MATERIALS OR PARTS		C.	ENGL
		WITHIN ONE YEAR AFTER FINAL ACCEPTANCE, IF, IN THE OPINION OF THE ARCHITECT, SAID DEFECT IS DUE TO			INSTA
		IMPERFECTION IN MATERIAL, DESIGN, OR WORKMANSHIP.	2.12		
	В.	WARRANTY FOR LED LUMINAIRES: MANUFACTURER'S STANDARD FORM IN WHICH MANUFACTURER AGREES		А.	
	EQUIP	TO REPAIR OR REPLACE FIXTURES THAT FAIL IN MATERIALS OR WORKMANSHIP WITHIN WARRANTY PERIOD. MENT SCHEDULES			AS RE
		FIXTURE AND EQUIPMENT SCHEDULES ON THE DRAWINGS DENOTING CAPABILITIES, RATINGS, SIZES, ETC.,		В.	ALL U
		SHOWN ARE THE MINIMUM ACCEPTABLE AND MAY NOT NECESSARILY CORRESPOND WITH CATALOG RATINGS		C	AWG,
		OR EQUIPMENT SPECIFIED.		C.	ALL U
					CONF

LS AND EQUIPMENT SHALL BE ACCEPTABLE TO THE AUTHORITY HAVING JURISDICTION AS SUITABLE FOR INTENDED. ALL ELECTRICAL EQUIPMENT SHALL BEAR THE SEAL OF A NATIONALLY RECOGNIZED TESTING ORY FOR THE PURPOSE FOR WHICH IT IS INSTALLED.

TYPED CIRCUIT DIRECTORY FOR EACH BRANCH CIRCUIT PANEL BOARD IMPACTED BY THIS PROJECT. RECTORY TO REFLECT CIRCUITING CHANGES TO MATCH AS-BUILT CONDITIONS. CIRCUIT LABELS AT ALL JUNCTION BOX AND OUTLET LOCATIONS. PROVIDE THERMAL LABELS INDICATING ID CIRCUIT NUMBER ON ALL RECEPTACLE FACE PLATES.

- ALL CONDUCTORS SIZED PER NEC REQUIREMENTS INCLUDING ADJUSTMENT FACTORS FOR AMBIENT TURE AND MORE THAN THREE CURRENT CARRYING CONDUCTORS PER RACEWAY. THE MINIMUM FOR SIZE IS #12 AWG, OR AS SHOWN ON THE DRAWINGS. ALL BRANCH CIRCUITS SIZED TO PROVIDE LESS THAN 3% VOLTAGE DROP FROM THE PANEL BOARD TO DEVICE ON THE CIRCUIT. USE THE LOAD PROVIDED IN THE PANEL SCHEDULE FOR CALCULATIONS. IAY BE "MC" CABLE AS ALLOWED BY THE NEC, WITH THE FOLLOWING EXCEPTIONS: EDERS TO ALL PANELS SHALL BE IN CONDUIT. . UNDERGROUND WIRING SHALL BE IN SCHEDULE 40 PVC CONDUIT. . EXPOSED WIRING SHALL BE IN EMT CONDUIT. UCTORS SHALL BE COPPER. WIRING CONNECTIONS AND SPLICES ONLY IN ACCESSIBLE OUTLET OR JUNCTION BOXES ICES, TAPS, AND TERMINATIONS TO CARRY FULL AMPACITY OF CONDUCTORS WITH NO PERCEPTIBLE. **TURE RISE**. TRANDED CONDUCTORS ARE TERMINATED ON SCREW TYPE TERMINALS. INSTALL CRIMP ON FORK LS. DO NOT PLACE BARE STRANDED CONDUCTORS DIRECTLY UNDER SCREWS. I DRAWINGS INDICATE SOME LIGHTING CIRCUITS TO BE REWIRED FROM A 277V PANEL TO A 120V PANEL DRTIONS OF THE EXISTING WIRING. THE EXISTING CONDUCTORS SHALL BE COLOR TAPED WITH 120V AT EACH JUNCTION BOX AND LABELED AS "120V". PURPOSE RECEPTACLES: SPECIFICATION GRADE, DUPLEX NEMA 5-20R, 120 VOLT, 20 AMP, UL 498 AND 596-G, BACK AND SIDE WIRED, WHITE NYLON FACE. PASS AND SEYMOUR 5362-W, HUBBELL 5362-W, 5362-W, LEVITON 5362-W. IVE COVER PLATE: COMMERCIAL GRADE STAINLESS STEEL DEVICES PLUMB AND LEVEL. SWITCHES 48 INCHES ABOVE FLOOR, WITH OFF POSITION DOWN. VALL DIMMERS TO ACHIEVE FULL RATING SPECIFIED AND INDICATED AFTER DERATING FOR GANGING AS TED BY MANUFACTURER. PROVIDE SWITCHES THAT MATCH THE DRIVER FOR THE FIXTURE. RECEPTACLES WITH GROUNDING POLE ON BOTTOM. STAINLESS STEEL DECORATIVE PLATES ON SWITCH, RECEPTACLE, AND BLANK OUTLETS IN FINISHED NT GROUNDING CONDUCTOR: INSTALL SEPARATE, INSULATED CONDUCTOR WITHIN EACH BRANCH RACEWAY. TERMINATE EACH END ON SUITABLE LUG, BUS, OR BUSHING. PROVIDE BOND TO EVERY CAL BOX AND ENCLOSURE. XTURES IN ACCORDANCE WITH LIGHTING FIXTURE SCHEDULE ON DRAWINGS AND AS SHOWN ON LIGHTING PLIFE OF 50,000 HOURS MINIMUM BASED ON A 70% LUMEN OUTPUT AT 50,000 HOURS. LED FIXTURE TRIC TESTING IN ACCORDANCE WITH IESNA LM-79-2008. LED METHOD OF MEASURING LUMEN ATION OF THE LED LIGHT SOURCE SHALL BE IESNA LM-80-2008. LED FIXTURE COMPONENTS SHALL WITH UL 8750. TED COLOR TEMERATURE (CCT) AS INDICATED ON THE LIGHT FIXTURE SCHEDULE. FING FIXTURES INDEPENDENTLY SUPPORTED FROM STRUCTURE AND NOT SOLELY SUPPORTED BY PROVIDE SUPPORT PER IBC REQUIREMENTS. , FREE OF LIGHT LEAKS, WARPS, DENTS, OR OTHER IRREGULARITIES. IN ACCORDANCE WITH LIGHTING FIXTURE SCHEDULE ON DRAWINGS AND AS SHOWN ON LIGHTING IXTURE SCHEDULE CONTAINS SPECIFIC REQUIREMENTS FOR DRIVER TYPE, LENS TYPE, LAMP LIFE, CRI, ER SHALL BE ROHS COMPLIANT WITH INTEGRAL THERMAL PROTECTION THAT REDUCES OR ELIMINATES PUT POWER IF CASE TEMPERATURE EXCEEDS A VALUE DETRIMENTAL TO THE DRIVER. DRIVER SHALL ASS A SOUND RATING. ALL LIGHT FIXTURES AND LIGHTING EQUIPMENT WITH FACTORY APPLIED PAINTING SYSTEM THAT AT A MEETS REQUIREMENTS OF NEMA 250 CORROSION RESISTANCE TEST HTING CONNECTION OF EMERGENCY LIGHTING CIRCUITS TO ALL FIXTURES BEING REPLACED OR RETROFIT MPLETION OF INSTALLATION, PREFORM TEST OF EMERGENCY LIGHTING SYSTEM. ROLS IGHTING CONTROLS AS INDICATED ON THE DRAWINGS. CONFIRM OCCUPANCY SENSOR COVERAGE WITH TURER'S REPRESENTATIVE AND PROVIDE AS REQUIRED TO ACHIEVE PROPER COVERAGE. TEST ALL CONTROLS TO CONFIRM OPERATION UPON COMPLETION OF INSTALLATION. ING SYSTEM : PROVIDE MODIFICATIONS AND REPAIR TO THE EXISTING ETC (ELECTRONIC THEATER CONTROLS) SYSTEM AND NEW ETC STAGE LIGHTING PER THE DRAWINGS. THE MAJOR EQUIPMENT COMPONENTS OF PE OF WORK ARE IDENTIFIED ON A DIMMING SYSTEM SCHEDULE ON THE DRAWINGS. NO SUBSTITUTIONS D FOR THE ETC EQUIPMENT. EQUIPMENT SHALL BE COMPATIBLE WITH EXISTING ETC LIGHTING CONTROL SYSTEM POWER JRE AND COMPONENTS. AN ETC (ELECTRONIC THEATER CONTROLS) FACTORY-AUTHORIZED SERVICE REPRESENTATIVE FOR TION, STARTUP, CONTROL, AIMING AND FOCUSING OF THE STAGE LIGHTING SYSTEM. ATIONS CABLING SYSTEM A COMPLETE AND FUNCTIONAL CATEGORY 6 TELECOMMUNICATIONS CABLING SYSTEM INCLUDING ICATIONS CABLE, TELECOMMUNICATIONS JACKS, RACEWAYS, AND OTHER EQUIPMENT OR COMPONENTS RED TO ACHIEVE THE SPECIFIED FUNCTION.
- FELECOMMUNICATIONS CABLES SHALL BE UL LISTED, PLENUM-RATED CL2P, CATEGORY 6, 4 PAIR, 23-24 LID COPPER CONDUCTOR. SUPERIOR ESSEX "OSP CAT 6" OR EQUAL
- TELECOMMUNICATIONS JACKS SHALL BE CATEGORY 6, T568A/B, 8P8C, SINGLE, WHITE FINISH, IMUNICATIONS JACK WITH FLUSH EXIT. ALL JACKS SHALL BE WIRED USING THE T568B WIRING RATION. ORTRONICS "TRACJACK CLARITY 6" #OR-TJ600 OR EQUAL. ALL FACEPLATES SHALL BE SINGLE-ASTIC FACEPLATES WITH WHITE FINISH.

<u>PART</u> 3.1	3 GENE	EXECUTION RAL
	Α.	ALL MATERIALS SHALL BE NEW, FREE FROM CONTAINER.
	В.	INSTALL ALL ELECTRICAL EQUIPMENT USING APPROVED BY THE OWNER'S REPRESENTAT
3.2	FIRES A.	STOPPING APPLY FIRESTOPPING TO PENETRATIONS OF
3.3	EXIST	INSTALLATIONS TO RESTORE ORIGINAL FIRE
	A.	GENERAL: SPECIFIC SCOPE OF DEMOLITION VERIFIED BY ON-SITE REVIEW PRIOR TO SUB
		THE DOCUMENTS BASED UPON AVAILABLE "I AS THEY PRESENTLY EXIST. THE CONTRACT
		EQUIPMENT AND WIRING TO BE RETAINED OF DURING THE PROCESS OF REMOVAL AND RE
	В.	OWNER RETAINED EQUIPMENT: THE OWNER DEMOLITION. THE CONTRACTOR SHALL CAR
		AS MAY BE REQUIRED TO PROTECT THE EQU
		DESIGNATED ON THE JOBSITE. ANY EQUIPM THE PROPERTY OF THE CONTRACTOR AND E
3.4	DISPO A.	DSAL CONTRACTOR IS RESPONSIBLE FOR DISPOS
	Λ.	AND BALLASTS WHICH REQUIRE SPECIAL HA
	P	SHALL BE DISPOSED OF BY MUNICIPALITY OF
	В.	ALL LAMPS AND BALLASTS MUST BE DISPOSI WASTE DISPOSAL REGULATIONS. THESE INC
		LAMPS CONTAINING MERCURY AND THE US
	C.	BALLASTS CONTAINING PCBS. ALL LIGHTING BALLASTS THAT CONTAIN PCB
	0.	BY A HAZARD WASTE DISPOSAL COMPANY T
		APPROVED FACILITY. THE LIGHTING BALLAS FACILITY IN ACCORDANCE WITH ALL APPLICA
3.5	INSTA	ALLATION
	Α.	INSTALL LIGHTING FIXTURES IN ACCORDANC
		APPLICABLE REQUIREMENTS OF NEC, NECA RECOGNIZED INDUSTRY PRACTICES TO ENS
	В.	FIXTURES MOUNTED IN OPEN STRUCTURE S APPROVED BOLTING AND CLAMPING DEVICE
	C.	ALL LIGHTING FIXTURES SHALL BE RESTRAIN
		SECTION 13.6 OR SHALL COMPLY WITH ASCE CHAIN OR OTHERWISE SUSPENDED, PERMIT
		OF THE FIXTURE ACTING DOWNWARD AND A
		INTERFERE WITH ADJACENT OBJECTS WHEN
		SHALL ALLOW A 360 DEGREE RANGE OF MOT
3.6	CONS A.	TRUCTION OBSERVATION AND FINAL ACCEPT
		AS ACCEPTANCE BY THESE PARTIES AS REL
	B.	CODE ENFORCING AUTHORITIES. TESTING: THE CONTRACTOR SHALL TEST AL
	υ.	OF GROUNDS AND SHORT CIRCUITS. THE CO
		DEMONSTRATIONS AT TIMES MUTUALLY ACC TO OPERATE IN ACCORDANCE WITH THE REC
		RECOMMENDATIONS. OPERATE EVERY DEV
		PURPOSE. TESTS SHALL BE PERFORMED IN
	C.	ALL INSTRUMENTS AND PERSONNEL REQUIR OPERATIONAL TEST: ENGAGE AN ETC (ELEC
	•	REPRESENTATIVE TO SET AND OPERATE CO
		METHODICAL SEQUENCE THAT CUES AND RE 1. INCLUDE TESTING OF MODULAR DIMM
		UNDER CONDITIONS THAT SIMULATE
	P	OPERATIONS, CUES, AND FUNCTIONA
	D.	ENGAGE AN ETC (ELECTRONIC THEATER CO OWNER'S MAINTENANCE PERSONNEL TO AD
	-	MODULAR DIMMING SYSTEM AND THE NEW S
	E.	FIRE ALARM PANEL SHALL BE TESTED AND C TESTING REQUIREMENTS. PROVIDE TEST RE
	F.	THE SECURITY SYSTEM SHALL BE TESTED TO
	G.	REPORT TO OWNER. TELECOMMUNICATIONS CABLING SYSTEM TE
	H.	568C CATEGORY 6 STANDARDS AFTER INSTA SUBMIT COPIES OF FINAL INSPECTION CERT
		LAMPS, ETC.) TURNED OVER TO THE OWNER

SPACE RESERVED FOR MOA PERMIT STAMP

DEFECTS AND ARRIVE AT THE JOB SITE IN THEIR ORIGINAL UNOPENED

G MANUFACTURERS RECOMMENDED METHODS, UNLESS SPECIFICALLY TIVE.

OF FIRE-RATED CEILING AND WALL ASSEMBLIES FOR ELECTRICAL E-RESISTANCE RATING OF ASSEMBLY.

N WORK AND OPERATING CONDITIONS TO BE ENCOUNTERED SHALL BE IBMITTING BID. DEMOLITION WORK IN GENERAL IS NOTED OR SHOWN ON "DRAWINGS OF RECORD" AND MAY NOT SHOW THE ACTUAL CONDITIONS TOR SHALL BE RESPONSIBLE FOR THE PROTECTION OF EXISTING OR REINSTALLED AND SHALL REPLACE ANY EQUIPMENT DAMAGED EINSTALLATION.

R MAY WISH TO RETAIN CERTAIN SPECIFIC ITEMS SCHEDULED FOR REFULLY REMOVE THESE ITEMS, PROVIDE PROTECTION AND PACKAGING UIPMENT AND TURN OVER SAID EQUIPMENT TO THE OWNER AT A PLACE MENT THAT THE OWNER DOES NOT DESIRE TO RETAIN SHALL BECOME BE REMOVED FROM THE SITE.

SAL OF ALL MATERIAL REMOVED FROM THIS PROJECT, INCLUDING LAMPS ANDLING AND/OR DISPOSAL. ALL NON-HAZARDOUS/SANITARY WASTE OF ANCHORAGE SOLID WASTE SERVICES.

SED IN ACCORDANCE WITH ALL APPLICABLE FEDERAL, STATE, AND LOCAL ICLUDE THE U.S. EPA UNIVERSAL WASTE RULES FOR DISPOSAL OF TOXICS SUBSTANCES CONTROL ACT AND EPA RULES FOR DISPOSAL OF

B OR ARE NOT MARKED "NOT CONTAINING PCB", MUST BE DISPOSED OF THAT HAS A CONTRACT WITH A TOXIC SUBSTANCE CONTROL ACT (TSCA) STS MUST BE PACKAGED, LABELED AND SHIPPED TO A TSCA APPROVED CABLE EPA AND DOT REGULATIONS.

ICE WITH FIXTURE MANUFACTURER'S WRITTEN INSTRUCTIONS, N'S "STANDARDS OF INSTALLATION", NEMA STANDARDS, AND WITH SURE THAT LIGHTING FIXTURES FULFILL REQUIREMENTS.

SHALL BE SECURED DIRECTLY TO THE BUILDING STRUCTURE WITH

NED FROM LATERAL DISPLACEMENT IN ACCORDANCE WITH ASCE 7-10, E 7-10, SECTION 13.6.1 EXCEPTION WHICH FOR FIXTURES SUPPORTED BY 'S DESIGN OF LIGHT FIXTURE CONNECTIONS TO 1.4 TIMES THE WEIGHT ANY HORIZONTAL DIRECTION. SUSPENDED LIGHT FIXTURES SHALL NOT N SWINGING 45 DEGREES FROM VERTICAL. SUSPENDED LIGHT FIXTURES DTION IN THE HORIZONTAL PLANE.

TANCE

EWS OF CONSTRUCTION BY THE ENGINEER SHALL NOT BE CONSTRUED LATED TO QUANTITIES, ROUGH-IN LOCATIONS, AND COMPLIANCE WITH

ALL WIRING AND ALL ELECTRICAL EQUIPMENT TO VERIFY THE ABSENCE ONTRACTOR WILL BE RESPONSIBLE FOR SCHEDULING OF TESTS AND CEPTABLE TO THE OWNER. ALL EQUIPMENT SHALL BE DEMONSTRATED EQUIREMENTS OF THIS SPECIFICATION AND THE MANUFACTURER'S /ICE MANUALLY AND AUTOMATICALLY IN ACCORDANCE WITH ITS I THE PRESENCE OF THE OWNER OR DESIGNATED REPRESENTATIVE.

RED TO CONDUCT THE TEST SHALL BE PROVIDED BY THE CONTRACTOR. CTRONIC THEATER CONTROLS) FACTORY-AUTHORIZED SERVICE ONTROLS TO DEMONSTRATE THEIR FUNCTIONS AND CAPABILITIES IN A REPRODUCES ACTUAL OPERATING FUNCTIONS.

IMING CONTROL EQUIPMENT AND NEW STAGE LIGHTING EQUIPMENT ACTUAL OPERATIONAL CONDITIONS. RECORD CONTROL SETTINGS, AL OBSERVATIONS.

ONTROLS) FACTORY-AUTHORIZED SERVICE REPRESENTATIVE TO TRAIN DJUST, OPERATE, AND MAINTAIN MODULAR DIMMING CONTROLS FOR THE STAGE LIGHTING. MINIMUM 4 HOURS TRAINING TIME CERTIFIED PER NFPA 72 AND STATE OF ALASKA/MOA REACCEPTANCE REPORT TO AHJ AS REQUIRED.

TO CONFIRM OPERATION OF DEVICES RELOCATED. PROVIDE TEST

TEST: EACH UTP CABLE SHALL BE TESTED FOR COMPLIANCE WITH TIA/EIA FALLATION USING A FLUKE #DTX OR APPROVED EQUAL TIFICATES AND RECEIPTS FOR LOOSE MATERIALS (SPARE DEVICES,

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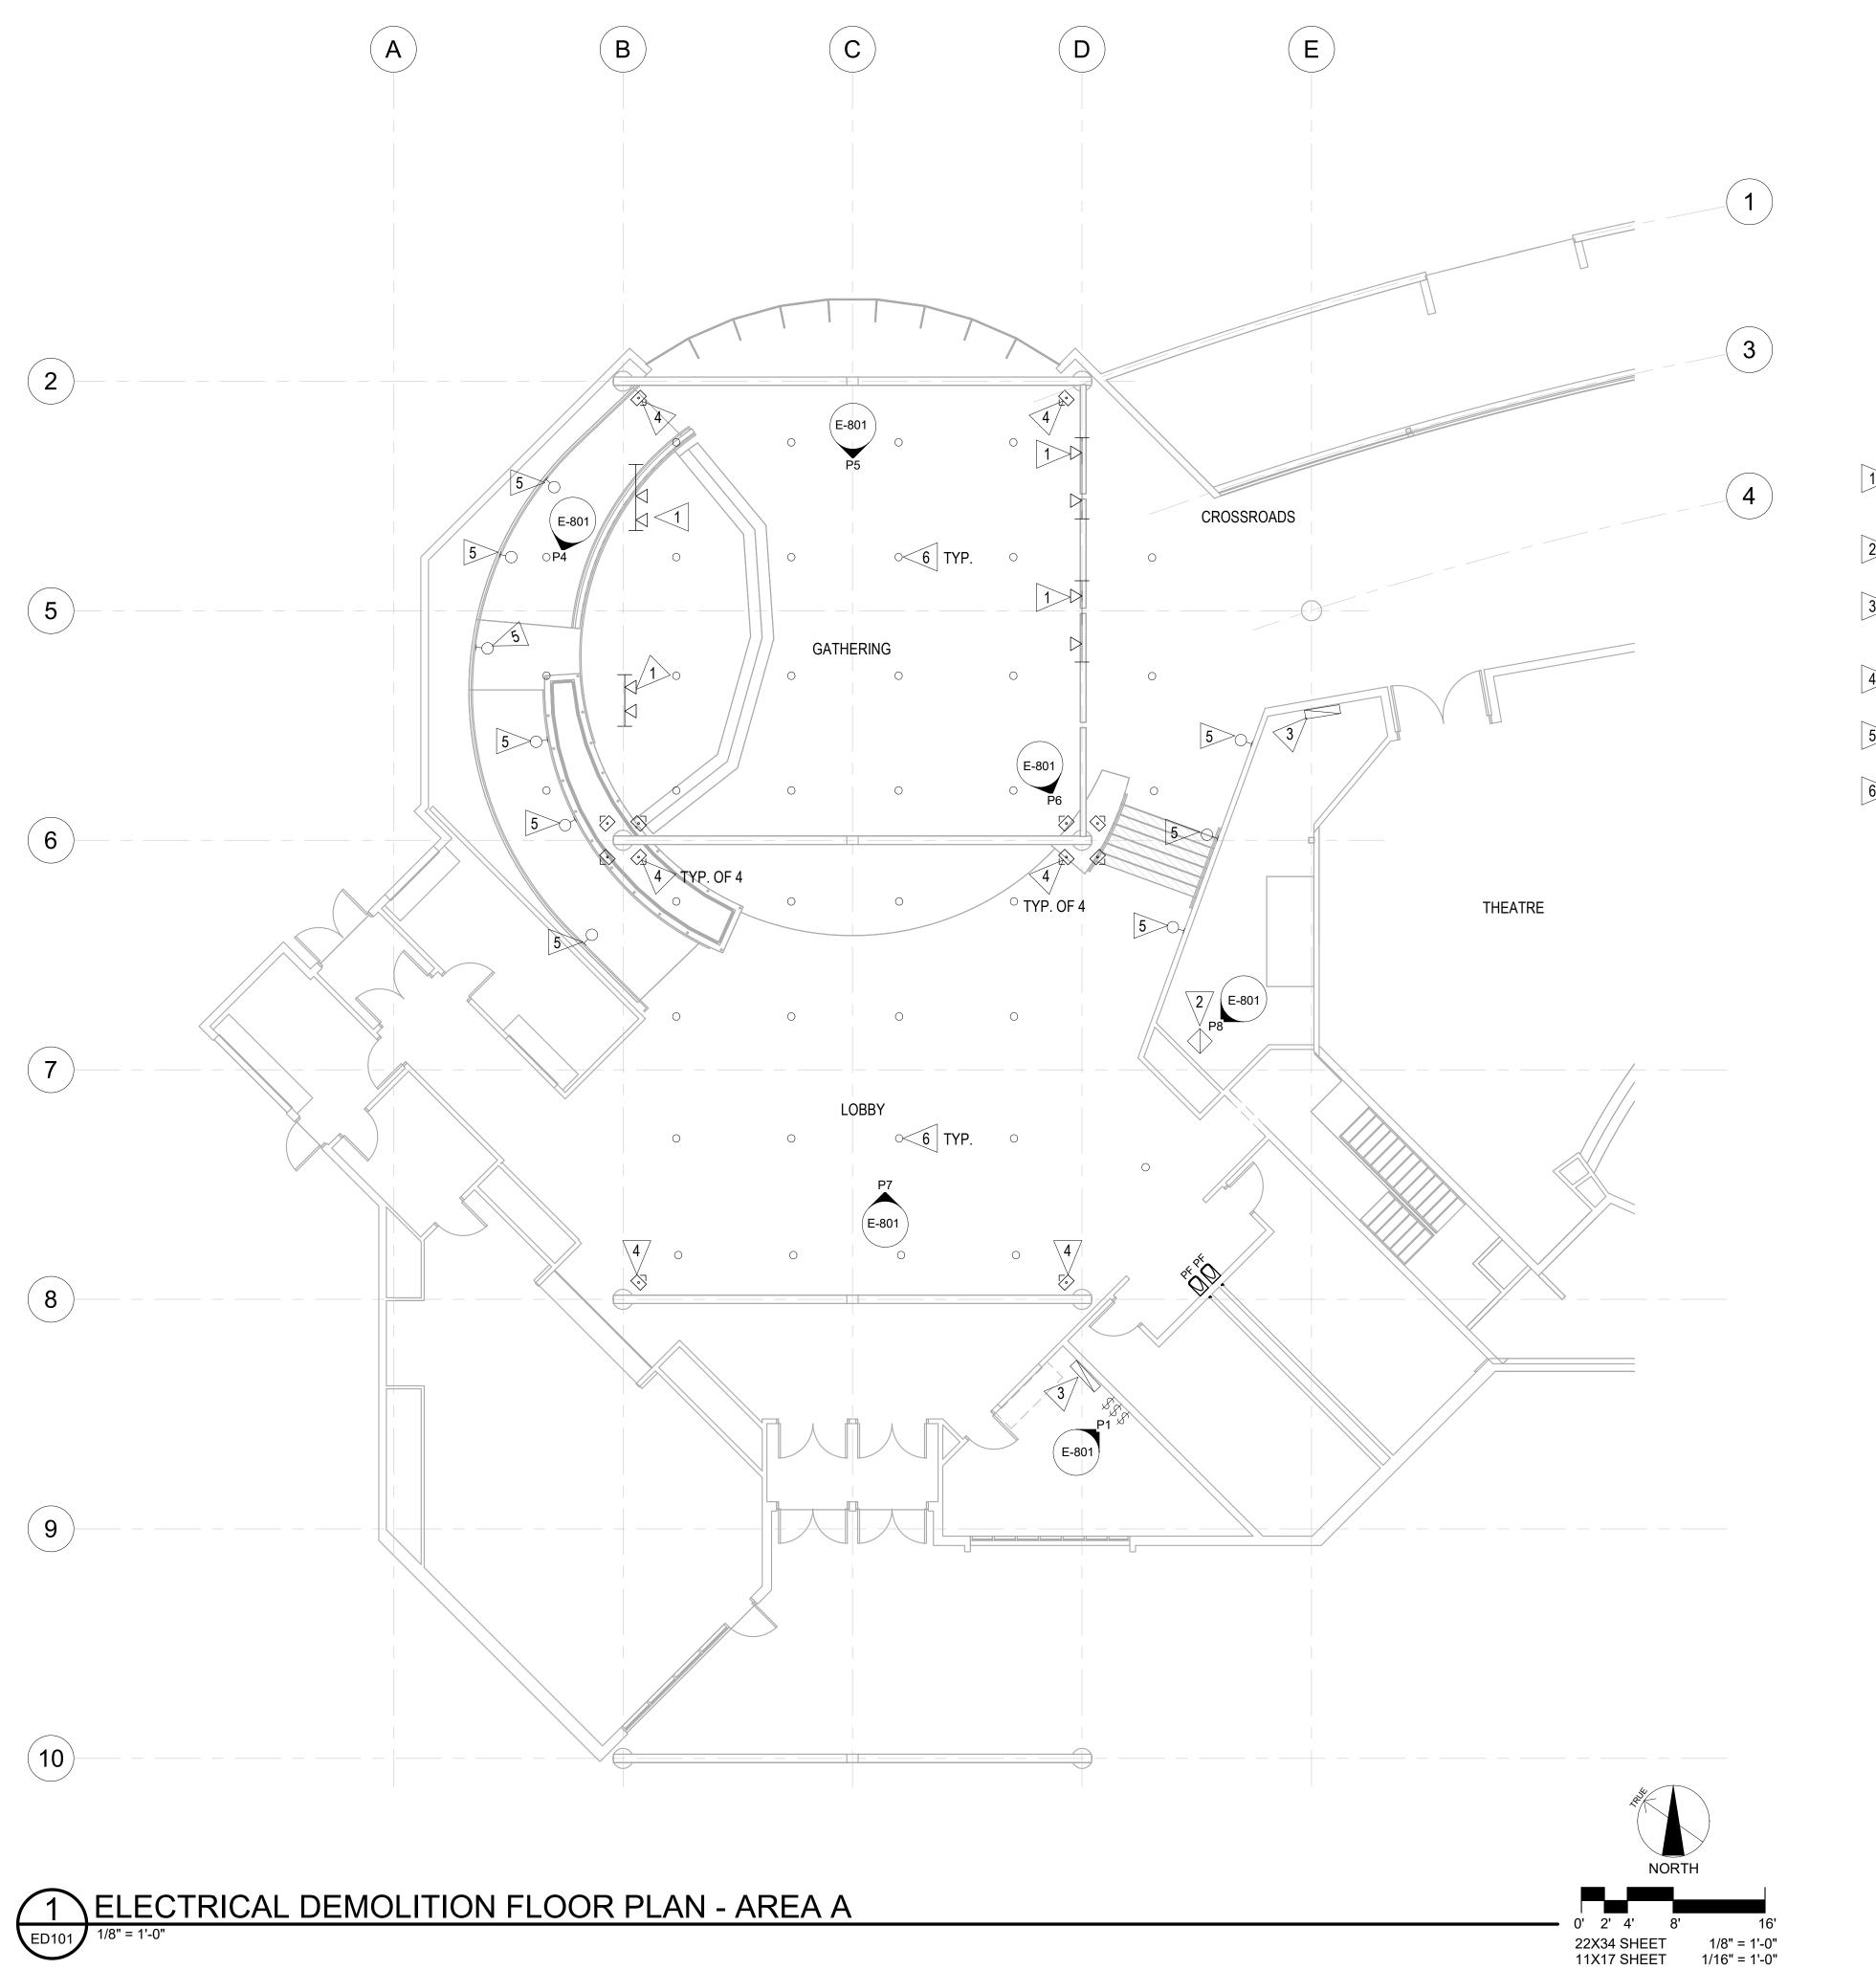
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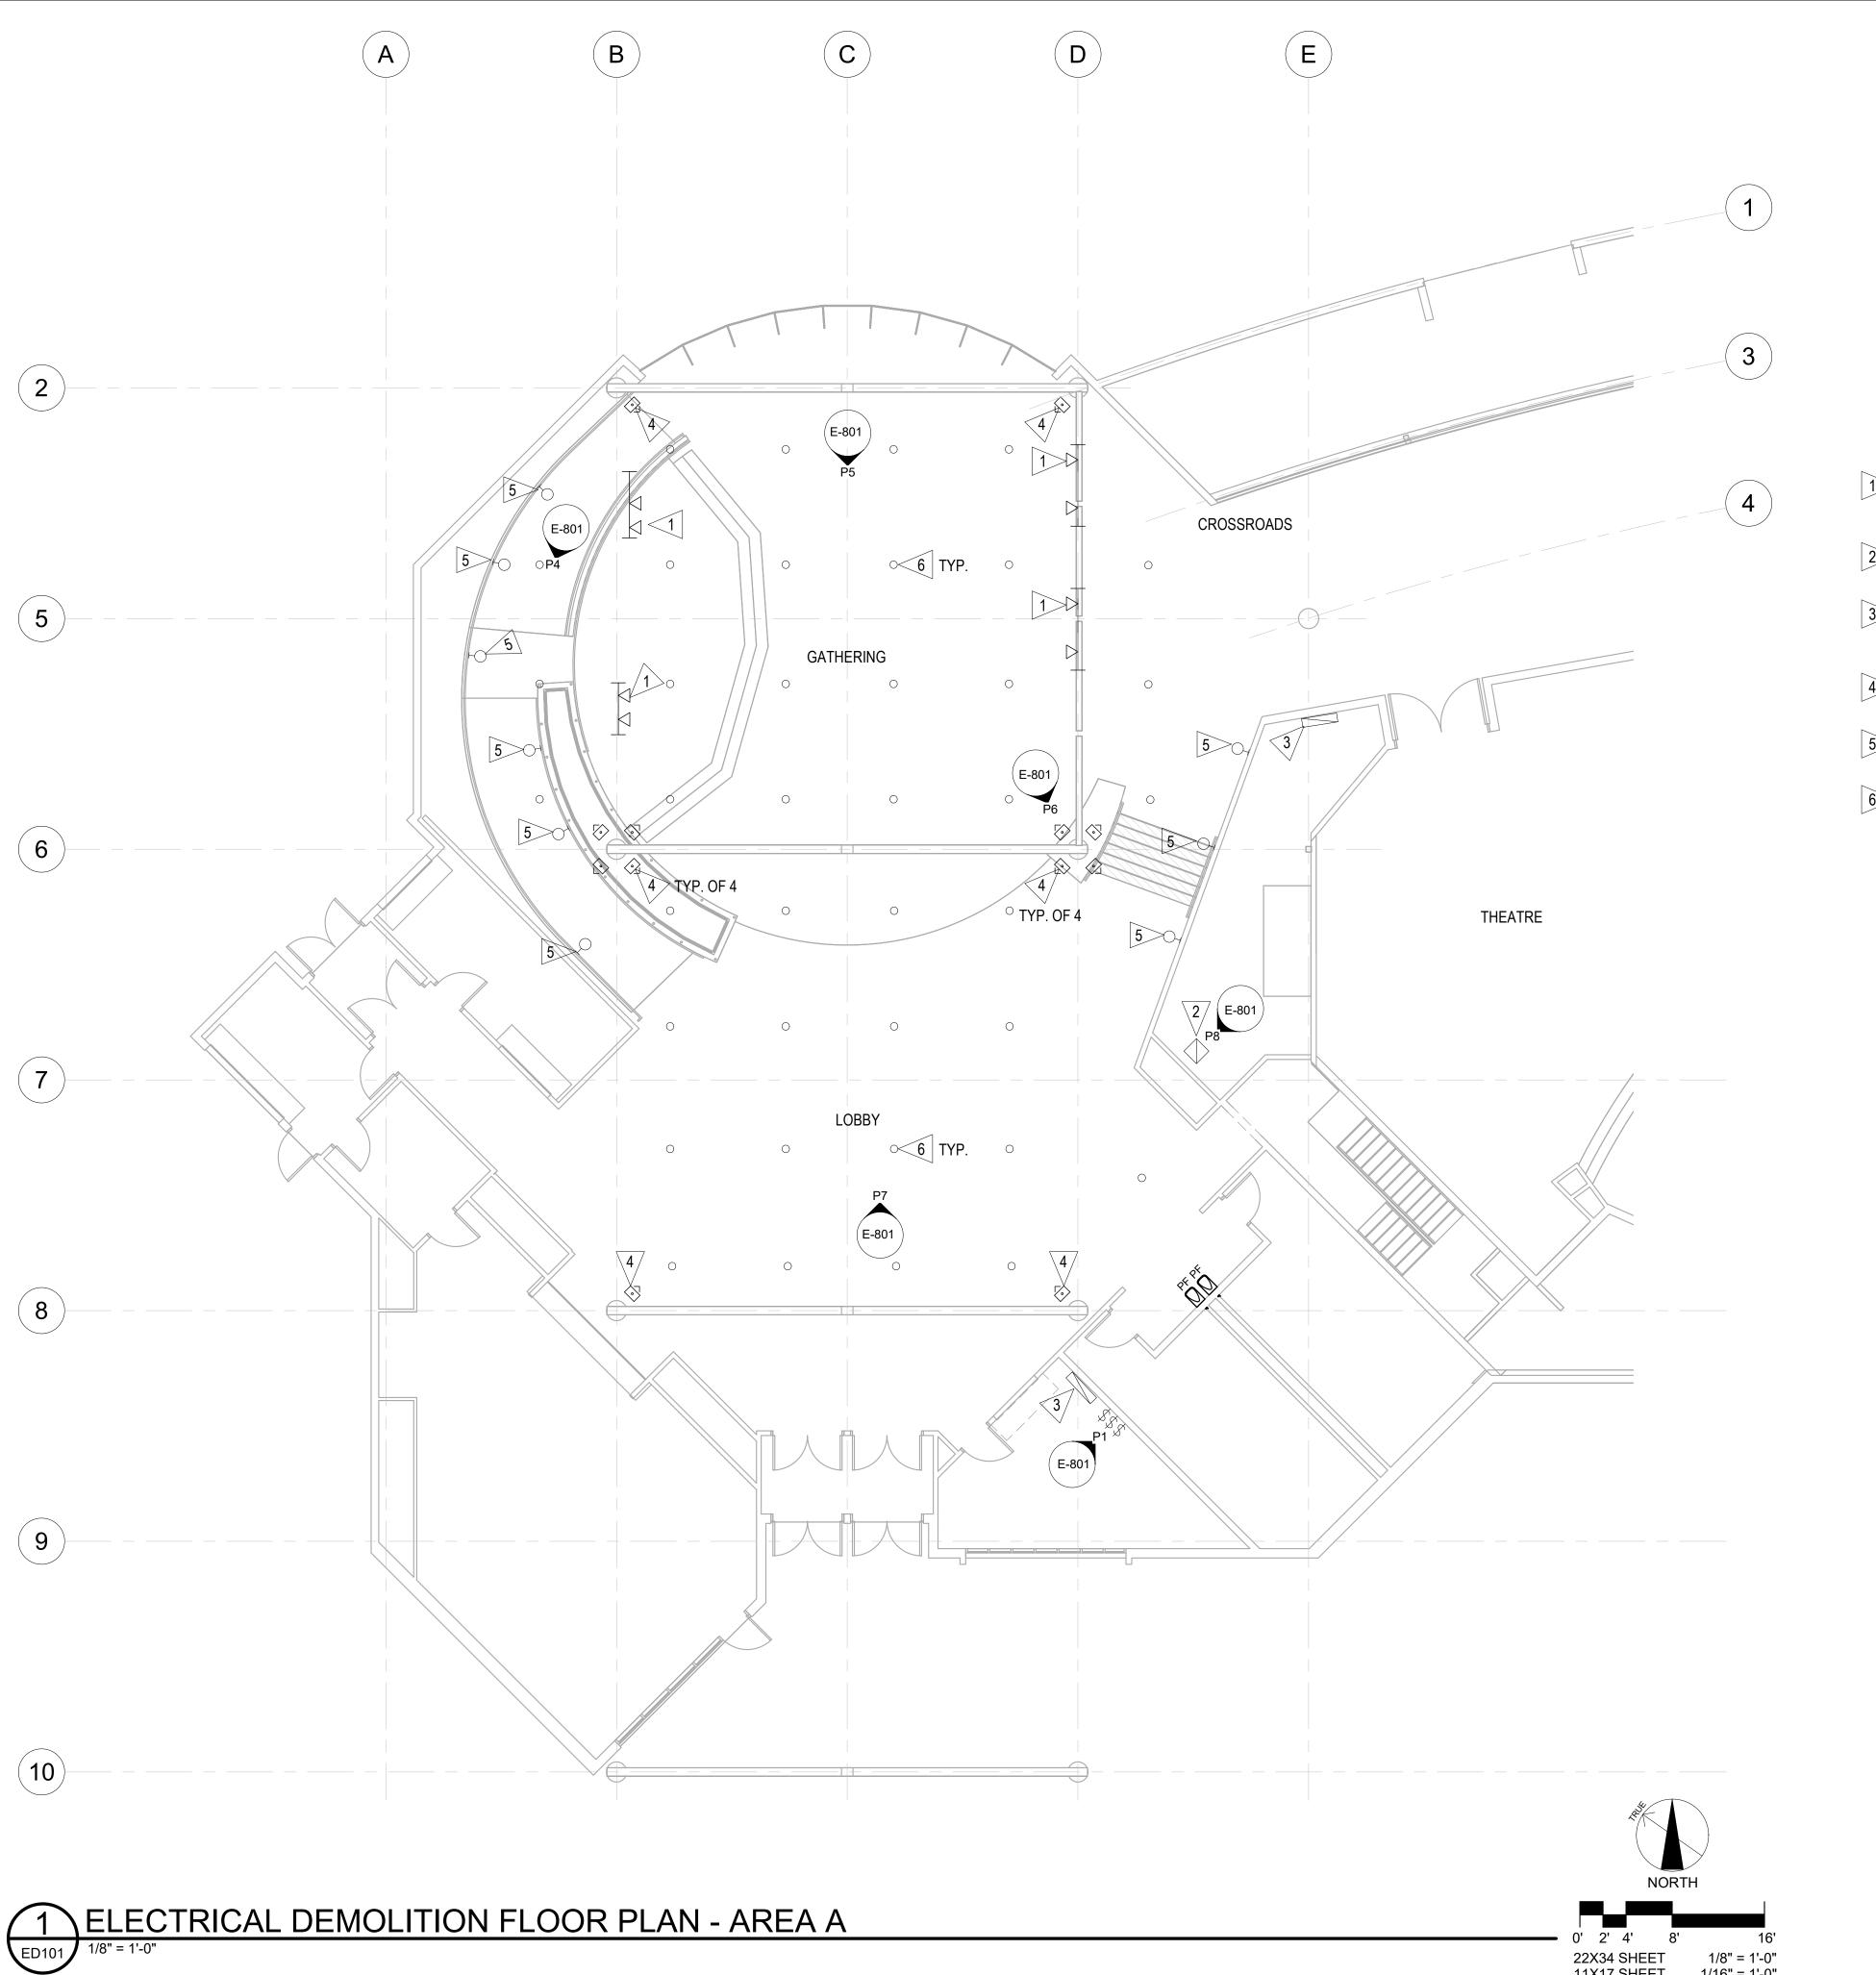
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#### ELECTRICAL SPECIFICATIONS

SHEET NO.

E-002





SPACE RESERVED FOR MOA PERMIT STAMP

## **GENERAL NOTES**

REFER TO LIGHTING PLAN FOR (E) EXISTING TO REMAIN LIGHTS IN AREA 1. OF WORK.

## SHEET NOTES

> REMOVE BEAM MOUNTED TRACK AND ASSOCIATED TRACK MOUNTED LIGHTS. TURN OVER TRACK LIGHTS TO OWNER. REFER TO SHEET E-101 FOR INFORMATION ON RE-USE OF THE LIGHTING CIRCUIT.

2 REMOVE EXISTING ETC UNISON LIGHTING CONTROL PANEL. REFER TO LIGHTING PLAN AND DIMMING SYSTEM RISER DIAGRAM FOR ADDITIONAL INFORMATION.

3 REMOVE THE WALL MOUNTED DIMMING SYSTEM TOUCH SCREEN SCENE CONTROL STATION. COIL EXISTING WIRE IN J-BOX FOR FUTURE RE-USE. PROVIDE BLANK STAINLESS STEEL COVER PLATE OVER JUNCTION BOX.

4 REMOVE PENDANT MOUNTED LIGHTS AROUND COLUMNS. REFER TO LIGHTING PLAN FOR ADDITIONAL INFORMATION.

5 REMOVE RECESS WALL MOUNTED LIGHTS AT 18" ABOVE FINISH FLOOR. REFER TO LIGHTING PLAN FOR ADDITIONAL INFORMATION.

6 PROVIDE PARTIAL DEMOLITION OF HIGH CEILING RECESS CAN LIGHTS. THE LIGHTS SHALL BE RETROFIT WITH LED KIT. REFER TO LIGHTING PLAN FOR ADDITIONAL INFORMATION.



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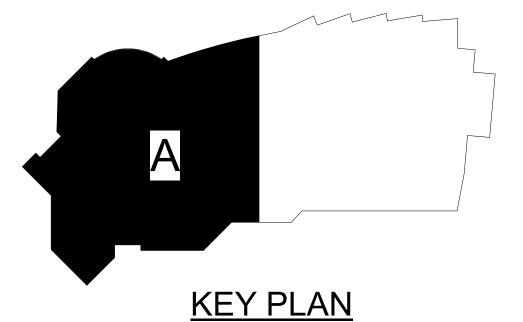
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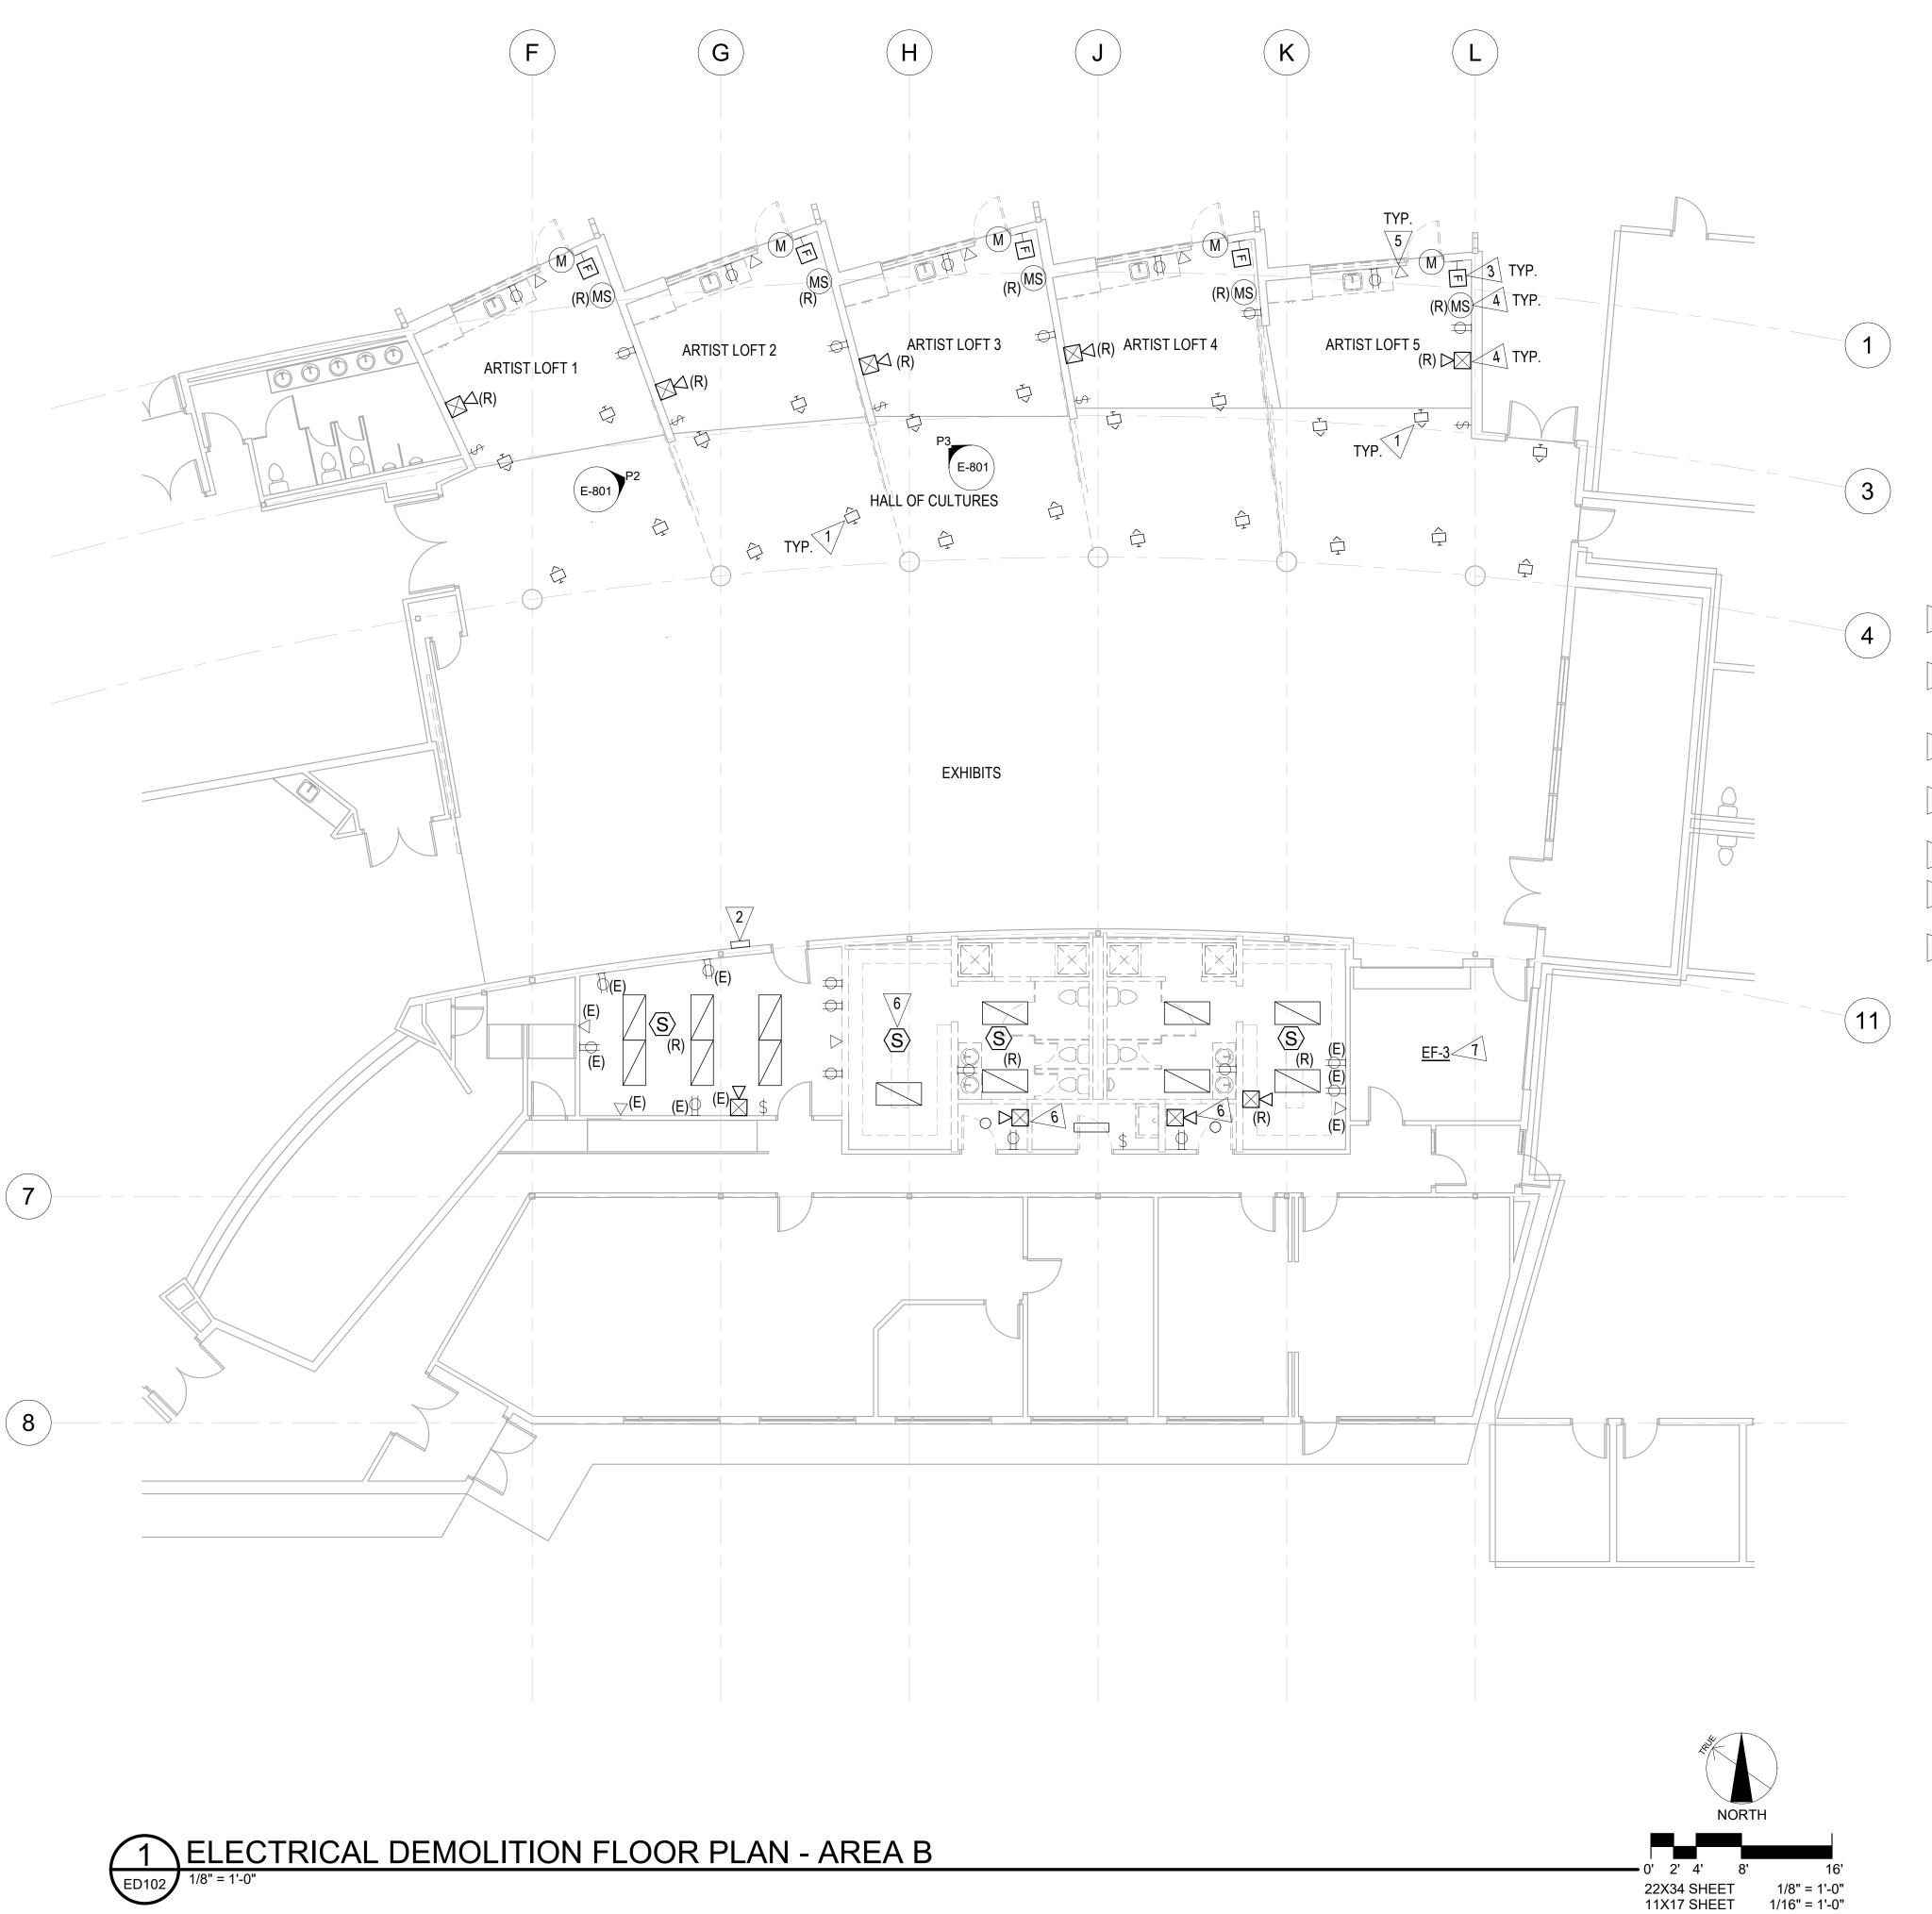
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ELECTRICAL DEMOLITION FLOOR PLAN -AREA A







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SPACE RESERVED FOR MOA PERMIT STAMP

#### **GENERAL NOTES**

- DEVICES INDICATED WITH AN "(R)" ARE TO BE RELOCATED. REFER TO NEW PLANS FOR NEW LOCATIONS.
- DEVICES INDICATED WITH AN "(E)" ARE EXISTING TO REMAIN AND SHOWN FOR REFERENCE PURPOSES. CONTRACTOR TO MAINTAIN CIRCUITRY OF EXISTING DEVICES TO REMAIN BY EXTENDING WIRING AS REQUIRED FOR DEVICES REMOVED.
- PROVIDE COMPLETE DEMOLITION OF ITEMS SHOWN, PORTION OF CONCEALED CONDUIT AND WIRING MAY BE REUSED IF IT MEETS ALL PROJECT AND NEC CODE REQUIREMENTS.

## SHEET NOTES

- 1 REMOVE WALL MOUNTED UPLIGHTS. MAINTAIN EXISTING OUTLET AND WIRING FOR REPLACEMENT FIXTURE. SEE LIGHTING PLANS FOR REPLACEMENT FIXTURE.
- 2>REMOVE THE WALL MOUNTED DIMMING SYSTEM TOUCH SCREEN SCENE CONTROL STATION. COIL EXISTING WIRE IN J-BOX FOR FUTURE RE-USE. PROVIDE BLANK STAINLESS STEEL COVER PLATE OVER JUNCTION BOX.
- 3 REMOVE FIRE ALARM PULL STATION INCLUDING CONDUIT AND WIRE. RETAIN DEVICES AND TURN OVER TO OWNER.
- 4 RELOCATE FIRE ALARM HORN STROBE AND SECURITY SYSTEM MOTION SENSOR AS REQUIRED FOR NEW WALL SURFACE.
- 5 REMOVE TELECOM OUTLET AND WIRING BACK TO THE TELECOM RACK.
- 6 REMOVE FIRE ALARM SMOKE DETECTOR AND HORN STROBES. RETAIN DEVICES THAT ARE NOT TO BE RELOCATED AND TURN OVER TO OWNER.
- 7>REMOVE EXHAUST FAN EF-3 AND ASSOCIATED WIRING. LABEL CIRCUIT M:9 AS A SPARE.



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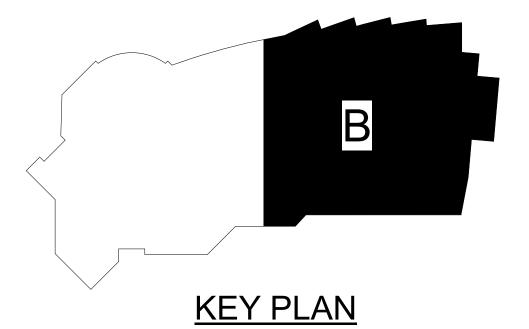
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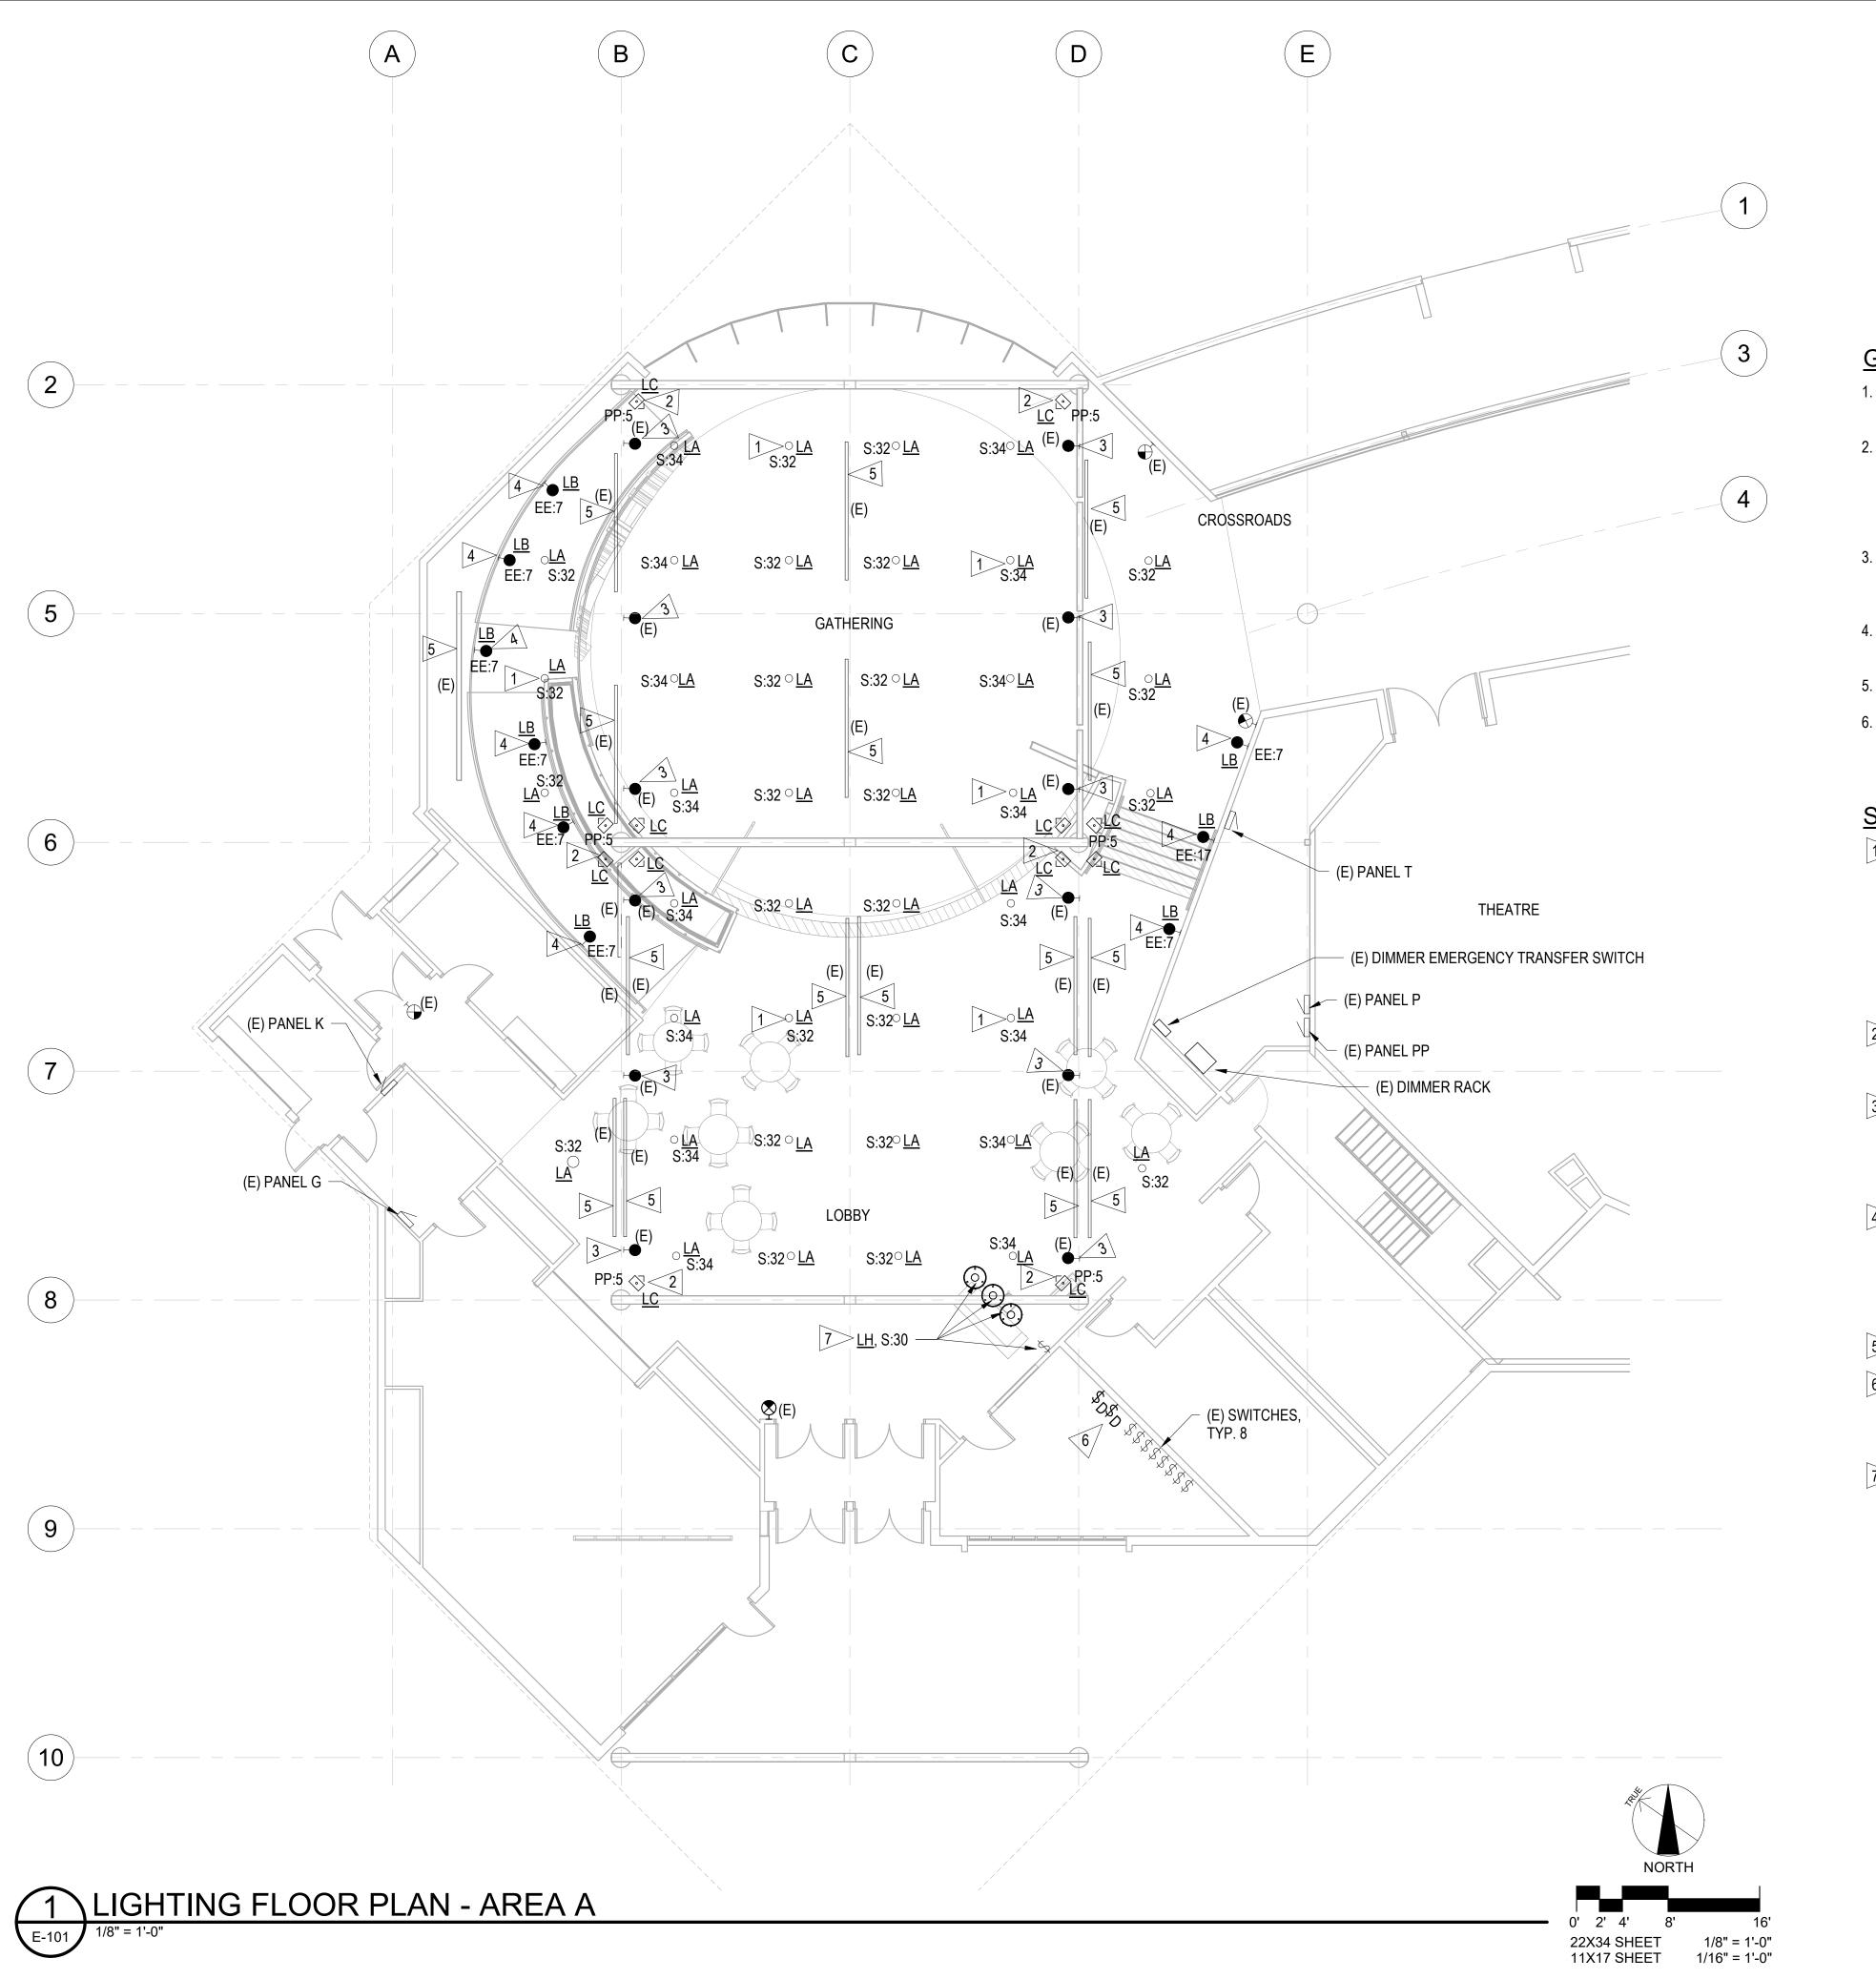
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ELECTRICAL DEMOLITION FLOOR PLAN -AREA B





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SPACE RESERVED FOR MOA PERMIT STAMP

#### **GENERAL NOTES**

MAINTAIN CONNECTIVITY OF ALL EXISTING EXIT SIGNS AND EMERGENCY LIGHTS TO REMAIN.

VERIFY CEILING TYPES AND FIXTURE MOUNTING REQUIREMENTS PRIOR TO ORDERING LIGHT FIXTURES. PROVIDE COMPATIBLE MOUNTING ACCESSORIES AND ALL TRIM FLANGES, SUPPORTS, OUTLET BOXES, FOR A COMPLETE AND FINISHED INSTALLATION. REFER TO EXISTING CONDITIONS PHOTOS SHEET E-801 FOR REFERENCE.

NEW AND EXISTING LIGHTING IS SHOWN ON THESE PLANS IN AREA OF REMODEL ONLY. ALL OTHER EXISTING LIGHTING TO REMAIN (NOT SHOWN). RECORD DRAWINGS ARE AVAILABLE INDICATING THE EXISTING CONDITIONS.


CIRCUITING FOR REPLACEMENT AND RETROFIT FIXTURES IS INDICATED BASED ON RECORD DRAWINGS AND SHALL BE FIELD VERIFIED BY THE CONTRACTOR.

REFER TO LIGHT FIXTURE SCHEDULE FOR ADDITIONAL FIXTURE INFORMATION.

REFER TO SHEETS E-103 AND E-501 FOR ADDITIONAL PROJECT SCOPE REGARDING DIMMING SYSTEM REPAIRS AND ALTERNATE BID ITEM #6 FOR NEW STAGE LIGHTING.

#### SHEET NOTES

- 1 RETROFIT FIXTURE TYPE LA WITH LED RETROFIT MODULE. REMOVE INTERIOR COMPONENTS OF THE RECESSED CAN LIGHT FIXTURE AND RETROFIT WITH LED LIGHT ENGINE MODULE. REUSE EXISTING SLOPED CEILING TRIM. INTERCEPT EXISTING 277V HOMERUNS AND EXTEND CONDUIT AND WIRING TO 120V PANELS AS INDICATED BY CIRCUIT NUMBERS ON PLAN (REWIRE FROM PP:3 TO S:32 AND SS:2 TO S:34). COLOR TAPE THE EXISTING CONDUCTORS WITH 120V COLORS AT EACH JUNCTION BOX AND LABEL AS "120V". PROVIDE NEW DIMMERS FOR CONTROL. REFER TO SHEET NOTE 6 FOR MORE INFORMATION ON DIMMER SWITCHES.
- 2 REPLACE PENDANT MOUNTED LIGHT FIXTURES WITH TYPE LC FIXTURE. REMOVE EXISTING REMOTE BALLAST AND CONNECT TO EXISTING CIRCUIT. MAINTAIN CONTROL FROM EXISTING SWITCH LOCATED IN ROOM 164.
- 3 MAINTAIN CONNECTIVITY OF THE EXISTING BRACKET MOUNTED LIGHTS, MOUNTED TO THE BEAMS. THESE EXISTING LIGHTS ARE WIRED TO THE EMERGENCY PANEL "E" VIA A UL 1008 TRANSFER SWITCH SUCH THAT THE FIXTURES ONLY OPERATE ON LOSS OF NORMAL POWER AND SERVE AS THE EMERGENCY EGRESS LIGHTING.
- 4 REPLACE RECESS WALL MOUNTED LIGHTS MOUNTED AT 18" AFF WITH TYPE LB FIXTURE AND CONNECT TO EXISTING CIRCUIT AND MAINTAIN EXISTING CONTROLS. INSTALLATION MAY REQUIRE PATCH AND REPAIR OF SHEETROCK WALL SURFACE. THESE LIGHTS ARE WIRED TO THE EMERGENCY PANEL "EE" VIA A UL 1008 TRANSFER SWITCH SUCH THAT THE FIXTURES OPERATE ON LOSS OF NORMAL POWER AND SERVE AS THE EMERGENCY EGRESS LIGHTING.
- 5> MAINTAIN CONNECTIVITY OF EXISTING TRACK LIGHTING TO REMAIN.
- 6 REPLACE THE SINGLE POLE LIGHT SWITCHES CONTROLLING TYPE LA CAN LIGHTS WITH TWO-WIRE, 120V DIMMER SWITCHES COMPATIBLE WITH NEW TYPE LA RETROFIT LED FIXTURES. REFER TO SHEET NOTE 1 FOR WIRING REQUIREMENTS. REFER TO PHOTO P1/E-801.
- 7 PROVIDE THREE TYPE <u>LH</u> LAMPSHADE STYLE LED FIXTURES SUSPENDED AT 10' AFF. OVER RECEPTION DESK. PROVIDE SINGLE POLE LIGHT SWITCH FOR CONTROL.

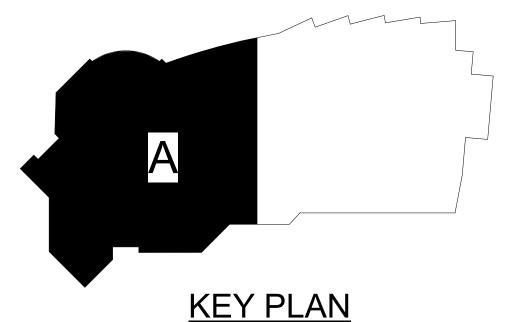



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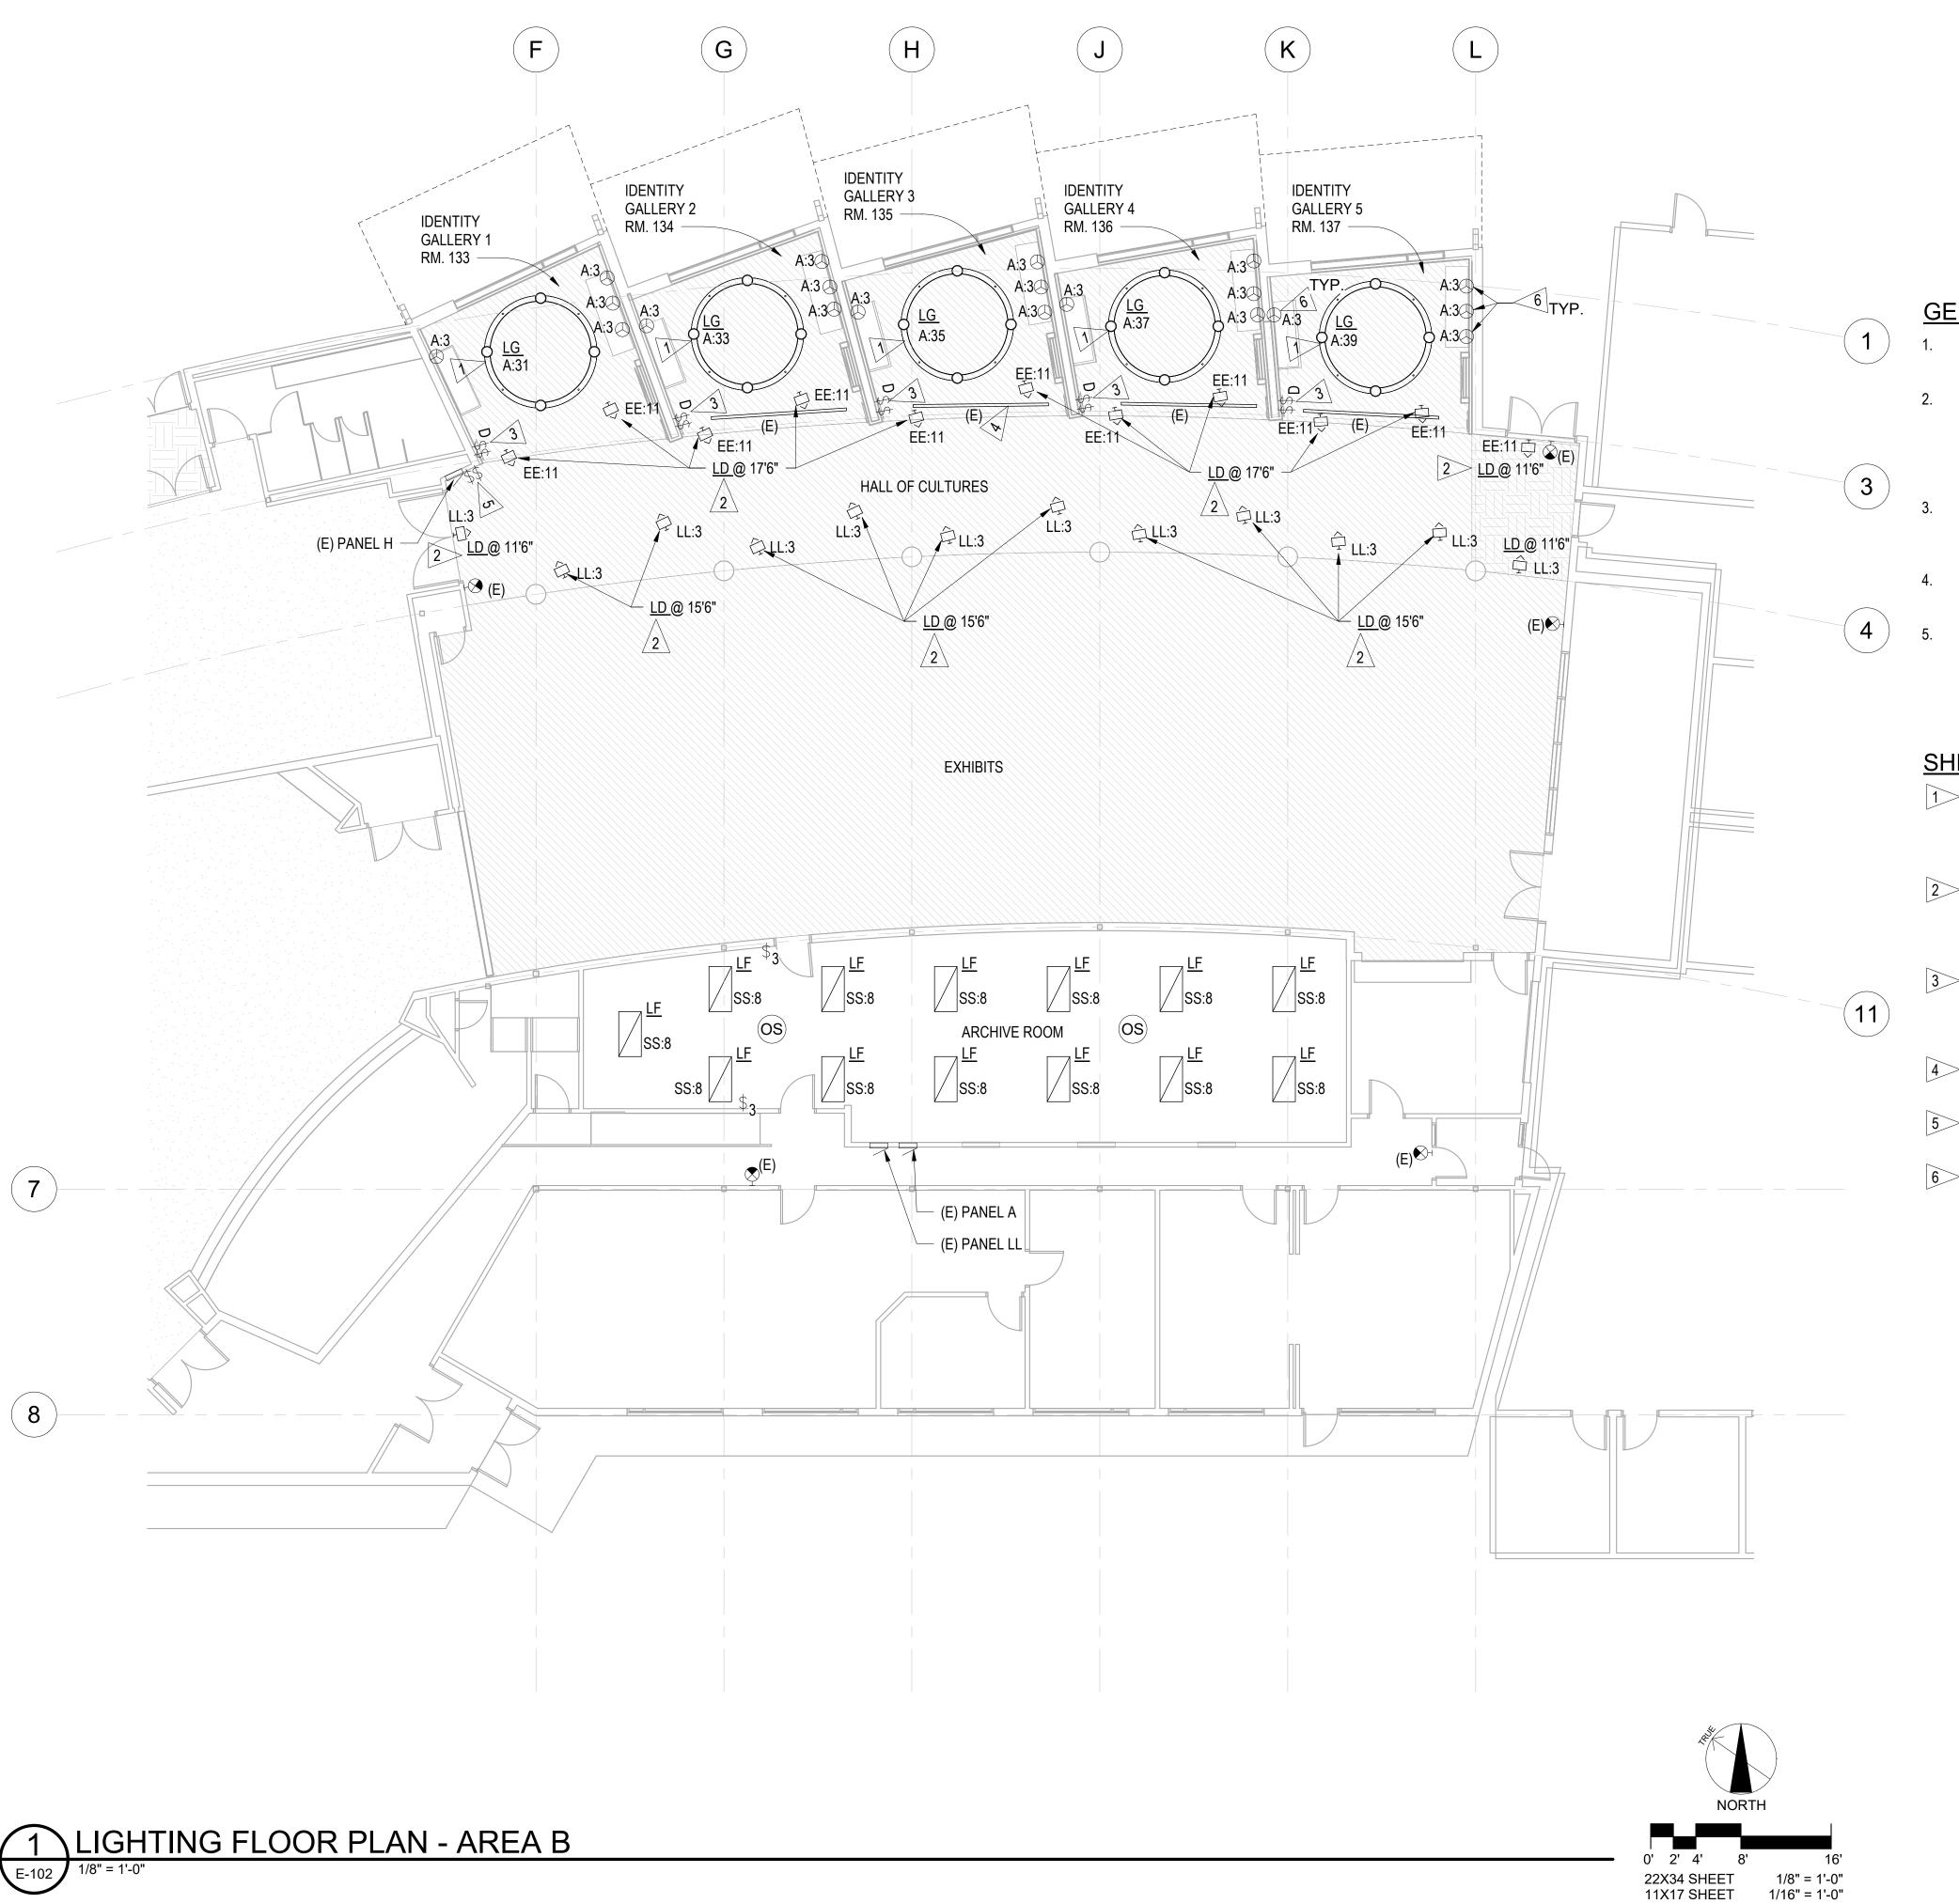
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LIGHTING FLOOR PLAN -AREA A

SHEET NO.

E-101





SPACE RESERVED FOR MOA PERMIT STAMP

#### **GENERAL NOTES**

MAINTAIN CONNECTIVITY OF ALL EXISTING EXIT SIGNS AND EMERGENCY LIGHTS TO REMAIN.

VERIFY CEILING TYPES AND FIXTURE MOUNTING REQUIREMENTS PRIOR TO ORDERING LIGHT FIXTURES. PROVIDE COMPATIBLE MOUNTING ACCESSORIES AND ALL TRIM FLANGES, SUPPORTS, OUTLET BOXES, ETC. FOR A COMPLETE AND FINISHED INSTALLATION. REFER TO EXISTING CONDITIONS PHOTOS SHEET E-801 FOR REFERENCE.

NEW AND EXISTING LIGHTING IS SHOWN ON THESE PLANS IN AREA OF REMODEL ONLY. ALL OTHER EXISTING LIGHTING TO REMAIN (NOT SHOWN). RECORD DRAWINGS ARE AVAIALBLE INDICATING THE EXISTING CONDITIONS.

CIRCUITING FOR REPLACEMENT AND RETROFIT FIXTURES IS INDICATED BASED ON RECORD DRAWINGS AND SHALL BE FIELD VERIFIED BY THE CONTRACTOR.

REFER TO LIGHT FIXTURE SCHEDULE FOR ADDITIONAL FIXTURE INFORMATION.

## SHEET NOTES

- SUSPEND NEW TYPE LG FIXTURE AT 10'-10" ABOVE FINISH FLOOR USING STAINLESS STEEL CABLES FROM FOUR MOUNTING POINTS ON SLOPED CEILING. PROVIDE ALL MOUNTING HARDWARE AS REQUIRED. EACH FIXTURE IS A UNIQUE COLOR TO BE COORDINATED WITH THE ARCHIECT.
- REPLACE EXISTING WALL MOUNTED LIGHTS WITH TYPE LD WALL MOUNTED LED UPLIGHT. MAINTAIN EXISTING CONTROL AND CONNECT TO EXISTING CIRCUIT. LIGHTS ON NORTH SIDE ARE WIRED TO EMERGENCY PANEL EE. MAINTAIN CONNECTION TO EXISTING EMERGENCY TRANSFER DEVICE.
- PROVIDE DIMMER SWITCH FOR CONTROL OF NEW SUSPENDED TYPE LG FIXTURE. PROVIDE WIRING AS REQUIRED. PROVIDE SINGLE POLE SWITCH FOR CONTROL OF LIGHTING WITHIN ALL DISPLAY CASES. COORDINATE WITH SIGNAGE LOCATION PRIOR TO INSTALL.
- EXISTING CEILING MOUNTED TRACK LIGHTING TO REMAIN. TYPICAL OF FOUR LOCATIONS
- 5> EXISTING LIGHT SWITCHES FOR CONTROL OF TYPE LD LIGHT FIXTURES TO REMAIN.
- 6> PROVIDE POWER CONNECTION FOR THE INTEGATED LED LIGHTING WITHIN EACH OF THE WALL MOUNTED DISPLAY CASES WITHIN EACH IDENITY GALLERY. PROVIDE A SINGLE LIGHT POLE SWITCH FOR CONTROL, REFER TO FLAG NOTE 3.

LIGHTING FLOOR PLAN -AREA B





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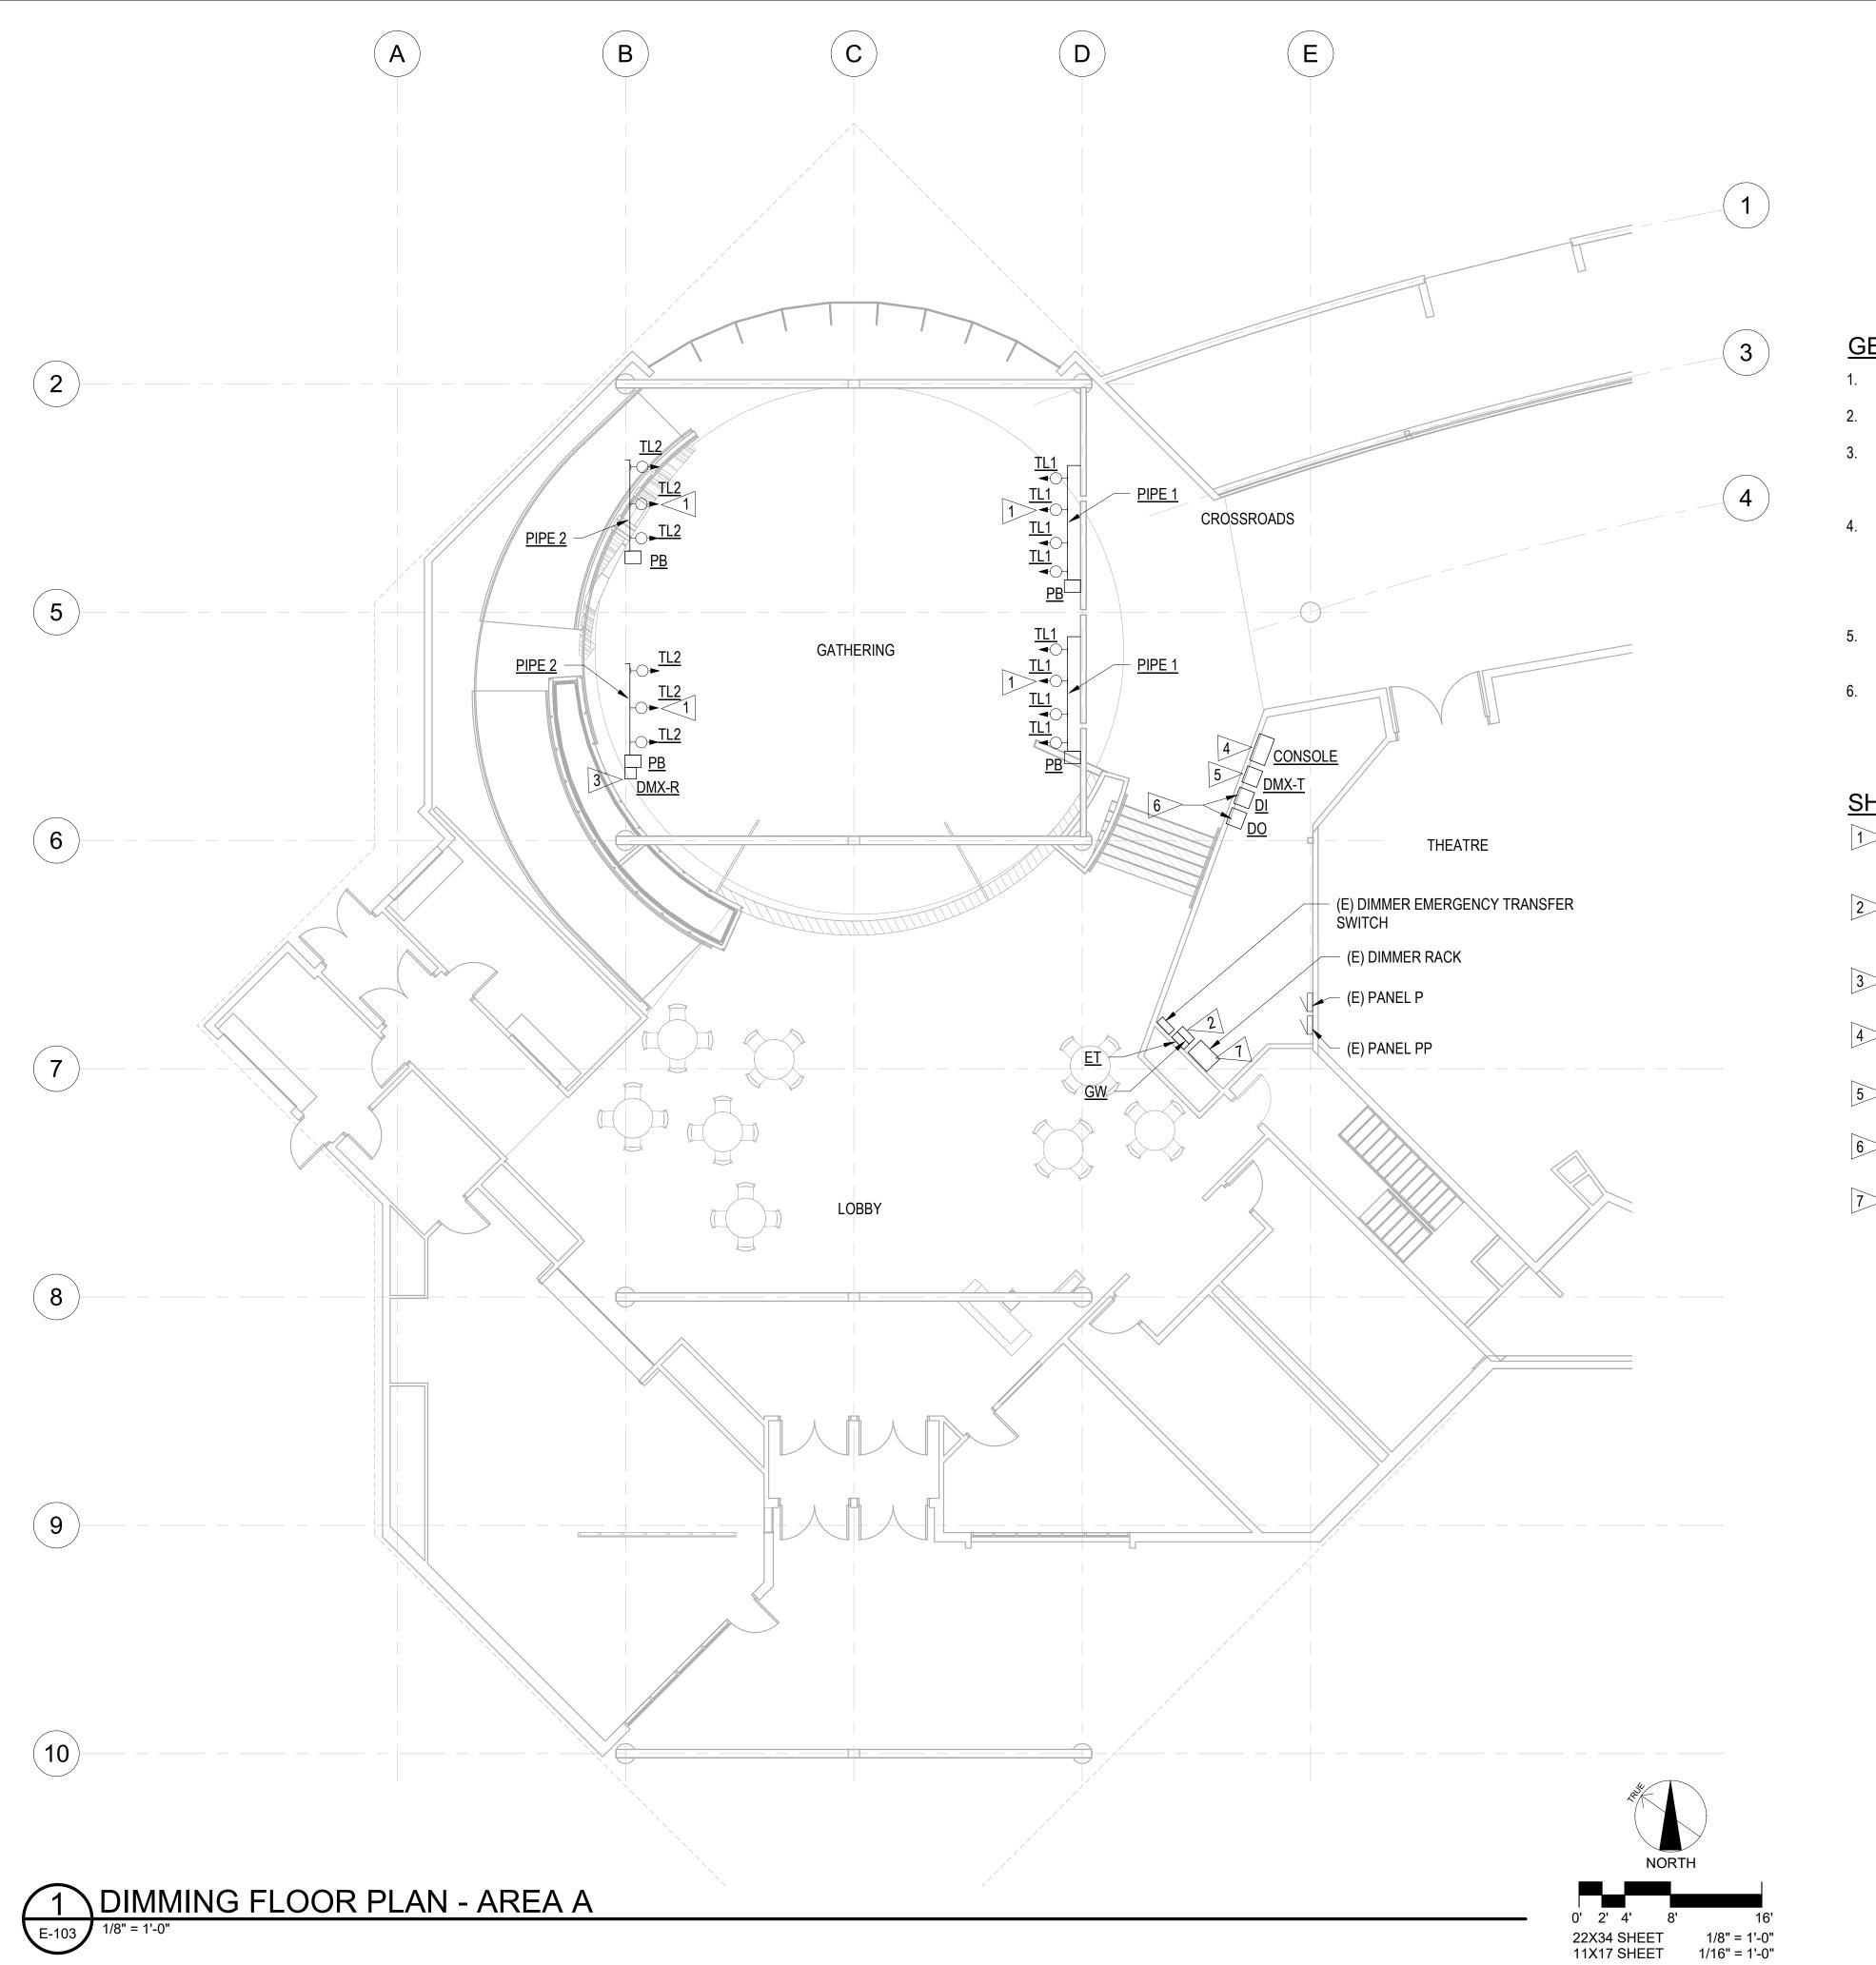
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SPACE RESERVED FOR MOA PERMIT STAMP

#### **GENERAL NOTES**

ALL WORK ASSOCIATED WITH THE ETC DIMMING SYSTEM REPAIR IS BASE BID.

ALL WORK ASSOCIATED WITH STAGE LIGHTING IS AN ADD ALTERNATE BID ITEM #6.

INSTALLATION OF THE STAGE LIGHTING SYSTEM SHALL BE BY A QUALIFIED THEATRICAL STAGE LIGHTING TECHICIAN. REFER TO SPECIFICATIONS FOR MORE INFORMATION.

VERIFY CEILING TYPES AND FIXTURE MOUNTING REQUIREMENTS PRIOR TO ORDERING LIGHT FIXTURES. PROVIDE COMPATIBLE MOUNTING ACCESSORIES AND ALL TRIM FLANGES, SUPPORTS, OUTLET BOXES, FOR A COMPLETE AND FINISHED INSTALLATION. REFER TO EXISTING CONDITIONS PHOTOS SHEET E-801 FOR REFERENCE.

CIRCUITING IS INDICATED BASED ON RECORD DRAWINGS AND SHALL BE FIELD VERIFIED BY THE CONTRACTOR.

REFER TO SHEET E-501 FOR THE STAGE LIGHTING SCHEDULE, ETC DIMMING SYSTEM REPAIR SCHEDULE AND ETC DIMMING CONTROLS DIAGRAM.

#### SHEET NOTES

- 1 REMOVE BEAM MOUNTED TRACK AT THIS LOCATION AND PROVIDE NEW PIPE RAIL MOUNTED LED STAGE LIGHTS, (TYPE TL1 AND TL2). EXTEND EXISTING TRACK CIRCUITING TO <u>PB</u> (ETC PIGTAIL PLUG BOXES). (ADD ALTERNATE #6).
- 2 REMOVE EXISTING UNISON DIMMING SYSTEM CONTROL PANEL AND REPLACE WITH A <u>ET</u> (ETC ECHO TOUCHSCREEN DMX CONTROLLER) WITH <u>GW</u> (ETC DMX GATEWAY). (BASE BID)
- 3 <u>DMX-R</u> (ETC DMX WIRELESS MULTIVERSE RECEIVER) PIPE RAIL MOUNTED. (ADD ALTERNATE #6).
- 4 <u>CONSOLE</u> (ETC COLORSOURCE 20 CONTROL CONSOLE) FOR CONTROL OF THE TYPE <u>TL1</u> AND <u>TL2</u> PIPE RAIL MOUNTED STAGE LIGHTS. (ADD ALTERNATE #6).
- 5 <u>DMX-T</u> (ETC MULTIVERSE SHOW BABY WIRELESS DMX TRANSMITTER) (ADD ALTERNATE #6).
- 6 <u>DI</u> AND <u>DO</u> (ETC DMX INPUT WALL PLATE AND DMX OUTPUT WITH AC ADAPTER) (ADD ALTERNATE #6).
- 7 REPLACE EXISTING DIMMER MODULES WITHIN DIMMER RACK CONTROLLING THE TRACK CIRCUITS TO BE CONNECTED TO THE NEW STAGE LIGHTS, WITH NEW <u>RELAY MODULES</u> R20AF. (ADD ALTERNATE #6).



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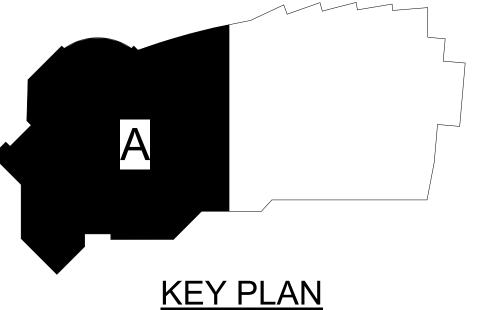
Owner

#### ALASKA NATIVE HERITAGE CENTER REMODEL

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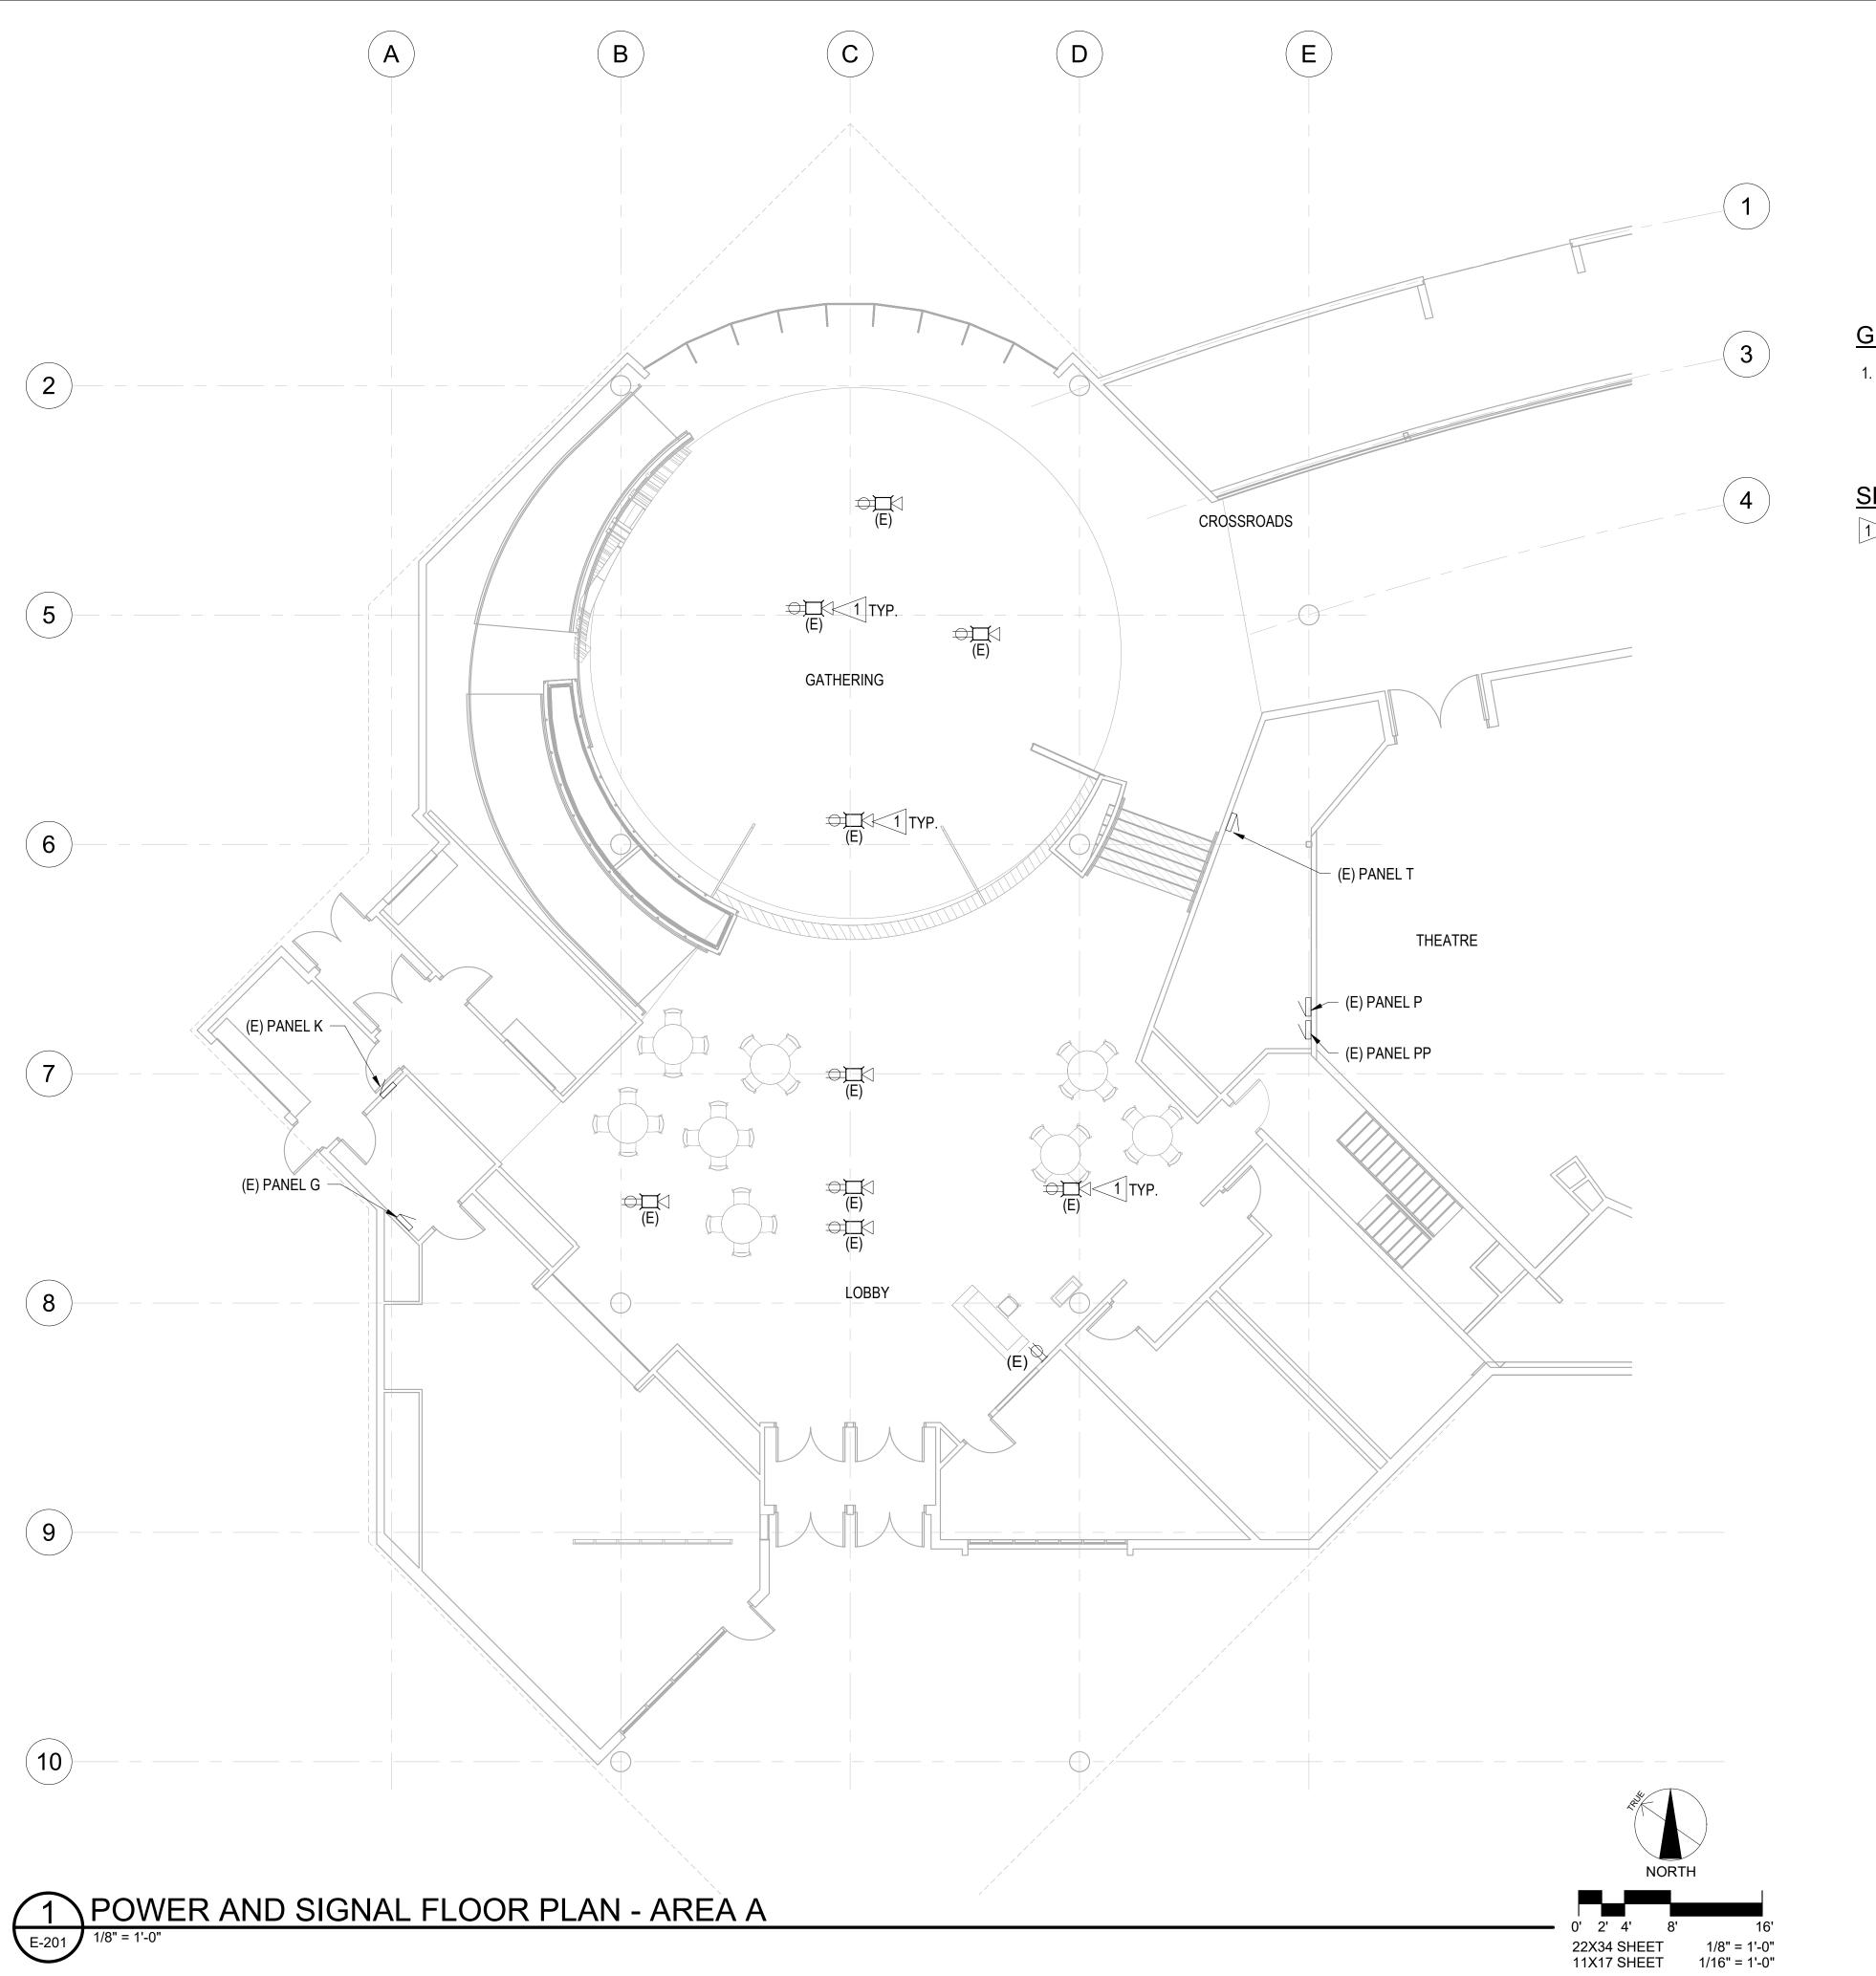
BID CONSTRUCTION DOCUMENTS

JOB NO.	231248
DATE:	10.15.2023
PROJ. MGR.:	DCN
DRAWN BY:	MAG
REVIEWED BY:	LRH
REVISIONS:	



DIMMING FLOOR PLAN -AREA A





## **GENERAL NOTES**

SPACE RESERVED FOR MOA PERMIT STAMP

DEVICES INDICATED WITH AN (E) ARE EXISTING TO REMAIN. CONTRACTOR TO MAINTAIN CIRCUITRY OF EXISTING DEVICES TO REMAIN BY EXTENDING WIRING AS REQUIRED FOR DEVICES REMOVED.

## SHEET NOTES

1 EXISTING RECESS FLOOR BOXES TO REMAIN. ADJUST FLOOR BOX OR PROVIDE EXTENSION RING AS REQUIRED FOR NEW FLOOR SURFACE.





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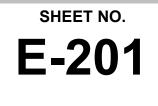
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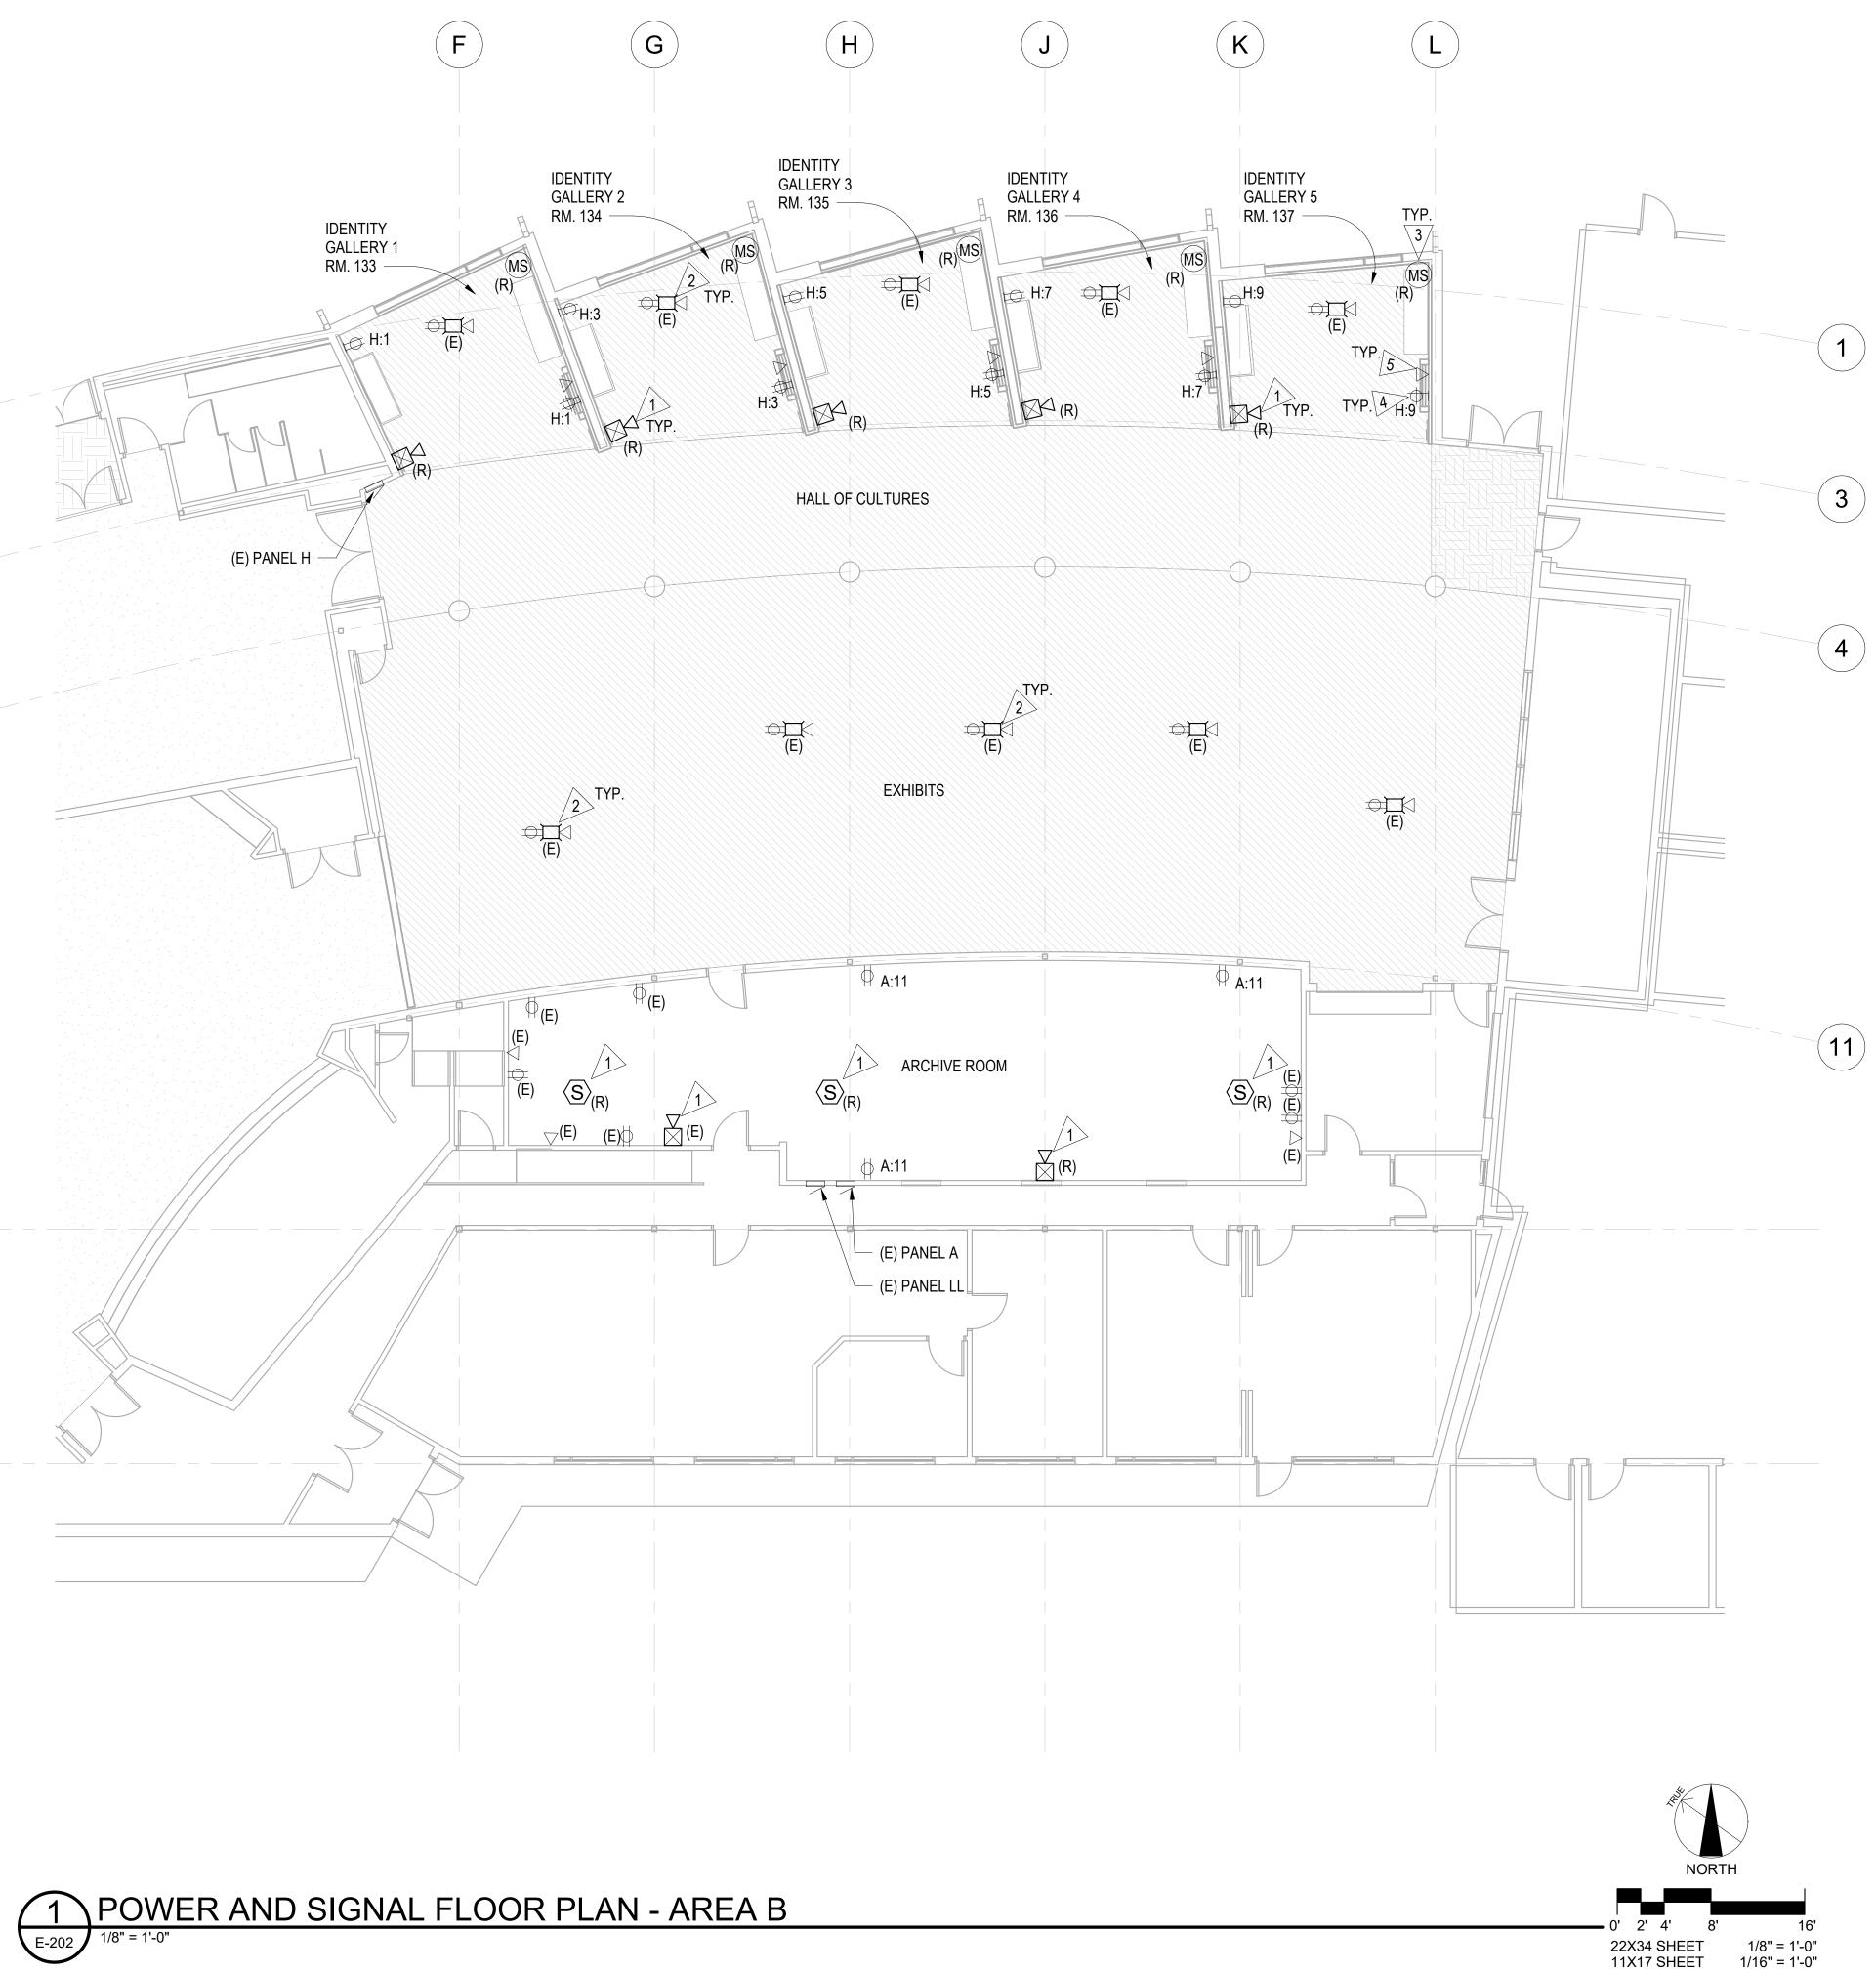
BID CONSTRUCTION DOCUMENTS


JOB NO.	231248
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#### POWER AND SIGNAL FLOOR PLAN - AREA A







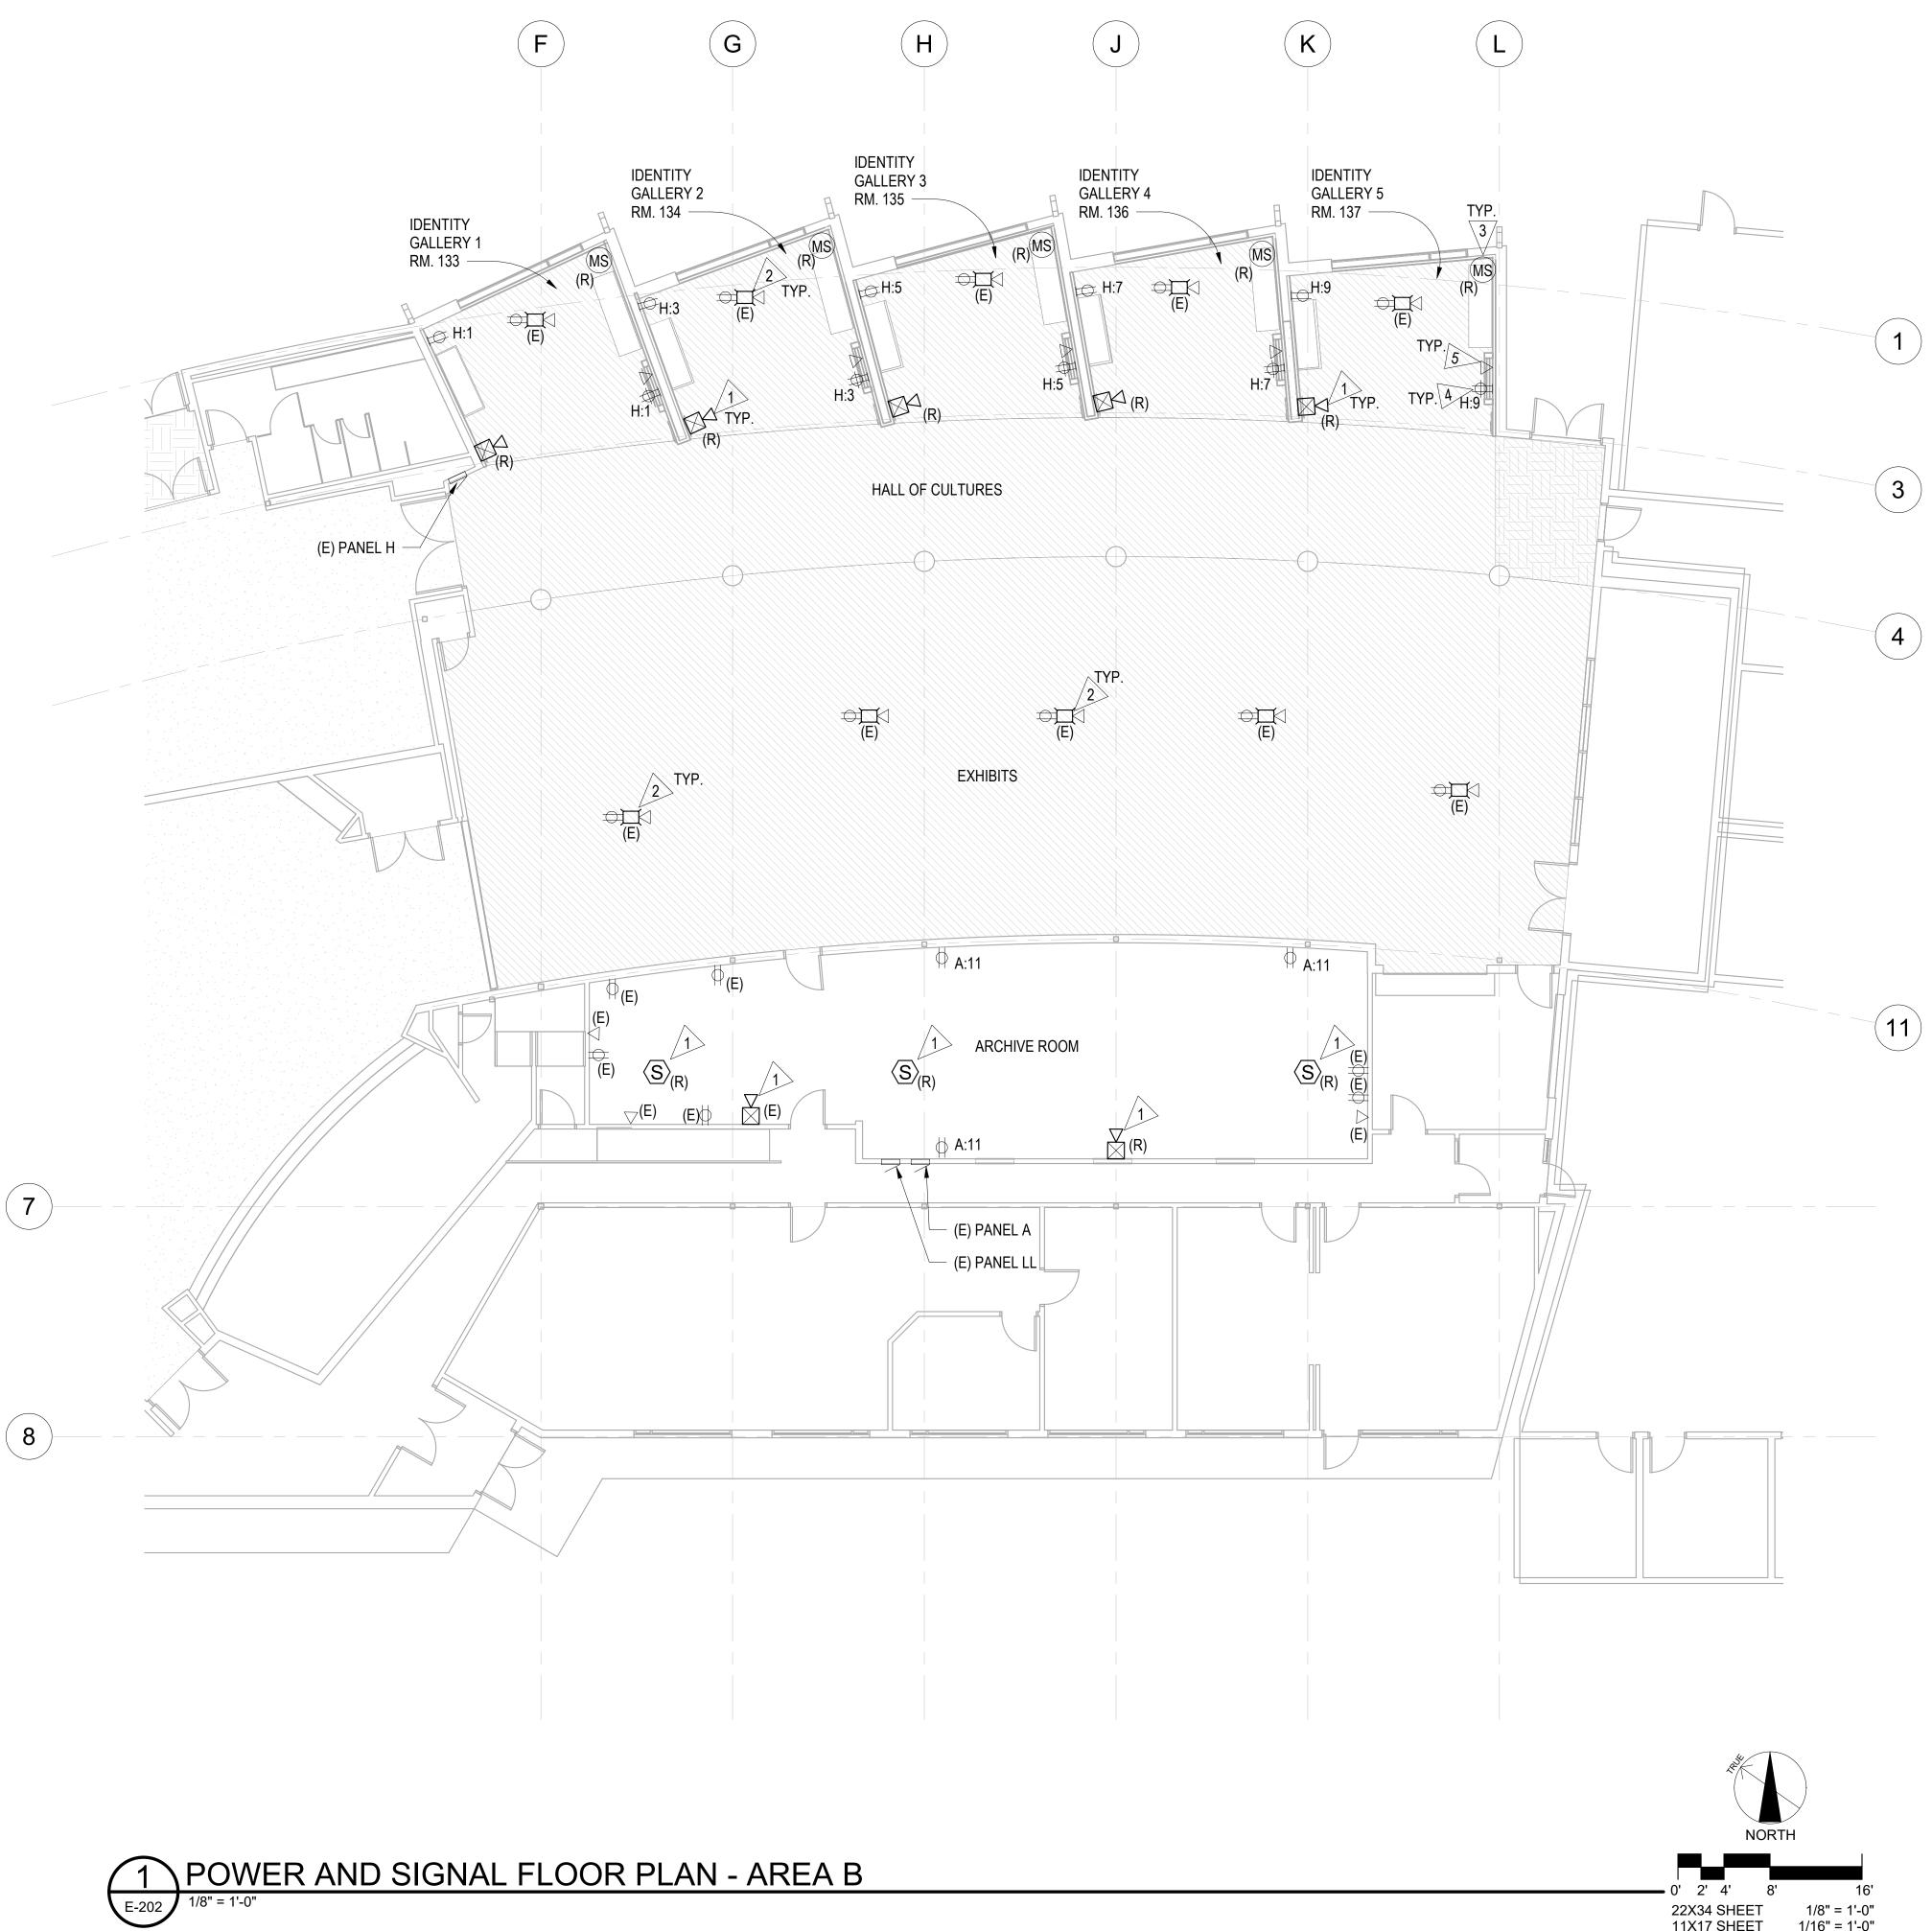

F O R: • SUBMITTAL PRICING


SPACE RESERVED FOR MOA PERMIT STAMP

#### **GENERAL NOTES**

- DEVICES INDICATED WITH AN "(R)" ARE TO BE RELOCATED. EXTEND CONDUIT AND WIRING AS REQUIRED FOR NEW LOCATION SHOWN.
- DEVICES INDICATED WITH AN (E) ARE EXISTING TO REMAIN AND SHOWN 2. FOR REFERENCE PURPOSES. CONTRACTOR TO MAINTAIN CIRCUITRY OF EXISTING DEVICES TO REMAIN BY EXTENDING WIRING AS REQUIRED FOR DEVICES REMOVED.

#### SHEET NOTES

- RELOCATE EXISTING FIRE ALARM DEVICES AS REQUIRED FOR WALL AND CEILING FINISH UPGRADES. PROVIDE EXTENSION BOXES AND EXTEND WIRING AS REQUIRED. COORDINATE LOCATION WITH SIGNAGE PRIOR TO INSTALL. EXISTING FIRE ALARM PANEL IS AN EDWARDS EST-3 AND IS LOCATED IN THE BASEMENT MECHANICAL SPACE. REFER TO SHEET E-203 FOR LOCATION.
- EXISTING RECESS FLOOR BOXES TO REMAIN. ADJUST FLOOR BOX OR 2> PROVIDE EXTENSION RING AS REQUIRED FOR NEW FLOOR SURFACE.
- 3> RELOCATE EXISTING WALL MOUNTED SECURITY SYSTEM MOTION SENSOR AS REQUIRED FOR WALL AND CEILING FINISH UPGRADES. PROVIDE EXTENSION BOXES AND EXTEND WIRING AS REQUIRED.
- 4 DOUBLE DUPLEX RECPTACLE MOUNTED AT 72" AFF. COORDINATE WITH FLAT SCREEN DISPLAY LOCATIONS.
- 5> CAT 6 TELECOM OUTLET MOUNTED AT 72" AFF WITH CAT 6 TELECOM CABLE TERMINATED AT PATCH PANEL IN EXISTING TELECOM RACK LOCATED IN THE BASEMENT MECHANICAL ROOM. COORINATE OUTLET LOCATION WITH FLAT SCREEN DISPLAY LOCATIONS.

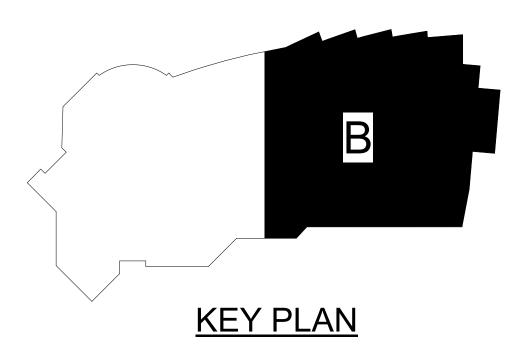

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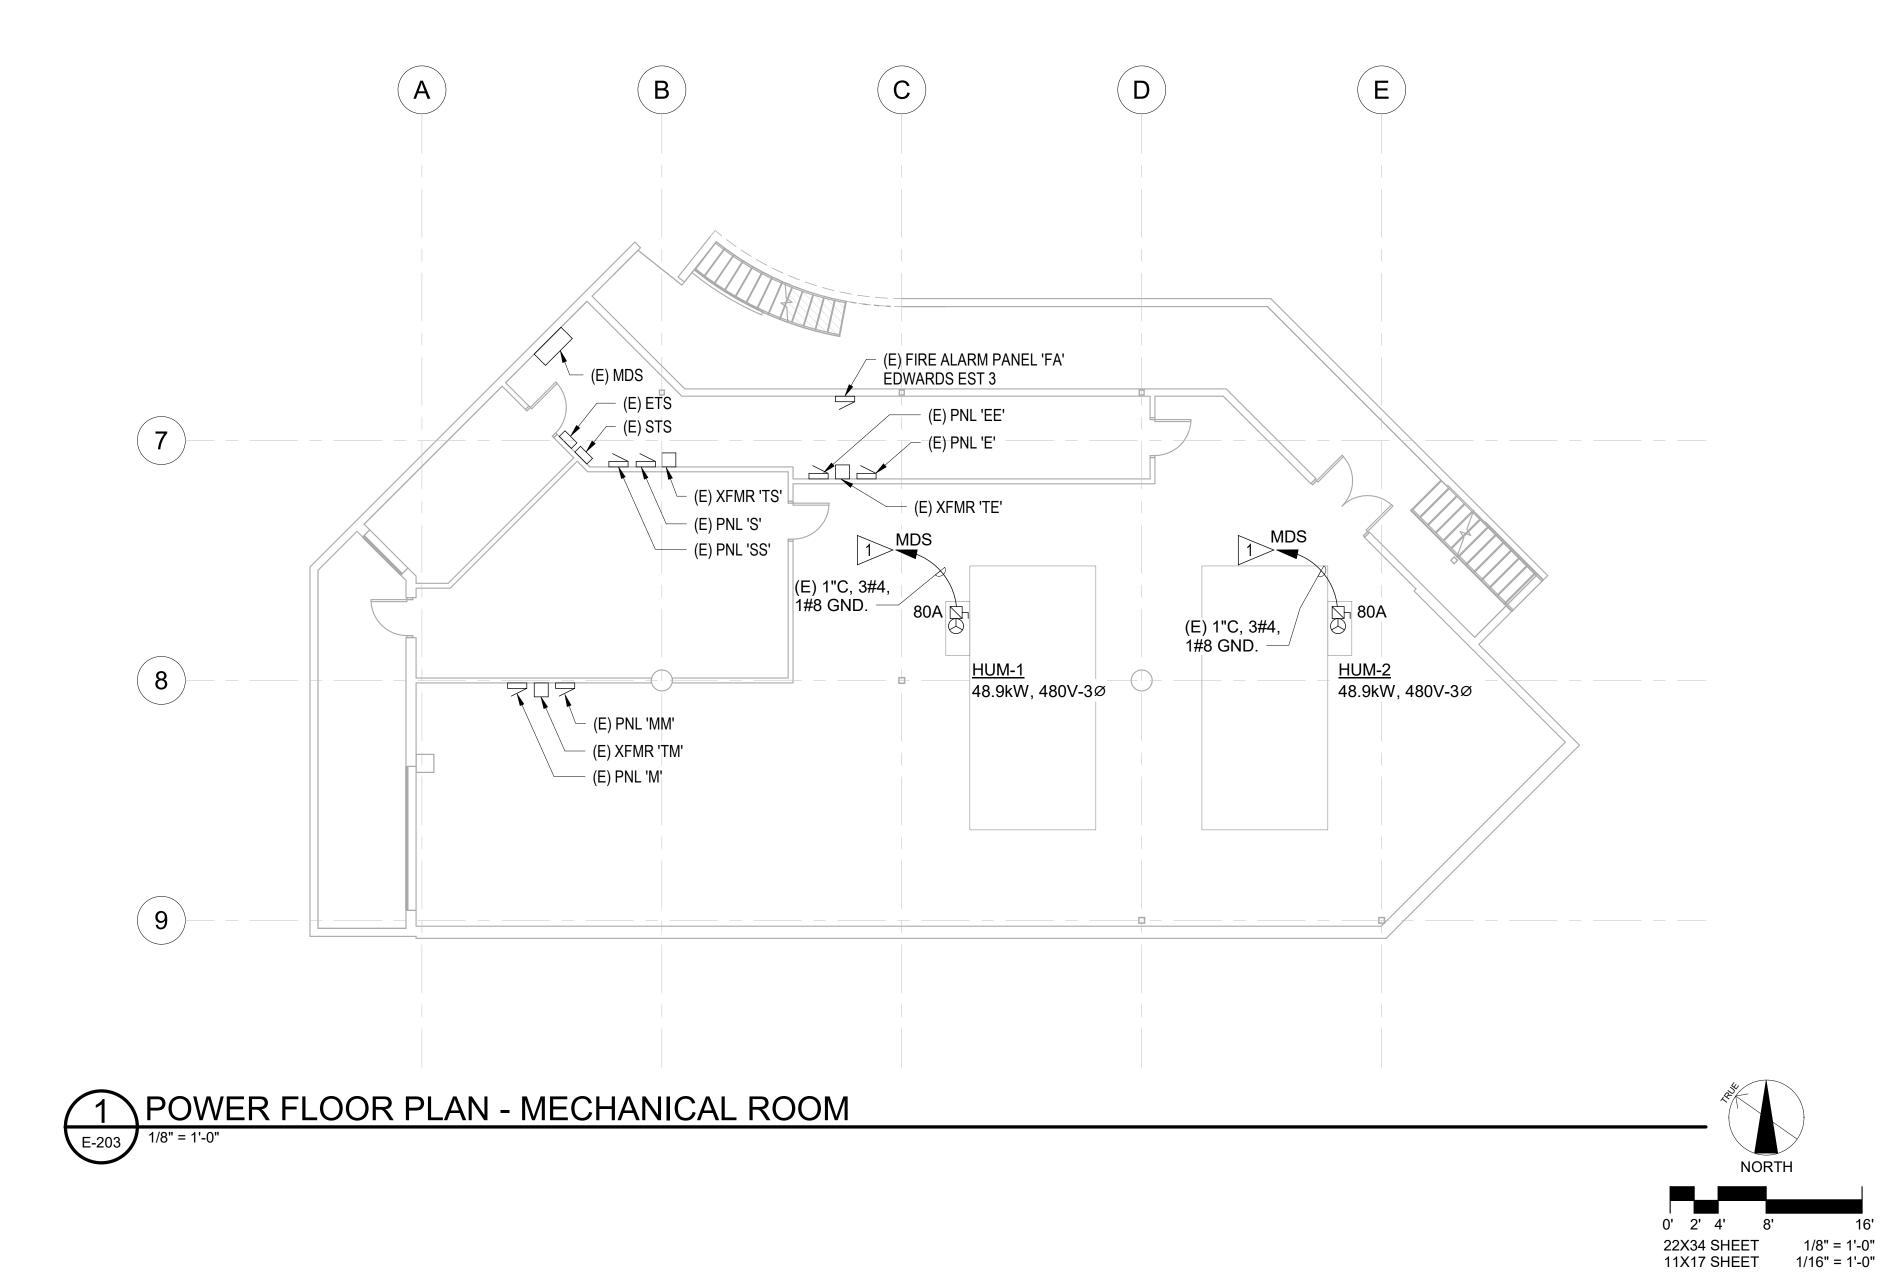
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## POWER AND SIGNAL FLOOR PLAN - AREA B







SPACE RESERVED FOR MOA PERMIT STAMP

## SHEET NOTES


.

DISCONNECT POWER FROM EXISTING HUMIDIFIERS TO BE REPLACED. PROVIDE NEW 100A, 600V HEAVY DUTY FUSED DISCONNECT WITH 80A FUSES AND RECONNECT EXISTING WIRING TO EXISTING 90A/3P CIRCUIT BREAKERS IN MAIN DISTRIBUTION SWITCHBOARD "MDS". EXTEND EXISTING CONDUIT AND WIRING AS REQUIRED. FIELD VERIFY EXISTING CONDUCTOR SIZE INDICATED ON RECORD DRAWINGS. F O R:SUBMITTALPRICING



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#### POWER FLOOR PLAN -MECHANICAL ROOM



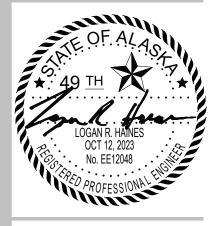

<u>KEY PLAN</u>

		E		G SYSTEM REPAIR SCHEDUL	E (B
ET	1	ETC	ETS-4	EchoTouch Controller, black	
	1	ETC	ETS-SBB	EchoTouch surface mount back box, black	
	1	ETC	PS435	24V DIN rail power supply	N
<u>GW</u>	2	ETC	RSN-DMX4-DIN	Response 4-port DIN rail DMX Gateway	P
	1	ETC	DIN28	Large DIN rail enclosure	

		S		HTING SCHEDULE (ADD ALTERI	N
Туре	QTY	Manufacturer	Model #	Description	
<u>TL1</u>	8	ETC	CSSPOTVMVS	ColorSource Spot V with Multiverse, with shutter barrel, black	s
	8	ETC	400CC	C-Clamp (included with fixture)	
	6	ETC	T1PJ-5	5ft TRUE1 jumper (included with fixture)	
	2	ETC	T1PA-A	5ft Edison plug to TRUE1	
	8	ETC	400SC	Safety Cable	
	8	ETC	419EDLT	19 degree Enhanced Definition lens	
PIPE1	2			1-1/2" diameter schedule 40 black pipe with 90 degree elbows and mounting plates	F
<u>TL2</u>	6	ETC	CSPAR	ColorSource Par, Black	s
	6	ETC	400CC	C-Clamp	
	6	ETC	400SC	Safety Cable	
	6	ETC	DPJ-10	10ft PowerCon to PowerCon Jumper	
	6	ETC	CD10-DMX	10ft DMX Cable	
	6	ETC	SELRM-7.5	Medium Round Diffuser	
<u>PIPE2</u>	2			1-1/2" diameter schedule 40 black pipe with 90 degree elbows and mounting plates	F
DMX-R	1	ETC	CSR-M	ColorSource Multiverse DMX Receiver	
	1	ETC	CSR-PMT	Pipe Mount Bracket	
	1	ETC	400CC	C-Clamp	
	1	ETC	DPA-A	PowerCon to Edison cable	
DMX-T	1	City Theatrical	5900	Multiverse SHoW Baby wireless DMX transmitter	
	1	ETC	CD5-DMX	5ft DMX Cable	
CONSOLE	1	ETC	CS20	ColorSource 20 control console	
	1	ETC	CS20DC	Dust cover	1
	1	ETC	CD25-DMX	25' DMX Cable	
<u>PB</u>	4	ETC	9101A	Single edison surface mount plug box	
DI	1	ETC	ECPB DMXIN	Single Gang DMX Input wall plate	
DO	1	ETC	ECPB DMX OUT/AC	Two Gang DMX Output with AC wallplate	F
RELAY MODULE	2	ETC	R20AF	20A Relay module for ETC Sensor dimmer rack	5

BASE BID)
Mount in DIN box and use to power ET and GW
Power supply listed above under ET
JATE #6)
Notes
stage spot light, DMX color changing LED, pipe rail mounted
Provide 10'-0" long sections with 12" offset from beam for TL1 fixture clearance.
stage par light, DMX color changing LED, pipe rail mounted
Provide 10'-0" long sections with 6" offset from beam for TL2 fixture clearance.
For DMX-T
Swap modules for track circuits to relay modules.

## **DIMMING SYSTEM NOTES**

- PROJECT WORK ASSOCIATED WITH THE REPAIR AND RESTORATION OF THE ETC DIMMING SYSTEM IS BASE BID.
- THIS WORK PER THE BID SCHEDULE.
- 2. SHALL BE BY ETC (ELECTRONIC THEATRE CONTROLS, INC.). ETC PART NUMBERS ARE REFERENCED ON THESE DRAWINGS.
- 3. UPGRADE OF THE SYSTEM INCLUDING SHOP DRAWINGS, PROGRAMMING, STARTUP AND TRAINING.
- 4 OF DEVICES AND ADDITIONAL INFORMATION.

#### ETC DIMMING SYSTEM CONTROLS REPAIR/RESTORATION:

THE EXISTING ETC UNISON CONTROL SYSTEM IS NO LONGER FUNCTIONING, AND IS NO LONGER REPAIRABLE. THE EXISTING DIMMER RACK FUNCTIONS FINE, AND SHOULD HAVE 5 +/- YEARS OF SERVICE LEFT. TO REGAIN TEMPORARY CONTROL OF THE ETC DIMMING SYSTEM AS IT WAS, USING THE SAME EXISTING DIMMED CIRCUITS, AN ETC ECHOTOUCH TOUCHSCREEN DMX CONTROLLER SHALL BE PROVIDED IN PLACE OF THE EXISTING ETC UNISON CONTROLLER. THE ETC ECHOTOUCH CAN MANUALLY ADJUST ALL DIMMER LEVELS IN THE SYSTEM, AS WELL AS RECORD AND PLAYBACK PRESETS, AND PERFORM BASIC SCHEDULING. THE ECHOTOUCH SHALLL BE LOCATED WHERE THE EXISTING ETC UNISON CURRENTLY IS LOCATED IN ROOM 159. THE ONLY EXISTING FUNCTIONAL CHANGE WILL BE THE LOSS OF THE REMOTELY MOUNTED TOUCHSCREENS IN OTHER AREAS OF THE MUSEUM. THESE SHALL BE REMOVED, BUT THE WIRING SHALL REMAIN FOR FUTURE USE.

A DMX SPLITTER/MERGER SHALL BE INSTALLED TO ARBITRATE DMX CONTROL BETWEEN THE ETC ECHOTOUCH AND THE EXISTING LIGHTING CONTROL BOARD FOR THE THEATER SPACE, SO THE EXISTING LIGHT BOARD CAN CONTINUE TO BE OPERATED THE SAME WAY IT WAS WITH THE OLD UNISON SYSTEM.

THE INTENT OF THESE DEVICES IS TO RESTORE CONTROL OF THE EXISTING DIMMER AND EXISTING DIMMED CIRCUITS/FIXTURES UNTIL A FULL OVERHAUL OF THE GALLERY SPACES HAPPENS IN THE FUTURE, AT WHICH POINT A MUCH MORE SUBSTANTIAL CONTROLS OVERHAUL WILL BE REQUIRED.


REFER TO THE ETC DIMMING SYSTEM REPAIR SCHEDULE FOR LIST OF MATERIAL ASSOCIATED WITH THIS SCOPE OF WORK.

#### GATHERING ROOM 102 STAGE LIGHTS (ADD ALTERNATE #6):

THE EXISTING TRACK LIGHTS IN THE GATHERING ROOM 102 AREA ARE INSUFFICIENT FOR THE USE OF THE SPACE. THE EXISTING TRACK LIGHTS SHALL BE REMOVED AT THE LOCATION OF THE NEW STAGE LIGHTS AND REPLACED WITH TYPICAL LIGHTING BARS USED FOR THE MOUNTING OF THEATRICAL LUMINAIRES. THE CIRCUITS FROM THE OLD TRACK SHALL BE REPURPOSED TO RELAY CONTROLLED PLUG BOXES FOR LED STAGE LIGHTING, EIGHT (TYPE TL1) DMX CONTROLLED COLOR CHANGING + WHITE LED THEATRE SPOT LIGHTS SHALL BE PROVIDED FOR FRONT LIGHTING OF THE STAGE. SIX (TYPE TL2) DMX CONTROLLED COLOR CHANGING + WHITE LED THEATRE PAR FIXTURES SHALL BE PROVIDED FOR BACK LIGHTING THE STAGE AREA. THESE FIXTURES SHALL BE INDIVIDUALLY CONTROLLABLE AND DIMMABLE, AND OF A SUFFICIENT BRIGHTNESS TO WORK WITH THE DAYLIGHT IN THE SPACE.

AN ETC COLORSOURCE 20 CONSOLE AND WIRELESS DMX TRANSMITTER SHALL BE PROVIDED TO CONTROL THE THEATRICAL STAGE LIGHTS.

REFER TO THE STAGE LIGHTING SCHEDULE FOR LIST OF MATERIAL ASSOCIATED WITH THIS SCOPE OF WORK.

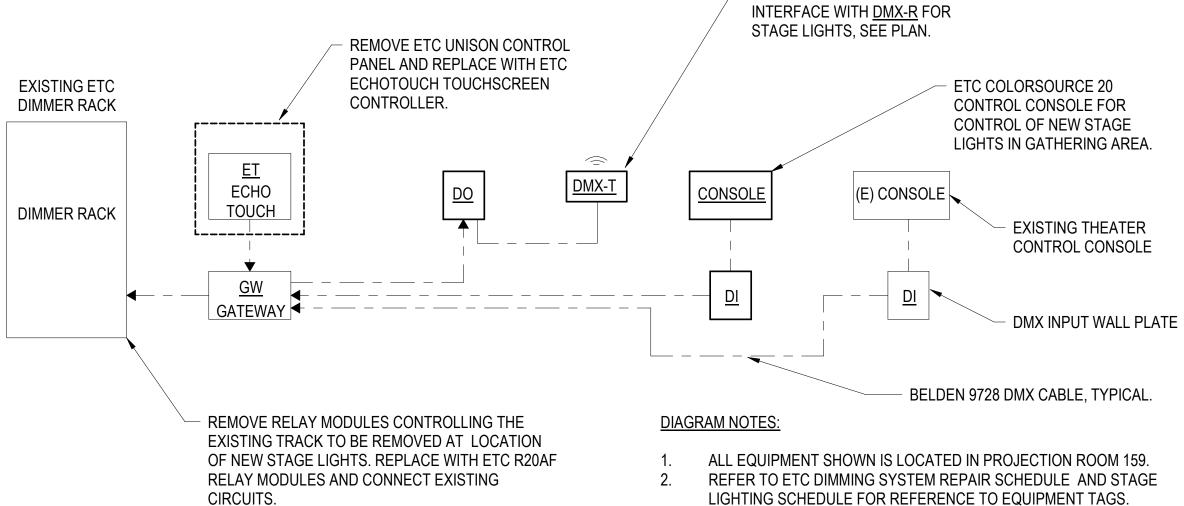



SPACE RESERVED FOR MOA PERMIT STAMP

INSTALLATION OF GATHERING ROOM STAGE LIGHTS IS ALTERNATE BID ITEM #6. CONTRACTOR SHALL PROVIDE A SEPERATE PRICE FOR

THE EXISTING DIMMING SYSTEM IS AN ETC DIMMING SYSTEM. ALL REPLACEMEMENT AND/OR UPGRADE DIMMING SYSTEM PRODUCTS

THESE PROJECT DRAWINGS INDICATE THE MAIN EQUIPMENT TO BE UPGRADED OR REPLACED BUT DO NOT PROVIDE A COMPLETE MATERIAL LIST. CONTRACTOR SHALL WORK DIRECTLY WITH ETC TECHNICAL SUPPORT TO PROVIDE A COMPLETE AND FUNCTIONAL

THE FOLLOWING NOTES DESCRIBE THE PROPOSED CHANGES TO THE ETC DIMMING SYSTEM. REFER TO SHEET E-103 FOR LOCATION

LIGHTING SCHEDULE FOR REFERENCE TO EQUIPMENT TAGS. REFER TO E-103 FOR FLOOR PLAN INDICATING LOCATION OF EQUIPMENT.


WIRELESS TRANSMITTER FOR



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#### DIMMING SYSTEM DIAGRAM AND SCHEDULE

SHEET NO.

E-501

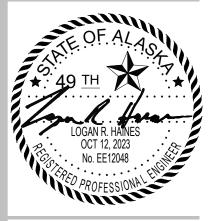	PANEL	EXISTING A						208/12	20V 3 P	HASE,	4 WIRE					MOUNTING: FLUSH, NEMA 1	
LOCATION		N HALLWAY 146	HALLWAY 146					225 AMP BUS MAIN LUGS ONLY						-		GRND BUS: EQUIPMENT	
	SPECIAL	FED FROM TRANSFORMER	TA	-												SHORT CKT: 10 kA SCCR	
С	NOTES	CIRCUIT	10	AD (AMF	25)	BKR	POLES	СКТ	BUS	СКТ	POLES	BKR	10	AD (AMI	PS)	CIRCUIT	NOTES C
Т		DESCRIPTION	A	B	<u>с,</u>	TRIP	. 0220	NO		NO	. 0220	TRIP	A	B	<u>с</u>	DESCRIPTION	
-		RECEPTS - CLASSROOM 152		_	_	20	1	1	Α	2	2	30				RECEPTS - ADMIN 145	3
1	1	IDENITY GALLERY DISPLAY LTG		1.0		20	1	3	В	4						RECEPTS - ADMIN 145	3
	2	SPARE				20	1	5	С	6	1	20				RECEPTS - ADMIN 145	3
	3	RECEPTS - OFFICE 143				20	1	7	Α	8	1	20				RECEPTS - LIBRARY 152	3
	3	RECEPTS - OFFICE 144				20	1	9	В	10	1	20				RECEPTS - ADMIN 145	3
2	1	RECEPTS, ARCHIVE			4.5	20	1	11	С	12	1	20				RECEPTS - ADMIN 145	3
	3	HALL LIGHTS AND RECEPTS				20	1	13	Α	14	1	20				RECEPTS - CLASSROOM 145	3
	3	RECEPTS, RECEIVING 137/CORR 148				20	1	15	В	16	1	20				RECEPTS - CLASSROOM 145	3
	3	DOOR OPERATOR - RECEIVING 139				20	1	17	С	18	1	20				RECEPTS - CLASSROOM 145	3
	3	RECEPTS, EXTERIOR				20	1	19	Α	20	1	20				RECEPTS - CLASSROOM 145	3
	3	RECEPTS, STAFF LOUNGE141 VENDING				20	1	21	В	22	1	20				RECEPTS - CLASSROOM 145	3
	3	RECEPTS, STAFF LOUNGE141 VENDING				20	1	23	С	24	1	20				RECEPTS - CLASSROOM 145	3
	3	RECEPTS, STAFF LOUNGE141 FRIDGE				20	1	25	Α	26	1	20				RECEPTS - CLASSROOM 145	3
	3	RECEPTS, STAFF LOUNGE141 MICRO				20	1	27	В	28	1	20				RECEPTS - ELDERS LOUNGE 142	3
	3	RECEPTS, STAFF 141 DISHWASHER				20	1	29	С	30	1	20				RECEPTS - STAFF LOUNGE 141	3
1	1	IDENITY GALLERY, RM 133 LTG				20	1	31	Α	32	1	20				RECEPTS - STAFF LOUNGE 141	3
1	1	IDENITY GALLERY, RM 134 LTG				20	1	33	В	34	1	20				RECEPT - ADMIN 145 COPIER	3
1	1	IDENITY GALLERY, RM 135 LTG				20	1	35	С	36	1	20				RECEPTS RESTROOM 152	3
1	1	IDENITY GALLERY, RM 136 LTG				20	1	37	Α	38	3	30				TVSS	3
1	1	IDENITY GALLERY, RM 137 LTG				20	1	39	В	40						11 11	
	3	LIGHTING ROOM 103				20	1	41	С	42						11 11	

	PANEL	EXISTING EE					_	480/27	77V, 3 P	HASE,	4 WIRE			_		MOUNTING: SURF
	LOCATION	ELECTRICAL ROOM					125 AMF	BUS		MAIN	LUGS O	NLY				GRND BUS: EQUI
	SPECIAL	FED FROM MDS VIA TRA	NSFER SV	VITCH E	ETS										_	SHORT CKT: 18 kA
С	NOTES	CIRCUIT	LO	AD (AN	IPS)	BKR	POLES	СКТ	BUS	СКТ	POLES	BKR	LO	ad (an	IPS)	CIRC
Т		DESCRIPTION	Α	В	С	TRIP		NO		NO		TRIP	Α	В	С	DESCR
	3	TVSS				100	3	1	Α	2	3	40				XFMR - TE
		" "						3	В	4						" "
		" "						5	С	6						" "
1	1	GATHERING RAMP WALL LIGHTS	0.3			20	1	7	Α	8	3	15				CLASSROOM ADDN -
		EM LTS ROOM 101				20	1	9	В	10						" "
1	1	LIGHTS IN HALL OF CULTURES 103			1.3	20	1	11	С	12						11 11
		SPARE				20	1	13	Α	14	1	20				SPARE
	3	EM LTS ROOM 129				20	1	15	В	16	1	20				" "
		SPARE				20	1	17	С	18	1	20				" "
		" "				20	1	19	Α	20	1	20				" "
		" "				20	1	21	В	22	1	20				" "
		н н				20	1	23	С	24	1	20				11 11
		" "				20	1	25	Α	26	1	20				11 11
		" "				20	1	27	В	28	1	20				11 11
		SPACE						29	С	30						SPACE

			LIGHI	FIXTURE SCHEDULE			
FIXT.		FIXTURE	FIXTURE	LAMP	FIXTURE		
ID.	FIXTURE DESCRIPTION	VOLTAGE	WATTS	ТҮРЕ	MOUNTING	MANUFACTURERS PART NO.	
LA	RETROFIT EXISTING RECESS CAN LIGHT WITH LED RETROFIT MODULE. REUSE EXISTING TRIM RING. 1% ELV DIMMING. REWIRE TO 120V AND NEW DIMMER SWITCH.	120	30W	3,188 LUMEN ARRAY LED, 3000K, 60,000 HOUR LIFE (L 92), 90 CRI	RECESSED	SPECTRUM INFINIUM NO. SGRTE6FX-40L-30HK-DS2W1 OR APPROVED EQUAL.	REWIRE FR SEE PLAN.
LB	REPLACE RECESS WALL MOUNTED ROUND FIXTURE WITH 7-3/8" DIAMETER ROUND LED FIXTURE WITH EYELID OPAL LENSE. ADA COMPLIANT. COLOR BLACK.	277	11W	565 LUMEN ARRAY LED, 3000K, 50,000 HOUR LIFE (L 70), 90 CRI	RECESSED	BEGA NO. 24152-K3-BLK OR APPROVED EQUAL.	PATCH WAL
LC	REPLACE PENDANT MOUNTED FIXTURE WITH NEW 9" WIDE, ASYMETRIC, PENDANT MOUNTED LED FIXTURE. COLOR BLACK. PROVIDE PENDANT MOUNT HARDWARE AS REQUIRED TO MOUNT FROM EXISTING OUTLET BOX ON CEILING.	277	32W	3068 LUMEN ARRAY LED, 3000K, 60,000 HOUR LIFE (L 92), 90 CRI	PENDANT MOUNTED	ELLIPTIPAR NO. S120-M28D-X-13-M-V0-0-930-00-VCSXX- OR APPROVED EQUAL.	REMOVE EX REQUIRED T AIM FIXTURI
LD	REPLACE WALL MOUNTED FIXTURE WITH NEW 16" WIDE, WALL MOUNTED LED ASYMETRIC FIXTURE. COLOR WHITE.	277	32W	3,578 LUMEN ARRAY LED, 3000K, 60,000 HOUR LIFE (L 92), 90 CRI	WALL BRACKET MOUNTED	ELLIPTIPAR NO. S120-M56S-E-02-M-VO-0-930-00 OR APPROVED EQUAL.	ADJUST AIM
LF	LED 2X4 TROFFER WITH VOLUMETRIC LENS.	277	22W	3,276 LUMEN ARRAY LED, 3500K, 60,000 HOUR LIFE (L 92), 90 CRI	RECESSED	LITHONIA NO. 2BLT4-30L-ADSM-MVOLT-GZ10-LP835-N100 OR APPROVED EQUAL.	
LG	SUSPENDED LED FIXTURE RING WITH WHITE OPAL DIFFUSER. 10' DIMETER, 8" HIGH, SUSPENDED BY 3/64" STAINLESS STEEL AIRCRAFT CABLE. FIXTURE INNER AND OUTER RING COVERED WITH 3FORM VARIA ECORESIN.	120	230W	11,000 LUMEN ARRAY LED, 3000K, 50,000 HOUR LIFE (L 70), 80 CRI	SUSPENDED	LIGHTART LA2-CON-RING-10D-8H-XX-830CK-STD-STM-WPC-WH OR APPROVED EQUAL.	SUSPEND A
LH	PENDANT MOUNTED CYLINDRICAL LAMPSHADE WITH CABLE SET AND E28 LIGHT SOCKET FOR LED LAMP. SEAL SKIN LAMPSHADE AND DECORATIVE SOCKET ASSEMBLIES ARE SEPARATE ITEMS TO BE COMBINED INTO A SINGLE FIXTURE ASSEMBLY.	120	9W	900 LUMEN A19 LED BULB, 3000K, 90 CRI	PENDANT MOUNTED	GREAT GREENLAND LAMPSHADE W. SEALSKIN, BIG 43X32 (LAMP SHADE), AND SPECTRUM NO. DSP4INC-MB-CM72-BC-R51- MB-A19C-60W OR APPROVED EQUAL.	CONTRACT - THE LAMP S ABOVE REC

|--|

THE NOTES BELOW APPLY TO THE "NOTES" COLUMN IN THE EXISTING PANEL SCHEDULES:

- NEW LOAD INDICATED, REUSE EXISTING CIRCUIT BREAKER. 1.
- 2. AT TIME OF SITE INVESTIGATION, THE BREAKER WAS LABELED AS SPARE BUT WAS IN THE "ON" POSITION.
- 3. EXISTING LOAD AND CIRCUIT BREAKER (NO WORK). EXISTING LOAD NOT INDICATED.
- 4. EXISTING LOAD REMOVED. TURN INTO SPARE.

#### **GENERAL NOTES**

1. THE WORK DESCRIBED IN THIS PROJECT WILL RESULT IN A NET LOAD REDUCTION. ALL REPLACEMENT LIGHT FIXTURES ARE LED AND REPRESENT A SIGNIFICANT REDUCTION IN LOAD. THE EXISTING ELECTRICAL SERVICE REMAINS ADEQUATE AND DOES NOT REQUIRE AN UPGRADE FROM THIS PROJECT WORK.

TING: SURFACE, NEMA 1				PANEL	EXISTING H						208/12	20V 3 PH	HASE, 4	4 WIRE	
BUS: EQUIPMENT				LOCATION	<b>ROOM 132</b>					225 AMP	BUS		MAIN	LUGS ON	<b>NLY</b>
CKT: 18 kA SCCR				SPECIAL	FED FROM TRANSFORMER	R TH	-								
CIRCUIT	NOTES	С	С	NOTES	CIRCUIT	LO	ad (Am	PS)	BKR	POLES	СКТ	BUS	СКТ	POLES	BK
DESCRIPTION		T	Т		DESCRIPTION	Α	В	С	TRIP		NO		NO		TRI
TE	3		2	1	IDENITY GALLERY, RM. 133 RECEPTS	6.0			20	1	1	Α	2	1	20
			2	1	IDENITY GALLERY, 134 RECEPTS		6.0		20	1	3	В	4	1	20
			2	1	IDENITY GALLERY, 135 RECEPTS			6.0	20	1	5	С	6	1	20
OOM ADDN - EM LTS EXT/INT	3		2	1	IDENITY GALLERY, 136 RECEPTS	6.0			20	1	7	Α	8	1	20
			2	1	IDENITY GALLERY, 137 RECEPTS		6.0		20	1	9	В	10	1	20
				3	RESTRMS 128 131 EXT RECEPT				20	1	11	С	12	1	20
				3	CROSSROADS 130 RECEPT				20	1	13	Α	14	1	20
				3	EXHIBIT HALL 103 RECEPT				20	1	15	В	16	1	20
				3	VEND MACHINE				20	1	17	С	18	3	20
				3	BEVRIOSK				20	1	19	Α	20		
				3	BEVERAGE				30	2	21	В	22		
				3	COFFEE						23	С	24	1	20
				3	TRACK LIGHTS - CROSSROADS				20	1	25	Α	26	3	30
				3	TRACK LIGHTS - ROOM 130				20	1	27	В	28		
				3	TRACK LIGHTS - ROOM 130				20	1	29	С	30		

## 

SPACE RESERVED FOR MOA PERMIT STAMP

		_		MOUNTING:	FLUSH, NEMA 1		
LY			_	GRND BUS:	EQUIPMENT		
				SHORT CKT:	10 kA SCCR		
BKR	LO	AD (AM	PS)		CIRCUIT	NOTES	C
TRIP	Α	В	С	D	ESCRIPTION		T
20				EXHIBIT HALL	103 - FLR RECEPT	3	
20				EXHIBIT HALL	103 - FLR RECEPT	3	
20				EXHIBIT HALL	103 - FLR RECEPT	3	
20				EXHIBIT HALL	103 - FLR RECEPT	3	
20				EXHIBIT HALL	103 - FLR RECEPT	3	
20				STUDIO RM 13	3 & 134 FLR RECEPTS	3	
20				STUDIO RM 13	5 & 136 FLR RECEPTS	3	
20				STUDIO RM 13	7 FLR RECEPT	3	
20				VEND MACHIN	E	3	
				" "			
				" "			
20				EXHIBIT HALL	DOOR	3	
30				TVSS		3	
				" "			

#### REMARKS

FROM 277V TO 120V AND PROVIDE NEW DIMMER SWITCH CONTROL.

WALL AS REQUIRED FOR NEW INSTALLATION.

E EXISTING FIXTURE AND REMOTE BALLAST AND EXTEND WIRING AS ED TO NEW FIXTURE. PROVIDE PENDANT STEMS TO MATCH EXISTING. TURE TO ILLUMINATE CEILING SURFACE AT COLUMN.

AIMING TO PROVIDE EVEN ILLUMINATION ON CEILING SURFACE.

ID AT 10'. COLOR BY ARCHITECT. EACH FIXTURE IS A UNIQUE COLOR.

ACTOR TO PROVIDE HARDWARE ACCESSORIES REQUIRED TO MOUNT IP SHADE TO THE DECORATIVE SOCKET ASSEMBLY. SUSPEND AT 10' RECEPTION COUNTER.


F O R: • SUBMITTAL

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421 West 1<sup>st</sup> Avenue, Suite 300 Anchorage, Alaska 99501 907.563.8474 | F 907.563.4572 exploredesign.com





Owner
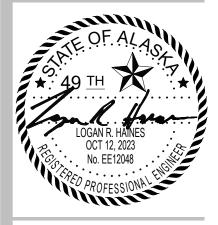
#### ALASKA NATIVE HERITAGE CENTER REMODEL

8800 Heritage Center Drive, Anchorage, Alaska

**BID CONSTRUCTION** DOCUMENTS

JOB NO.	231248
DATE:	10.15.2023
PROJ. MGR.:	DCN
DRAWN BY:	MAG
REVIEWED BY:	LRH
REVISIONS:	

#### SCHEDULES

SHEET NO.

E-601

1.

PANEL	EXISTING PP				48	80/277\	/, 3 PHA	SE, 4 V	VIRE			MOUNTIN	G: SURFACE, NEMA 1		P	ANEL	EXISTING LL					80/277	V, 3 PHAS	E, 4 WIF	RE			MOUNTING:	FLUSH, NEMA 1	
LOCATION	<b>ROOM 159</b>			12	5 AMP BI	US	М	AIN LU	JGS ONLY	1		GRND BU	S: EQUIPMENT		LOC	ATION	HALLWAY 146				125 AMP E	BUS	МА	IN LUG	S ONLY			GRND BUS:	EQUIPMENT	
SPECIAL	FED FROM MDS											SHORT CI	T: 18 kA SCCR		SP	ECIAL	FED FROM MDS									-		SHORT CKT:	18 kA SCCR	
NOTES	CIRCUIT	LOAD (AMPS			LESC				OLES B		LOAD (AMPS)		CIRCUIT	NOTES C	C NO	DTES	CIRCUIT	LC	DAD (AMPS)		R POLES		BUS CK		ES BKR		(AMPS)		CIRCUIT	NOTES
	DESCRIPTION	A B	C TF		N	10	N	10		RIP A	A B C		DESCRIPTION	Т	T		DESCRIPTION	Α	B	C TRIF		NO	N	0	TRIP	A	з С		DESCRIPTION	
	GHTS GIFT SHOP KITCHEN			20	1	1	Α	2	1 2			SPARE					IGHTING - S.E. CORNER (F-L 6-8)			20	1		A 2	1	20			SPARE		
	PARE			20	1	3	В	4	1 2			" "			1		IGHTS IN HALL OF CULTURES 103		1.5	20	1	•	B 4	. 1	20			" "		
	NTRANCE 101 COLUMN UPLIGHTS	1		20	1	5	С	6	1 2			" "				2 SI	PARE			20	1	5	C 6	<u> </u>	20			" "		
	JBLIC RESTROOMS PROI BOOTH			20	1	7	Α	8	1 2							"	n			20	1	7	A 8	1	20			" "		
	PARE			20	1	9	B '	0	1 2			" "					И			20	1	9	B 10	<b>)</b> 1	20			" "		
	11		2	20	1 '	11	C '	2	1 2	20		" "				SI	PACE					11	C 12	2				SPACE		
SF	PACE					13	A '	4				SPACE				"	И					13	A 14	4				" "		
"	11					15	B	6								"	И					15	B 16	6				" "		
"	Π					17	C '	8				" "				"	п					17	C 18	3				" "		
"	II					19	A 2	20				" "				"	"					19	A 20	0				" "		
"	n					21	B	22				" "				"	"					21	B 22	2				" "		
"	II					23	C	24	1 3	0		SPARE		2		"	"					23	C 24	4				" "		
"	n					25	A 2	26	3 3	0		TVSS		3		"	"					25	A 26	63	3 30			TVSS		3
"	I					27	B	28				" "				"	"					27	B 28	3				" "		
"	II					29	С ;	30								"	II.					29	C 30	)						
PANEL	EXISTING S				20	08/120\	/ 3 PHA	SE, 4 W	/IRE			MOUNTIN	G: SURFACE, NEMA 1		P	ANEL	EXISTING SS					180/277	V, 3 PHAS	E, 4 WIF	RE			MOUNTING:	SURFACE, NEMA 1	
LOCATION	ELECTRICAL ROOM			 	5 AMP BI			•	P MAIN BR				S: EQUIPMENT			CATION	ELETRICAL ROOM					nie	МА	IN LUG				GRND BUS:	EQUIPMENT	

PANEL	EXISTING S	208/120\	/ 3 PHASE, 4 WIRE	MOUNTING: SURFACE, NEMA 1		PANEL	EXISTING SS			480/27	7V, 3 PHA	SE, 4 WIRE		MOUNTING: SURFACE, NEMA 1	
LOCATION	N ELECTRICAL ROOM	225 AMP BUS	150 AMP MAIN BREAKER	GRND BUS: EQUIPMENT		LOCATION	ELETRICAL ROOM		250 A	MP BUS	Ν	AIN LUGS ONLY		GRND BUS: EQUIPMENT	
SPECIAL				SHORT CKT: 10 kA SCCR		SPECIAL	FED FROM MDS VIA	TRANSFER SWITCH STS						SHORT CKT: 18 kA SCCR	
C NOTES	CIRCUIT	LOAD (AMPS) BKR POLES CKT E	BUS CKT POLES BKR LOAD (AMPS)	CIRCUIT	NOTES C	C NOTES	CIRCUIT	LOAD (AMPS)	BKR POLE	ES CKT	BUS C	KT POLES BKR	LOAD (AMPS)	CIRCUIT	NOTES C
T	DESCRIPTION	A B C TRIP NO	NO TRIP A B C	DESCRIPTION	Т	Т	DESCRIPTION	A B C	TRIP	NO		NO TRIP	A B C	DESCRIPTION	T
3	TELECOM OUTLETS TTB-M	20 1 <b>1</b>	A 2 2 20	PUMP #7	3	3 T	VSS		100 3	1	Α	2 1 20		SPARE	4
3	TELECOM OUTLETS TTB-M	20 1 3	B 4	" "	3	"	И			3	В	<b>4</b> 1 20		ROOMS 129, 131, 161, 163, 164	3
3	TELECOM OUTLETS TTB-M	15 1 <b>5</b>	<b>C</b> 6 2 20	PUMP #8	3	"	П			5	С	<b>6</b> 1 20		ADMINISTRATION AREA	3
3	TELECOM OUTLETS TTB-M	30 1 7	A 8	" "	3	3 P	UMPS 2 & 2A		15 3	7	Α	8 1 20	1.0	LIGHTING, ARCHIVE	1 1
3	TELECOM OUTLETS TTB-S	30 1 9	<b>B</b> 10 1 20	BOILER #1	3	"	П			9	В	<b>10</b> 1 20		MECHANICAL, ELECTRICAL AREA	
3	UH	20 1 <b>11</b>	C 12 1 20	BOILER #2	3	"	И			11	С	<b>12</b> 3 15		SPARE	
3	BOILER CONTROL	20 1 13	A 14 1 20	MECHANICAL CONTROL	3	3 P	UMP 111		15 3	13	Α	14		п п	
3	CUH'S AND UH'S	20 1 15	B 16 1 20	LIGHTS GIFT SHOP	3	"	И			15	В	16		11 11	
3	PROJECTION 159 RECEP	20 1 17	C 18 1 20	PUMP-15	3	"	П			17	С	<b>18</b> 3 15		SPARE	
3	DOOR HOLDERS THEATRE	20 1 19	A 20 1 20	DAY TANK	3	3 A	HU-3		15 3	19	Α	20		11 11	
2	SPARE	20 1 21	<b>B</b> 22 1 20	DAY TANK	3	"	II			21	В	22		"	
2	SPARE	20 1 23	<b>C 24</b> 1 20	GEN. ROOM RECEP	3	"	"			23	С	24		SPACE	
3	INFO. 164 RECEP	20 1 25	A 26 1 20	GEN. BATTERY CHARGER	3	3 P.	ANEL MM		100 3	25	Α	26		11 11	
3	AIR COMPRESSOR	20 1 27	B 28 1 20	CUH MAIN ENTRANCE	3	"	"			27	В	28		"	
2	SPARE	20 1 29	<b>C</b> 30 1 20 0.3	LOBBY RECEPTION DESK LIGHTS	1 1	"	"			29	С	30		11 11	
3	COMM RACK RECEP	20 1 31	A 32 1 20 6.0	LOBBY/GATHERING CAN LIGHTS	1 1	S	PACE			31	Α	32		11 11	
3	COMM RACK RECEP	30 2 33	B 34 1 20 4.0	LOBBY/GATHERING CAN LIGHTS	1 1	"	"			33	В	<b>34</b> 2 30		FEEDS PANEL SA CLASSROOM ADDN	3
	" "	35	<b>C</b> 36 1 20	SPARE	2	"	11			35	С	36		11 11	
3	TVSS	100 3 37	A 38 1 20	SPARE	2	"	"			37	Α	<b>38</b> 3 125		TRANSFORMER TS	3
	"	39	<b>B</b> 40 1 20	SPARE	2	"	"			39	В	40		11 11	
	и и	41	C 42	SPACE		"	"			41	С	42		"	

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SPACE RESERVED FOR MOA PERMIT STAMP

**MCG** EXPLORE DESIGN


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Owner

#### ALASKA NATIVE HERITAGE CENTER REMODEL


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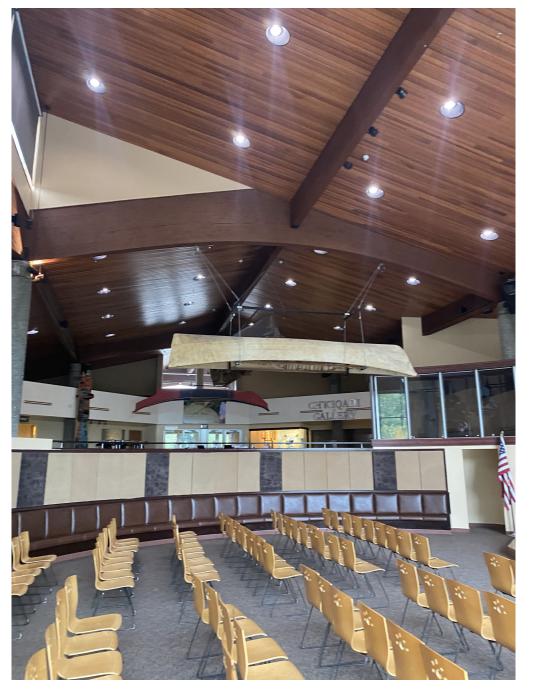
#### SCHEDULES





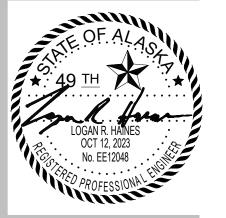




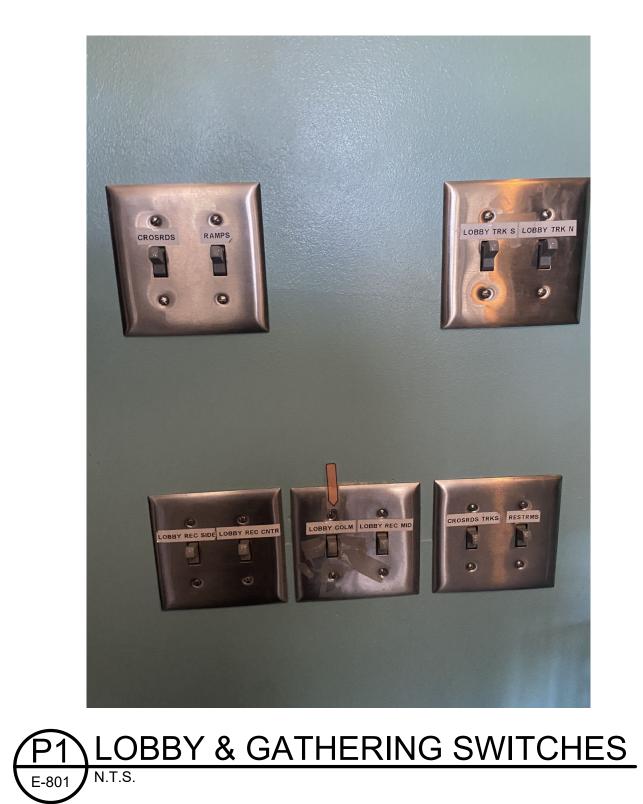








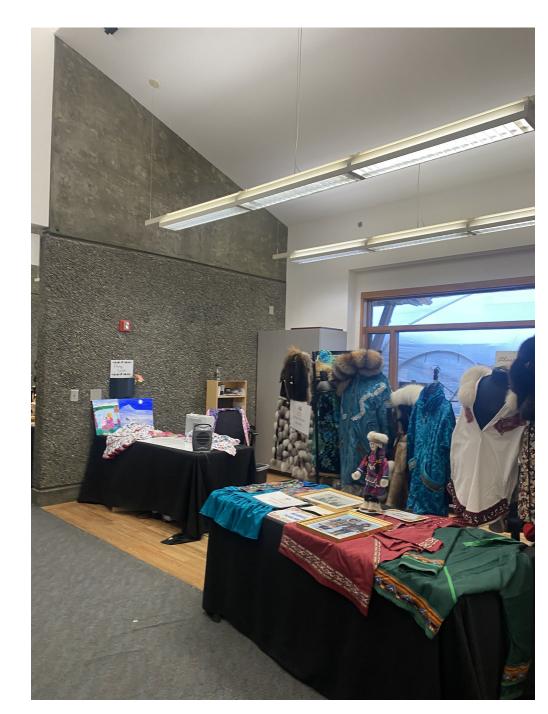



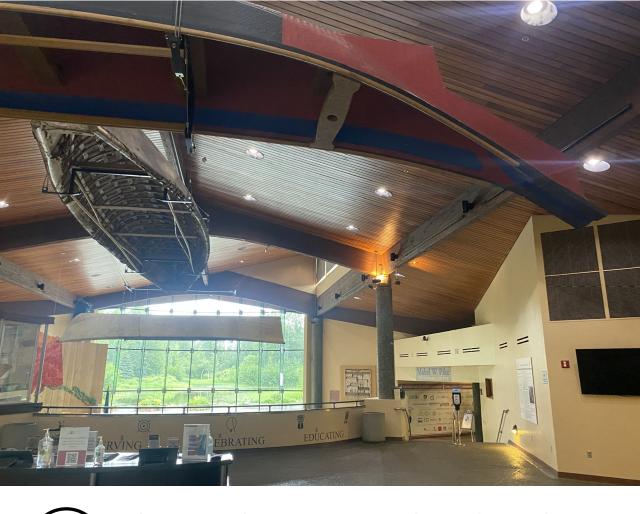












# P4 RAMP WALL LIGHTS E-801 N.T.S.

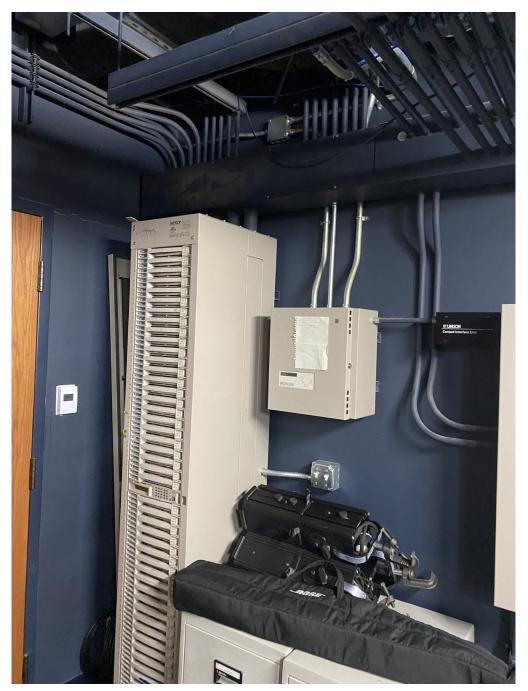

P8 UNISON CABINET

**MCG** EXPLORE DESIGN 421 West 1<sup>st</sup> Avenue, Suite 300 Anchorage, Alaska 99501 907.563.8474 | F 907.563.4572 exploredesign.com COFFFMAN ENGINEERS 800 F Street Anchorage, AK 99501 ph 907.276.6664

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ALASKA NATIVE HERITAGE CENTER REMODEL

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LRH

10.15.2023

EXISTING CONDITIONS PHOTOS

